

DESIGNED BY: MHL
 DRAWN BY: BPD
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 PROJECT: 21502.10

UNIVERSITY OF NEW ENGLAND
 PORTLAND CAMPUS
 STEVENS AVENUE ARMORY
 716 STEVENS AVE
 PORTLAND, MAINE 04103
 (707) 285-0171


RENOVATIONS TO THE
 STEVENS AVENUE ARMORY

SECOND FLOOR
 LIGHTING
 PLAN

SCALE: AS NOTED
 DATE: 05-24-16

DWG. EL102

SHEET: 161 OF 169

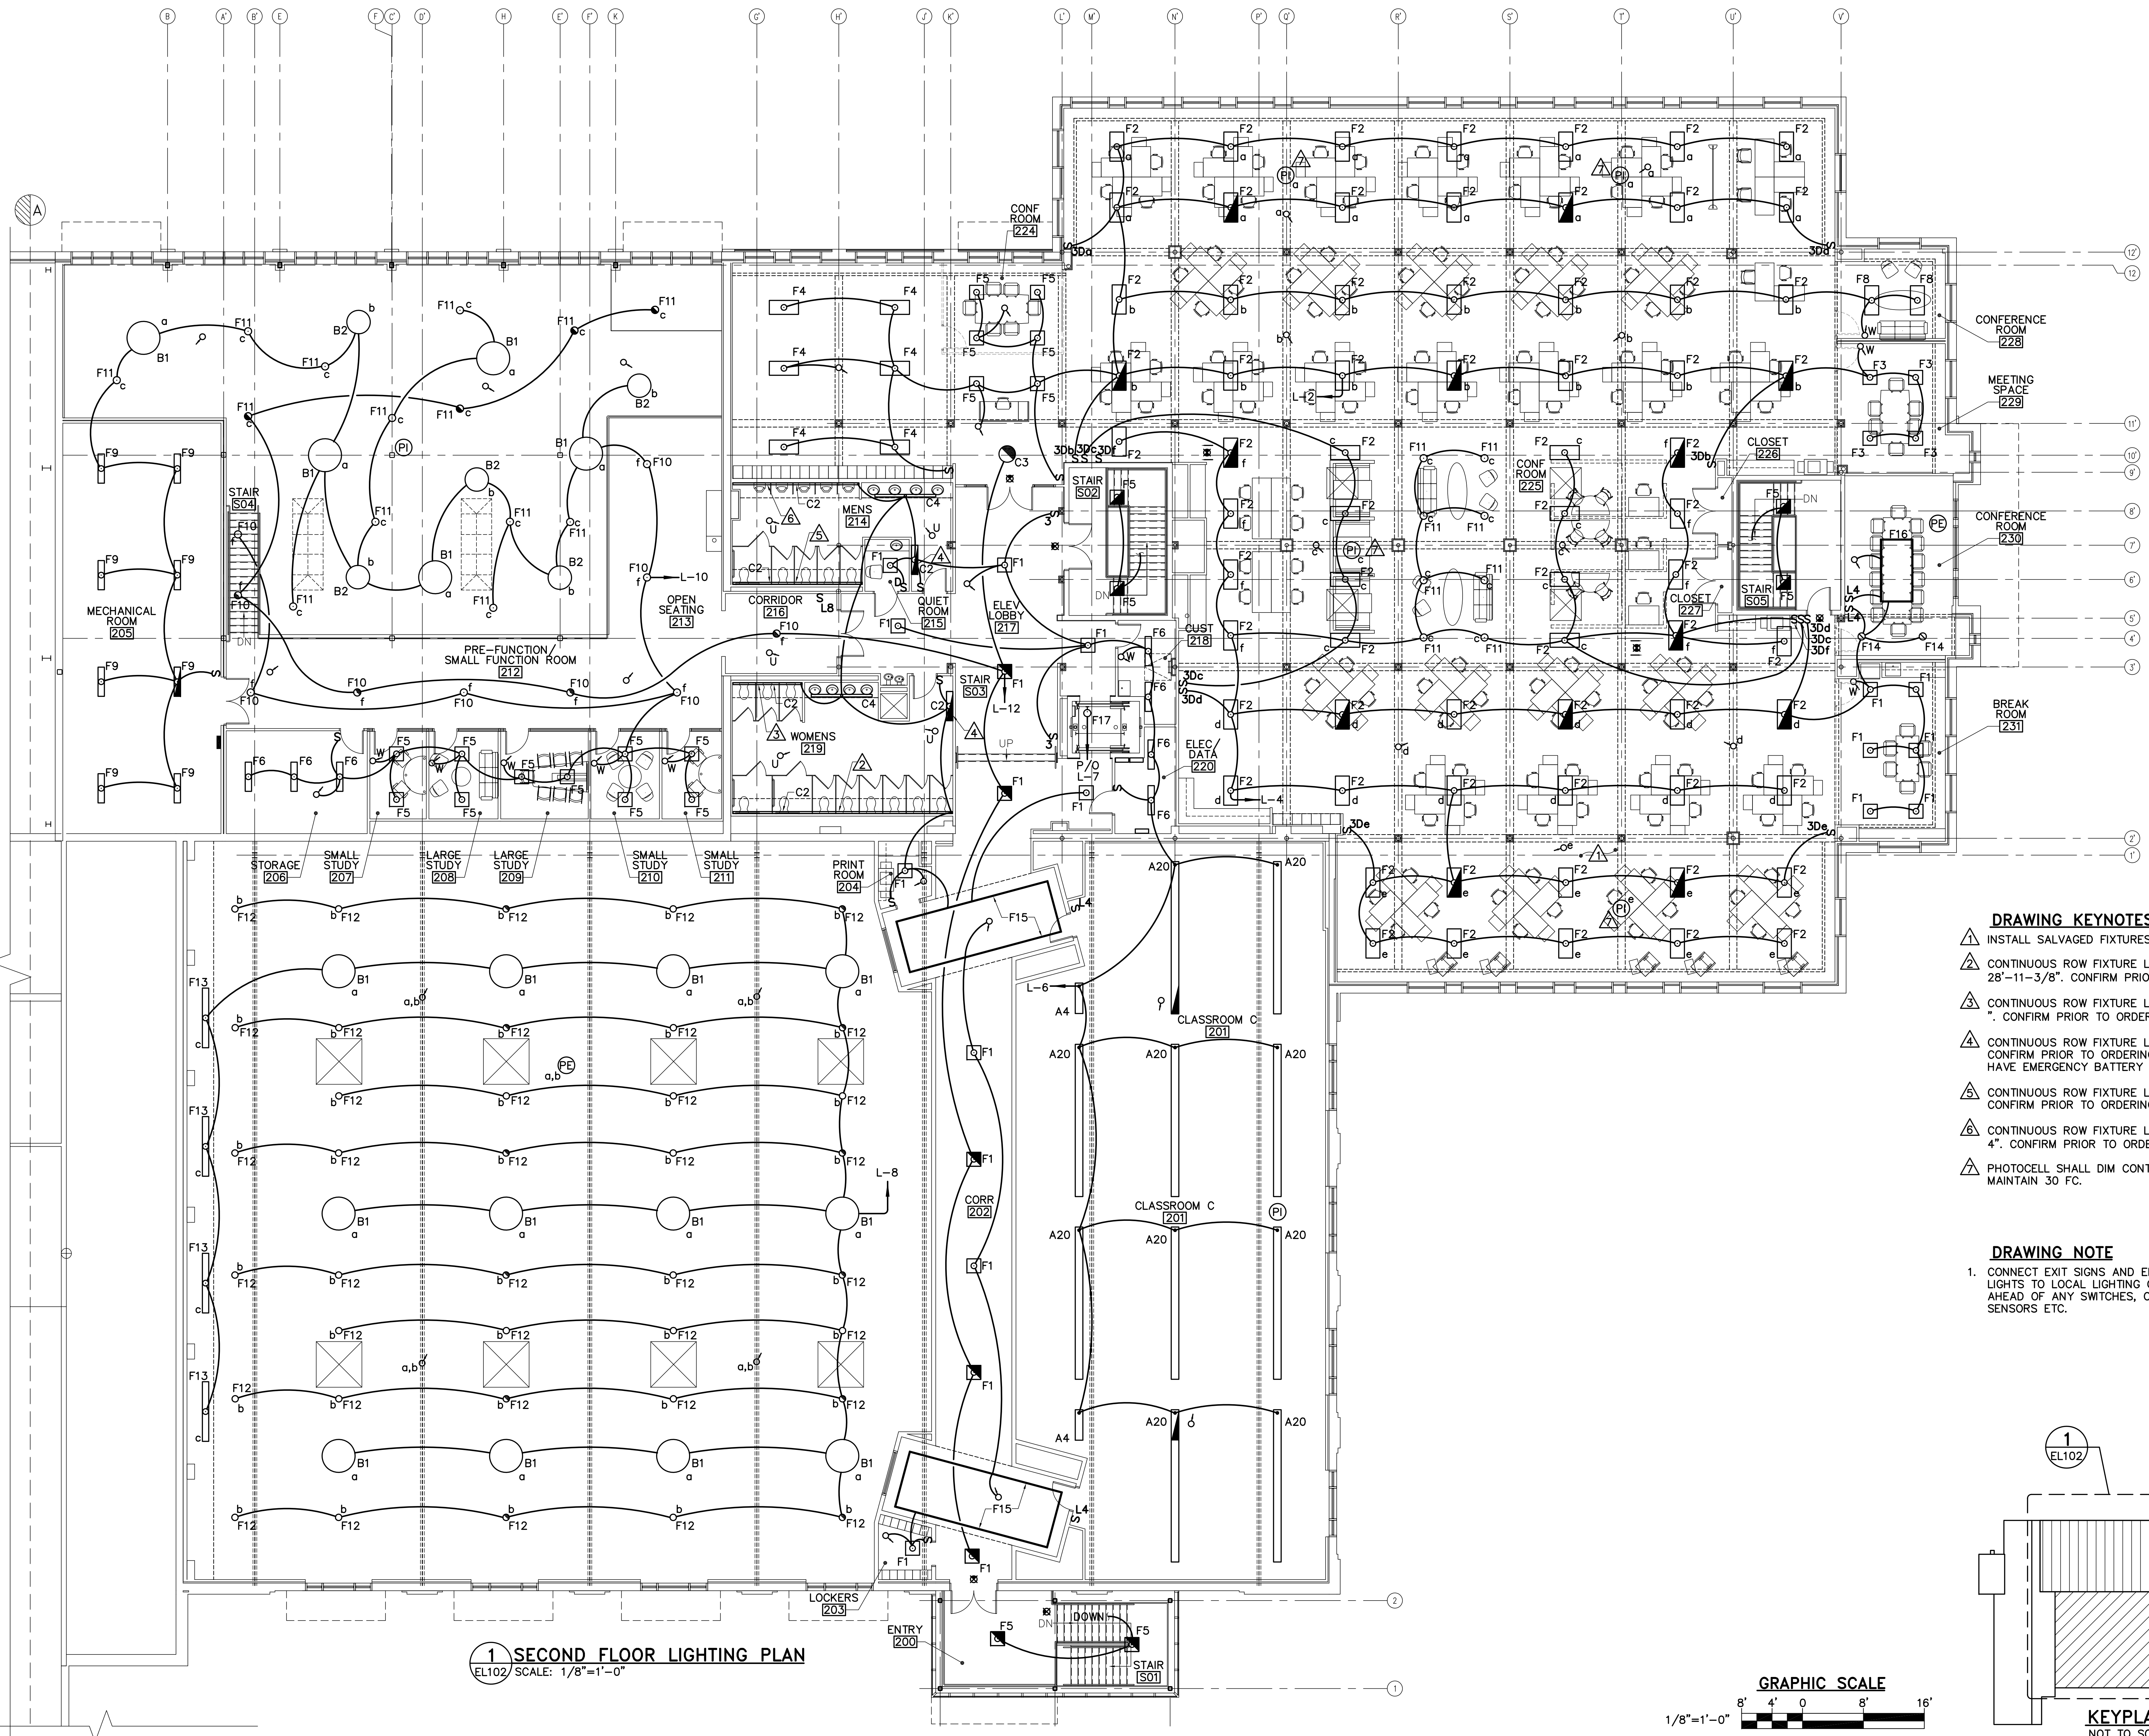

- DRAWING KEYNOTES**
- ▲ INSTALL SALVAGED FIXTURES.
 - ▲ CONTINUOUS ROW FIXTURE LENGTH OF 28'-11-3/8". CONFIRM PRIOR TO ORDERING.
 - ▲ CONTINUOUS ROW FIXTURE LENGTH OF 9'-2-1/2". CONFIRM PRIOR TO ORDERING.
 - ▲ CONTINUOUS ROW FIXTURE LENGTH OF 4'-0". CONFIRM PRIOR TO ORDERING. FIXTURE SHALL HAVE EMERGENCY BATTERY BACKUP.
 - ▲ CONTINUOUS ROW FIXTURE LENGTH OF 17'-1". CONFIRM PRIOR TO ORDERING.
 - ▲ CONTINUOUS ROW FIXTURE LENGTH OF 16'-7-3/4". CONFIRM PRIOR TO ORDERING.
 - ▲ PHOTOCELL SHALL DIM CONTROL ZONE TO MAINTAIN 30 FC.

DRAWING NOTE

1. CONNECT EXIT SIGNS AND EMERGENCY LIGHTS TO LOCAL LIGHTING CIRCUIT AHEAD OF ANY SWITCHES, OCCUPANCY SENSORS ETC.

1 SECOND FLOOR LIGHTING PLAN
 EL102 SCALE: 1/8"=1'-0"

