


1 EAST ENTRANCE REMOVALS PLAN
 CS103 SCALE: 1"=10'

KEYNOTES: (REMOVALS PLAN ONLY)


- ▲1 EXISTING ASPHALT CONCRETE PAVEMENT.
- ▲2 EXISTING ASPHALT CONCRETE PAVEMENT SIDEWALK.
- ▲3 EXISTING TURF.
- ▲4 EXISTING NATURAL GAS SERVICE ENTRANCE, METER, REGULATOR AND PIPE UP WALL.
- ▲5 EXISTING FLAGPOLE.
- ▲6 EXISTING SHRUB.
- ▲7 EXISTING ±10" DIAMETER SPRUCE TREE.
- ▲8 EXISTING ±18"-24" DIAMETER MULTI-TRUNKED SHRUB.
- ▲9-▲10 NOT USED.
- ▲11 SAWCUT AND REMOVE EXISTING ASPHALT CONCRETE PAVEMENT, ±4" THICK
- ▲12 SAWCUT AND REMOVE EXISTING ASPHALT CONCRETE PAVEMENT (±4" THICK) AND BASE (±6" THICK)
- ▲13 SAWCUT AND REMOVE EXISTING ASPHALT CONCRETE SIDEWALK (THICKNESS VARIES FROM ±8" TO ±2") AND 6" THICK REINFORCED CONCRETE SLAB BELOW.
- ▲14 REMOVE EXISTING GRANITE AND REINFORCED CONCRETE RAISED PLANTING BED. SEE SHEET SD101.
- ▲15 REMOVE EXISTING 12"x8"x ±16' LONG GRANITE CURB/EDGING AND CONCRETE WALL BELOW. SEE SHEET SD101.
- ▲16 STRIP EXISTING TOPSOIL, ±4" THICK.
- ▲17 REMOVE EXISTING OVERHEAD WIRE (SEE SHEETS CX101 AND ED101).
- ▲18 REMOVE EXISTING JERSEY BARRIER.
- ▲19-▲20 NOT USED.
- ▲21 SEDIMENT CONTROL WATTLE. SEE DETAIL 2/C-001.
- ▲22 CATCH BASIN INLET PROTECTION. SEE DETAIL 1/C-001.

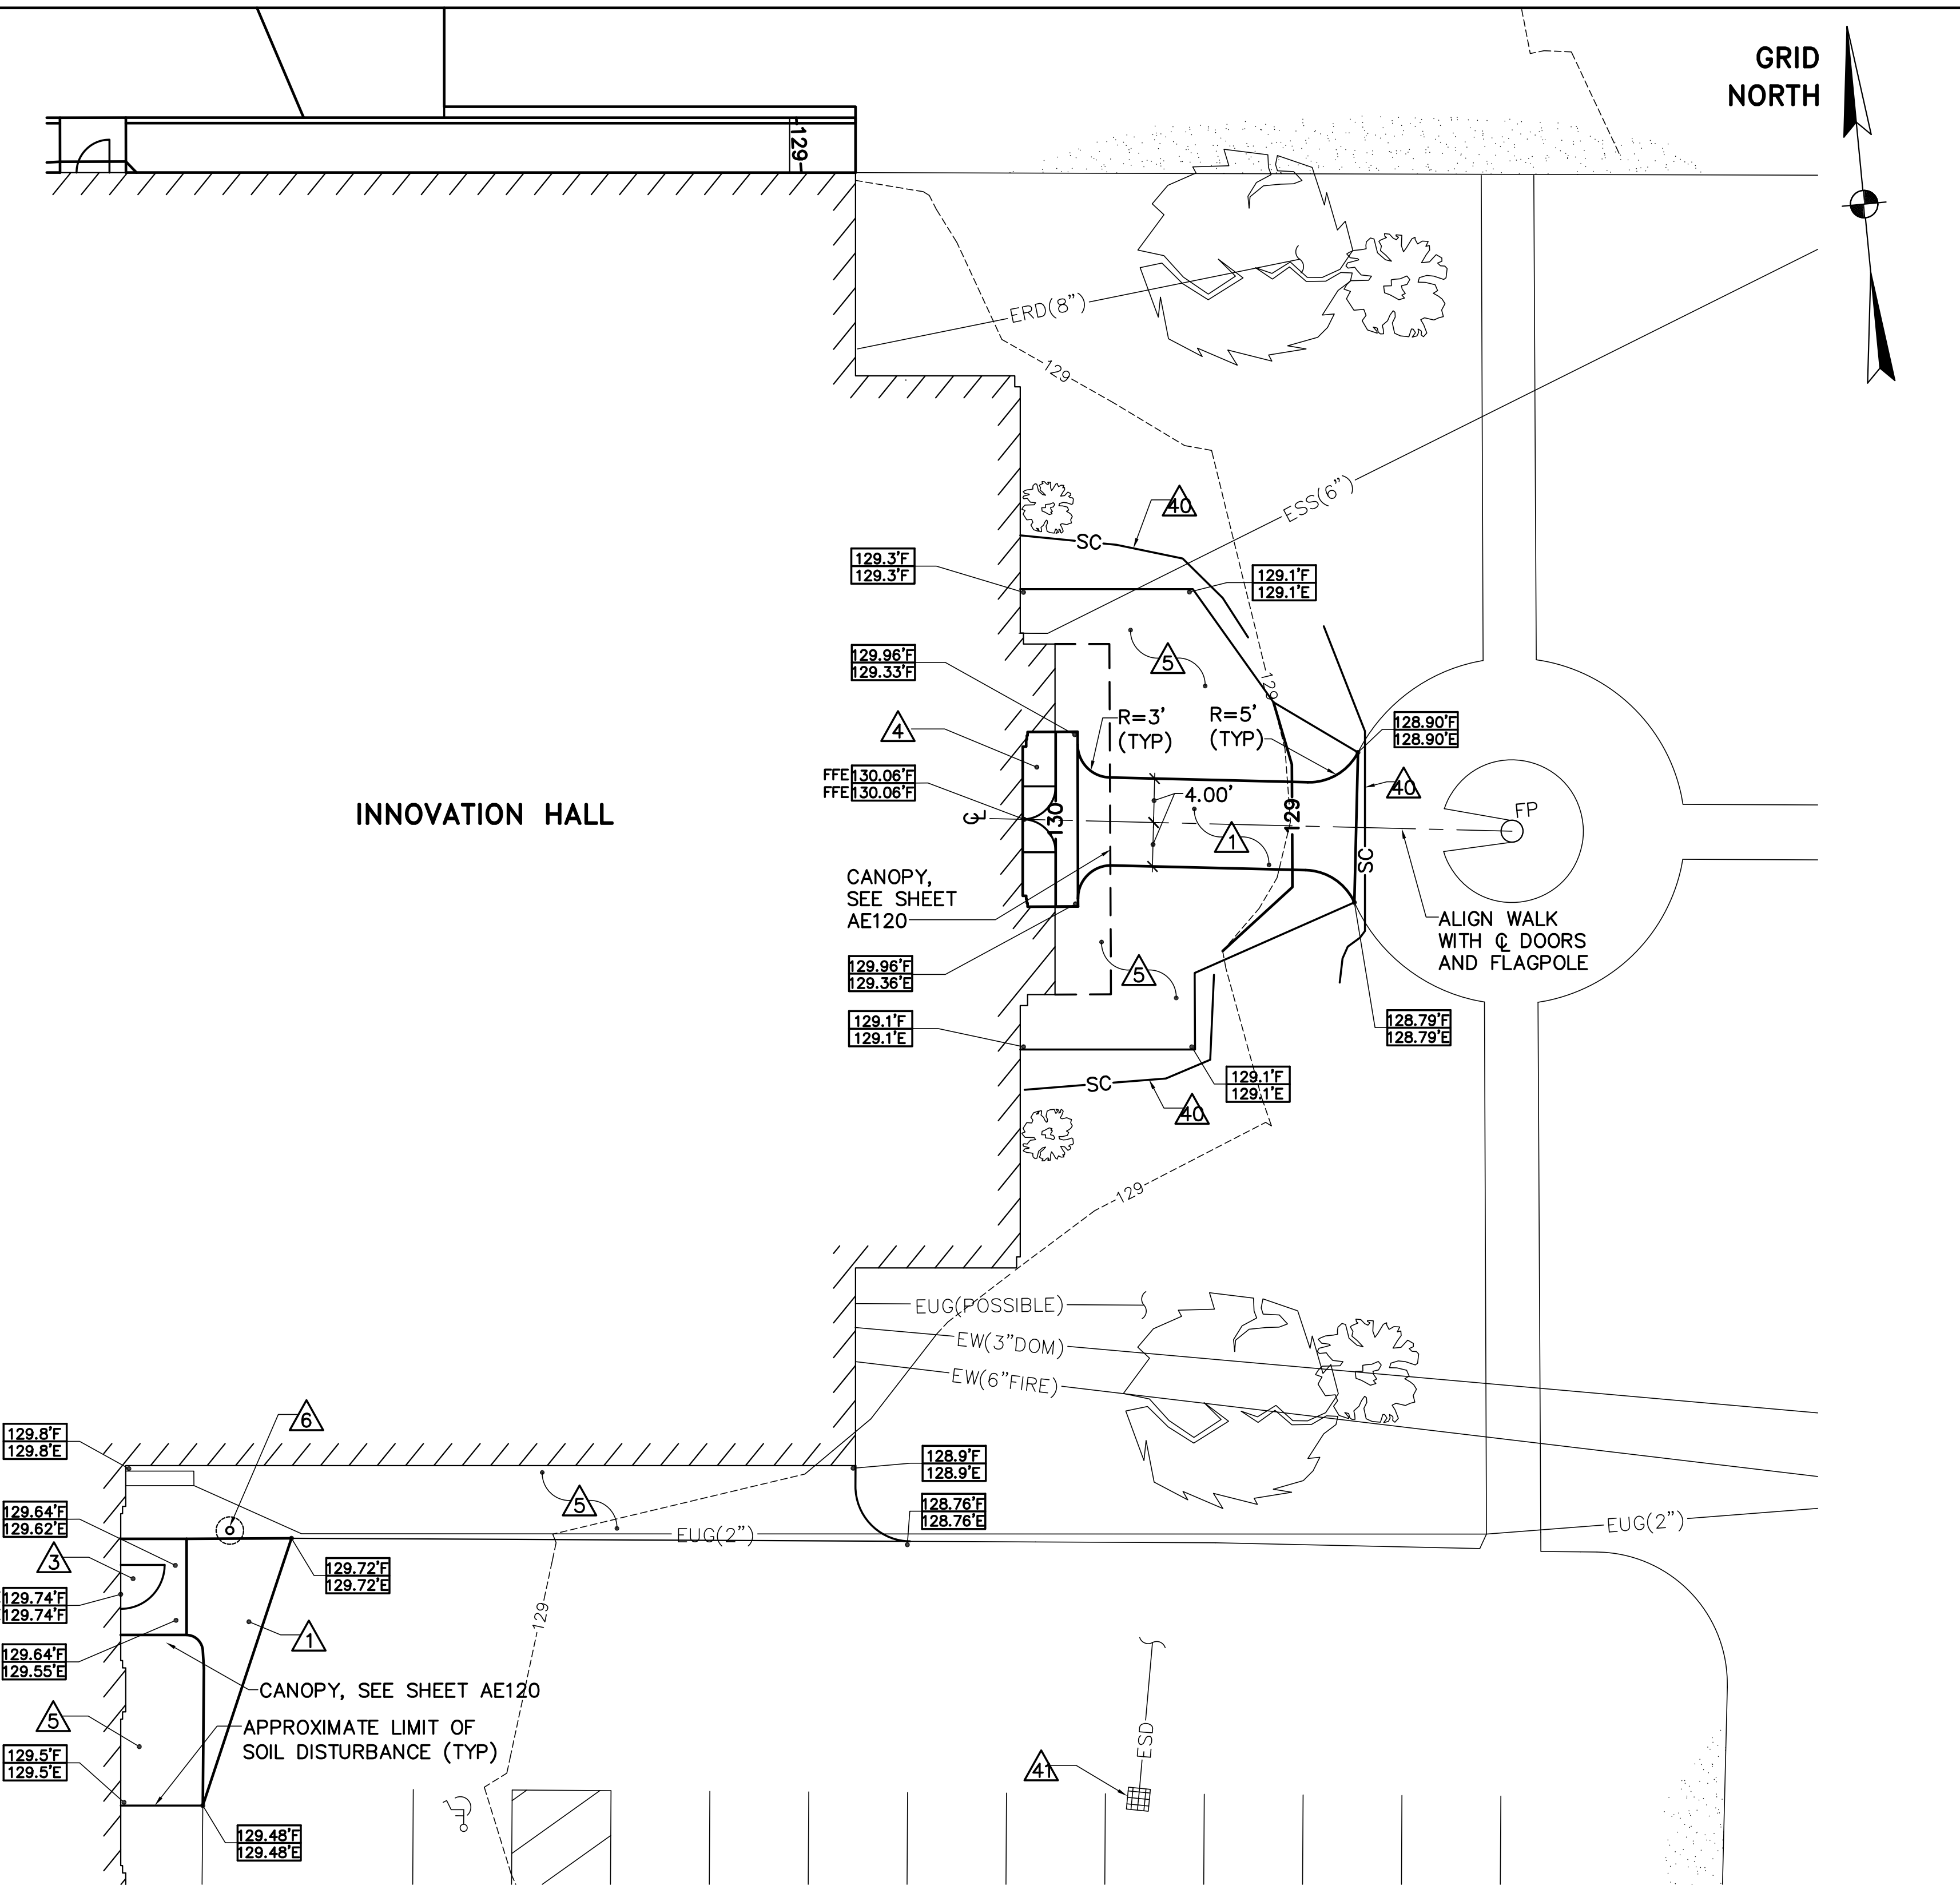



2 EAST ENTRANCE SITE PLAN
 CS103 SCALE: 1"=10'

KEYNOTES: (SITE PLAN ONLY)

- ▲1 ASPHALT CONCRETE PAVEMENT. SEE DETAIL 1/C-501.
- ▲2 ASPHALT CONCRETE SIDEWALK. SEE DETAIL 2/C-501.
- ▲3 REINFORCED CONCRETE STOOP. SEE SHEET SB101.
- ▲4 REINFORCED CONCRETE STOOP. SEE SHEET SB502.
- ▲5 6" TOPSOIL, SEED, FERTILIZER AND MULCH ALL DISTURBED AREAS UNLESS INDICATED OTHERWISE.
- ▲6 BOLLARD. SEE DETAIL 3/CS103.
- ▲7-▲8 NOT USED.
- ▲9 SEDIMENT CONTROL WATTLE. SEE DETAIL 2/C-001.
- ▲10 CATCH BASIN INLET PROTECTION. SEE DETAIL 1/C-001.

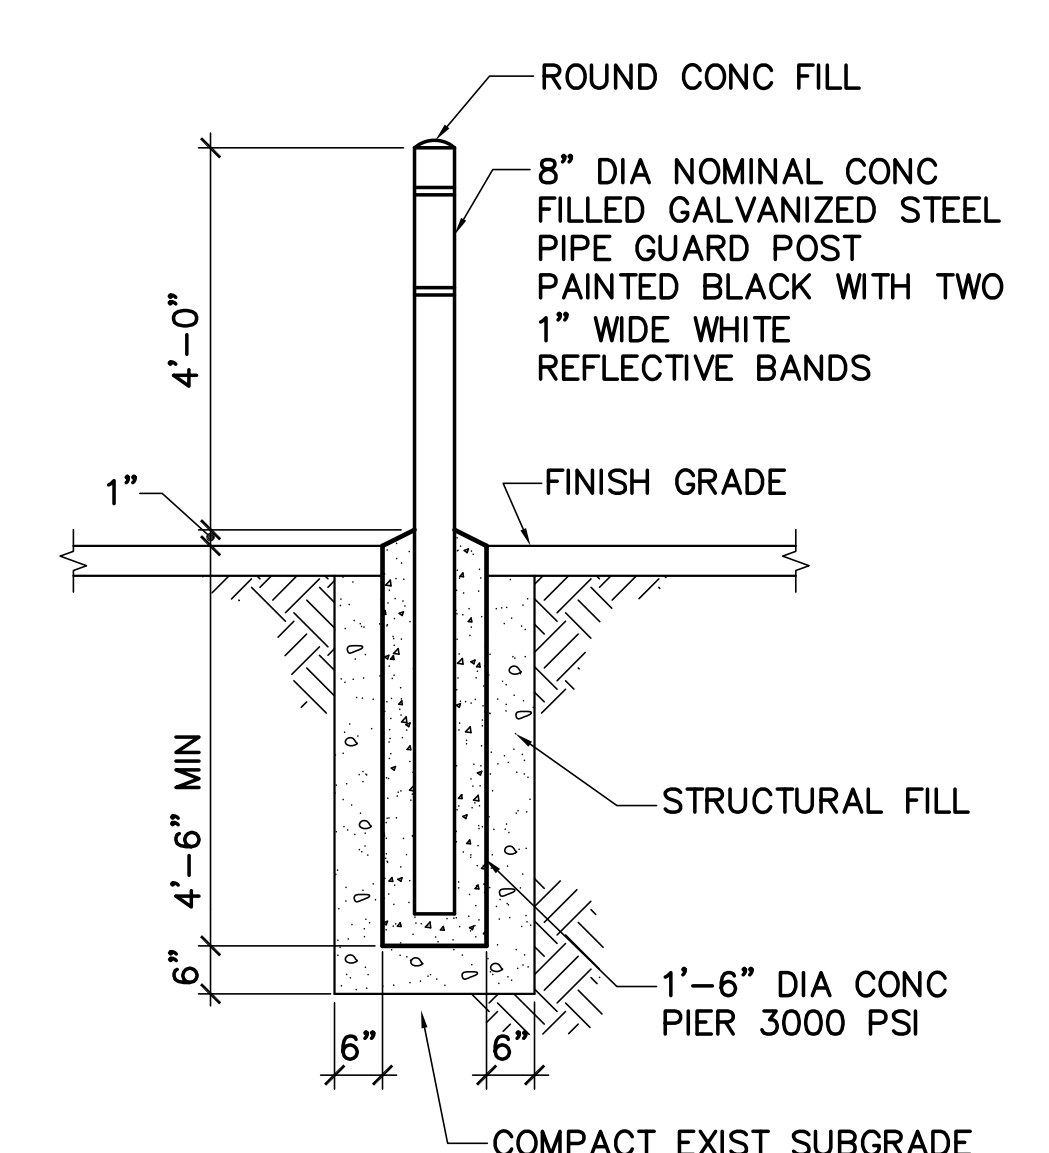

3 TYP BOLLARD DETAIL
 CS103 NOT TO SCALE

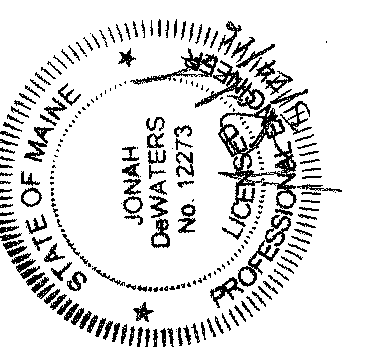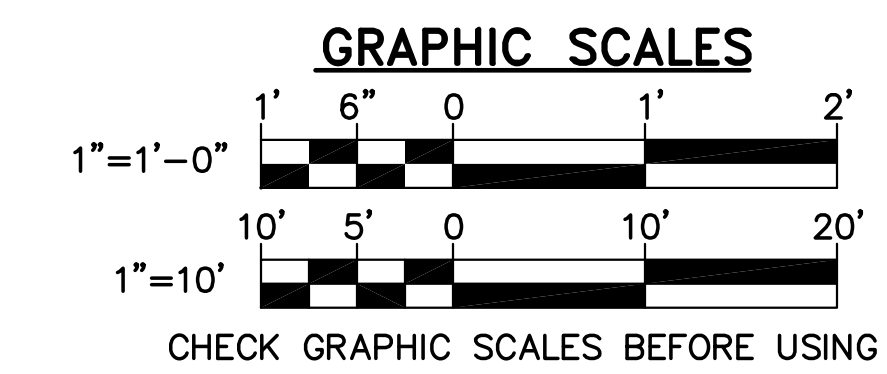

JSD
 JLD
 JLG
 21502.10
 DESIGNED BY:
 DRAWN BY:
 CHECKED BY:
 PROJECT:

**UNIVERSITY OF NEW ENGLAND
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**RENOVATIONS TO THE
 STEVENS AVENUE ARMORY**

**EAST
 ENTRANCE
 PLANS**

SCALE: AS NOTED
 DATE: 05-24-16

DWG. **CS103**

SHEET: 10 OF 169