

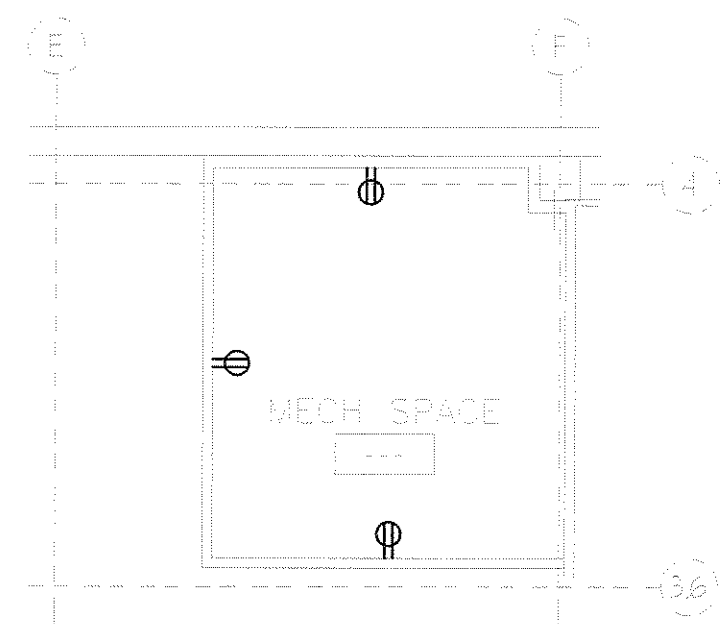
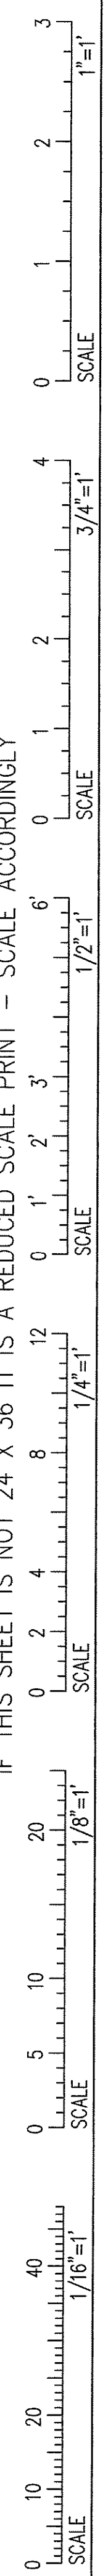
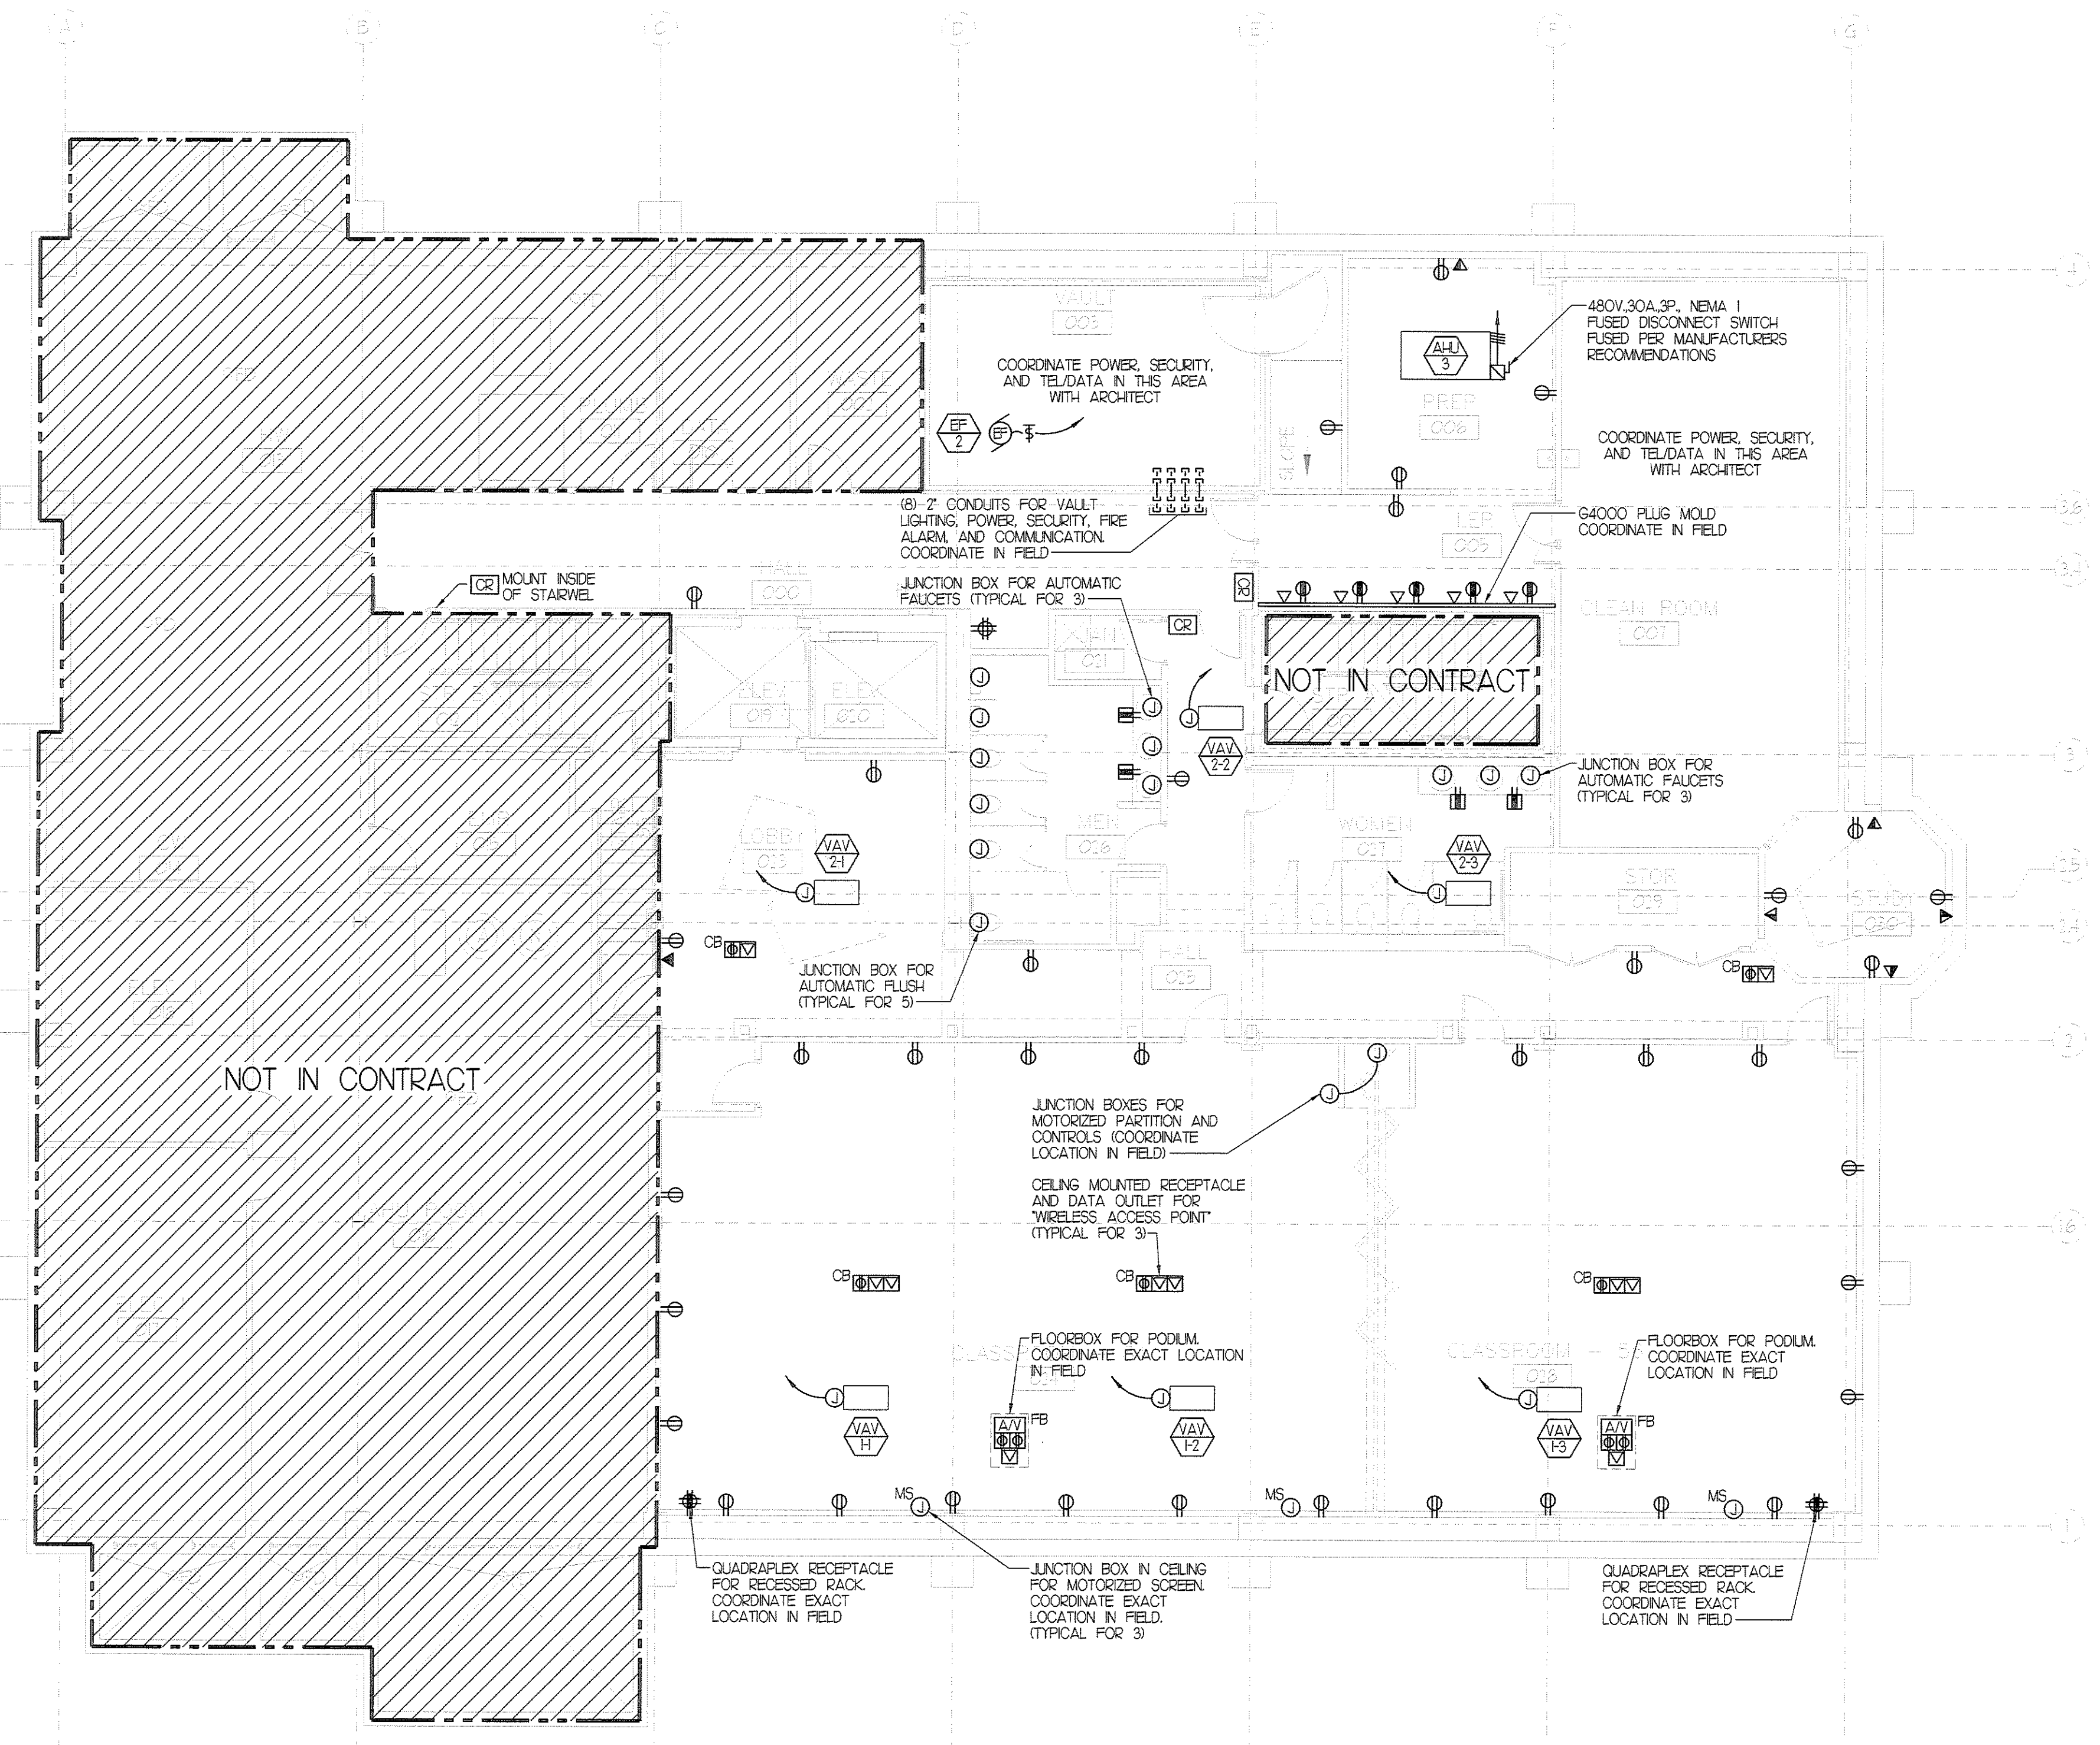
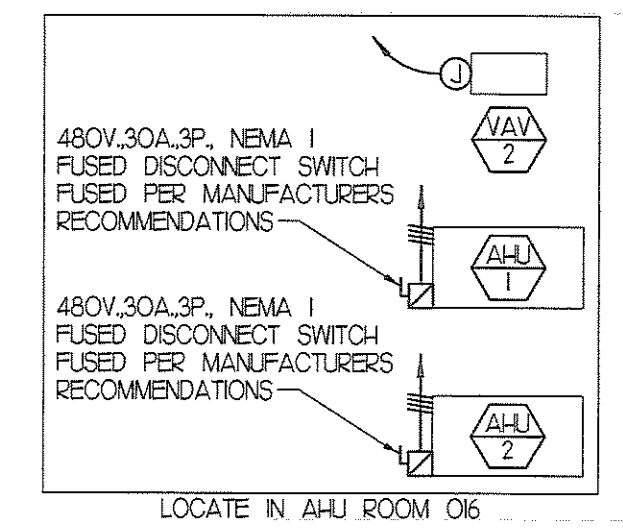



IF THIS SHEET IS NOT 24 X 36 IT IS A REDUCED SCALE PRINT - SCALE ACCORDINGLY

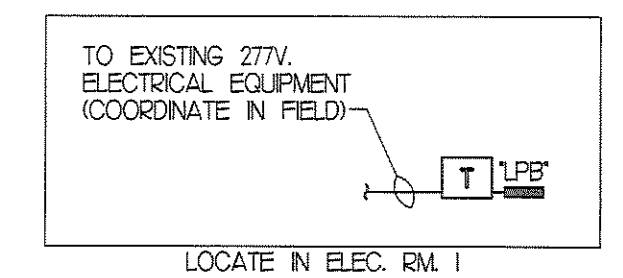

MECHANICAL SPACE POWER PLAN
SCALE: 1/8" = 1'-0"

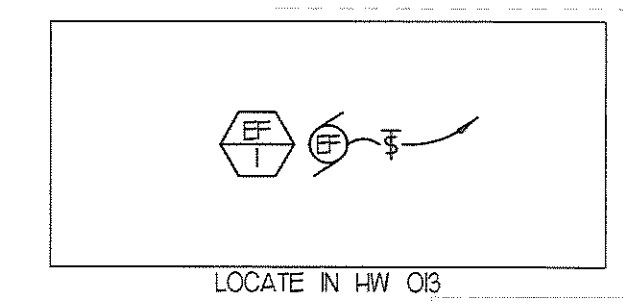

LOWER LEVEL POWER PLAN
SCALE: 1/8" = 1'-0"

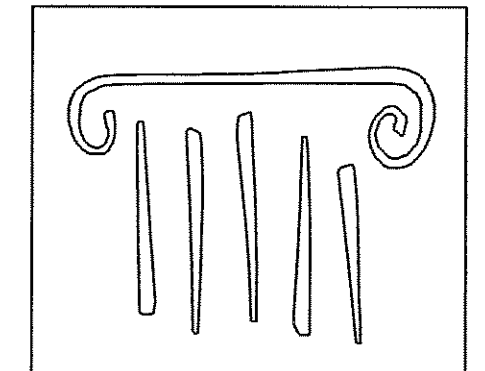

PORT CITY ARCHITECTURE

65 NEWBURY STREET
PORTLAND, ME 04101
207.761.9000
fax: 207.761.2010
lita@portcityarch.com



VINCENT A. DIORIO, INC.
CONSULTING ENGINEERS
Norwood, Massachusetts 02062
tel: (617) 555-9754 fax: (617) 555-9755 email: vadi@vadieng.com

**UNIVERSITY OF NEW ENGLAND
COLLEGE OF
PHARMACY
CLASSROOMS**

716 STEVENS AVENUE, PORTLAND, ME

#	DATE	DESCRIPTION

Date Issued 3/11/09
Project Number 06506

SHEET NAME
**ELECTRICAL
LOWER FLOOR
POWER PLAN**

Drawn By CDO	E03
Checked By VAD	

Received
MAR 16 2009
Favreau Electric

BID DOCUMENTS - NOT FOR CONSTRUCTION

COPYRIGHT: Reuse or reproduction of the contents of this document is not permitted without written permission of PORT CITY ARCHITECTURE PA