


IF THIS SHEET IS NOT 24 X 36 IT IS A REDUCED SCALE PRINT - SCALE ACCORDINGLY

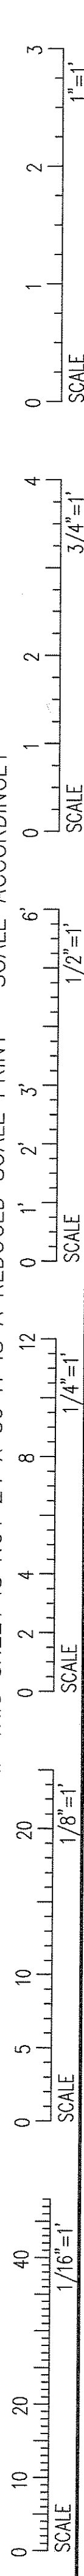

153'-10 1/4" TOP OF ROOF  
153'-3/4" T.O.S.

SLOPED ROOF  
ASPHALT SHINGLES  
ICE & WATER SHIELD  
1" OSB  
(3) LAYERS 2" POLYISO  
W/ OVERLAP JOINTS  
MTL DECK - SEE STRUCT  
STEEL TRUSSES  
- SEE STRUCT

140'-10" F.F.E. ATTIC  
140'-4 1/2" T.O.S.

TYP TILE WALL  
EXTERIOR TILE  
1/2" CDX PLYWOOD  
3" RIGID INSUL  
AV SYSTEM  
1/2" DENSE GLASS  
8" MTL STUD  
5/8" GIBS

126'-8" F.F.E. THIRD FLOOR  
126'-1 1/2" T.O.S.

PIER SECTION  
BRICK  
AIR SPACE  
5/8" CDX PLYWOOD  
MTL STUD  
3" RIGID INSUL  
AV SYSTEM  
1/2" DENSE GLASS  
8" MTL STUD  
5/8" GIBS

119'-4" F.F.E. SECOND FLOOR  
119'-0 1/2" T.O.S.

TYP BRICK WALL  
BRICK  
2" AIR SPACE  
3" RIGID INSUL  
AV SYSTEM  
1/2" DENSE GLASS  
8" MTL STUD  
5/8" GIBS

100'-0" F.F.E. FIRST FLOOR  
99'-6 1/2" T.O.S.

TYP FOUNDATION WALL  
WATERPROOFING SYSTEM  
CONC FOUNDATION (SEE STRUCTURAL)  
WALL FINISH (SEE SCHEDULE)

91'-0" 1/4" GRADE

1 TYP WALL SECTION  
SCALE: 3/8" = 1'-0"  
2'-6"

153'-10 1/4" TOP OF ROOF  
153'-3/4" T.O.S.

SLOPED ROOF  
ASPHALT SHINGLES  
ICE & WATER SHIELD  
1" OSB  
(3) LAYERS 2" POLYISO  
W/ OVERLAP JOINTS  
MTL DECK - SEE STRUCT  
STEEL TRUSSES  
- SEE STRUCT

140'-10" F.F.E. ATTIC  
140'-4 1/2" T.O.S.

TYP TILE WALL  
EXTERIOR TILE  
1/2" CDX PLYWOOD  
3" RIGID INSUL  
AV SYSTEM  
1/2" DENSE GLASS  
8" MTL STUD  
5/8" GIBS  
DECOR ELEMENT:  
COPPER ON  
CDX PLYWOOD

126'-8" F.F.E. THIRD FLOOR  
126'-1 1/2" T.O.S.

BRACE PIER AS  
REQUIRED

119'-4" F.F.E. SECOND FLOOR  
119'-0 1/2" T.O.S.

BRACE PIER AS  
REQUIRED

100'-0" F.F.E. FIRST FLOOR  
99'-6 1/2" T.O.S.

TYP FOUNDATION WALL  
WATERPROOFING SYSTEM  
CONC FOUNDATION (SEE STRUCTURAL)  
FINISH (SEE SCHEDULE)

91'-0" 1/4" GRADE

2 WALL SECTION AT PIER  
SCALE: 3/8" = 1'-0"  
2'-6"

153'-10 1/4" TOP OF ROOF  
153'-3/4" T.O.S.

SLOPED ROOF  
ASPHALT SHINGLES  
ICE & WATER SHIELD  
1" OSB  
(3) LAYERS 2" POLYISO  
W/ OVERLAP JOINTS  
MTL DECK - SEE STRUCT  
STEEL TRUSSES  
- SEE STRUCT

140'-10" F.F.E. ATTIC  
140'-4 1/2" T.O.S.

TYP TILE WALL  
EXTERIOR TILE  
1/2" CDX PLYWOOD  
3" RIGID INSUL  
AV SYSTEM  
1/2" DENSE GLASS  
8" MTL STUD  
5/8" GIBS

126'-8" F.F.E. THIRD FLOOR  
126'-1 1/2" T.O.S.

BRICK TIES  
16" O.C. TYP.

119'-4" F.F.E. SECOND FLOOR  
119'-0 1/2" T.O.S.

TYP BRICK WALL  
BRICK  
2" AIR SPACE  
3" RIGID INSUL  
AV SYSTEM  
1/2" DENSE GLASS  
8" MTL STUD  
5/8" GIBS


100'-0" F.F.E. FIRST FLOOR  
99'-6 1/2" T.O.S.

TYP FOUNDATION WALL  
WATERPROOFING SYSTEM  
CONC FOUNDATION (SEE STRUCTURAL)  
WALL FINISH (SEE SCHEDULE)

91'-0" 1/4" GRADE

3 WALL SECTION AT TILE  
SCALE: 3/8" = 1'-0"  
2'-6"

BID SET - NOT FOR CONSTRUCTION

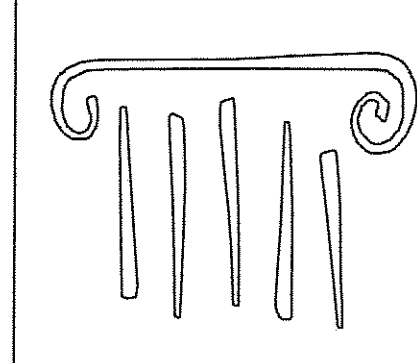

**PORT CITY ARCHITECTURE**

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fax: 207.761.2010  
lita@portcityarch.com

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**JACOBS CONSULTANCY**  
OP&L Laboratory Planning Practice

**VANZELM ENGINEERS**  
VANZELM HEYWOOD & SHAFORD, INC.

**BECKER**  
structural engineers, inc.

**SYTDesign CONSULTANTS**  
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**ALLIED/COOK CONSTRUCTION**

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**Titan Mechanical Inc.**  
Mechanical Engineering & Mechanical Contracting

**UNIVERSITY OF NEW ENGLAND**

**COLLEGE OF PHARMACY**

716 STEVENS AVENUE, PORTLAND, ME

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DATE	DESCRIPTION
	BID SET
Date Issued	02/08/08
Project Number	06506

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SHEET NAME  
**WALL SECTIONS**

Drawn By  
EC, AM, EK

Checked By  
LAS

A4.4