



IF THIS SHEET IS NOT 24 X 36 IT IS A REDUCED SCALE PRINT - SCALE ACCORDINGLY


SCALE 1"=1'
SCALE 3/4"=1'
SCALE 1/2"=1'
SCALE 3/8"=1'
SCALE 1/4"=1'
SCALE 1/8"=1'
SCALE 1/16"=1'

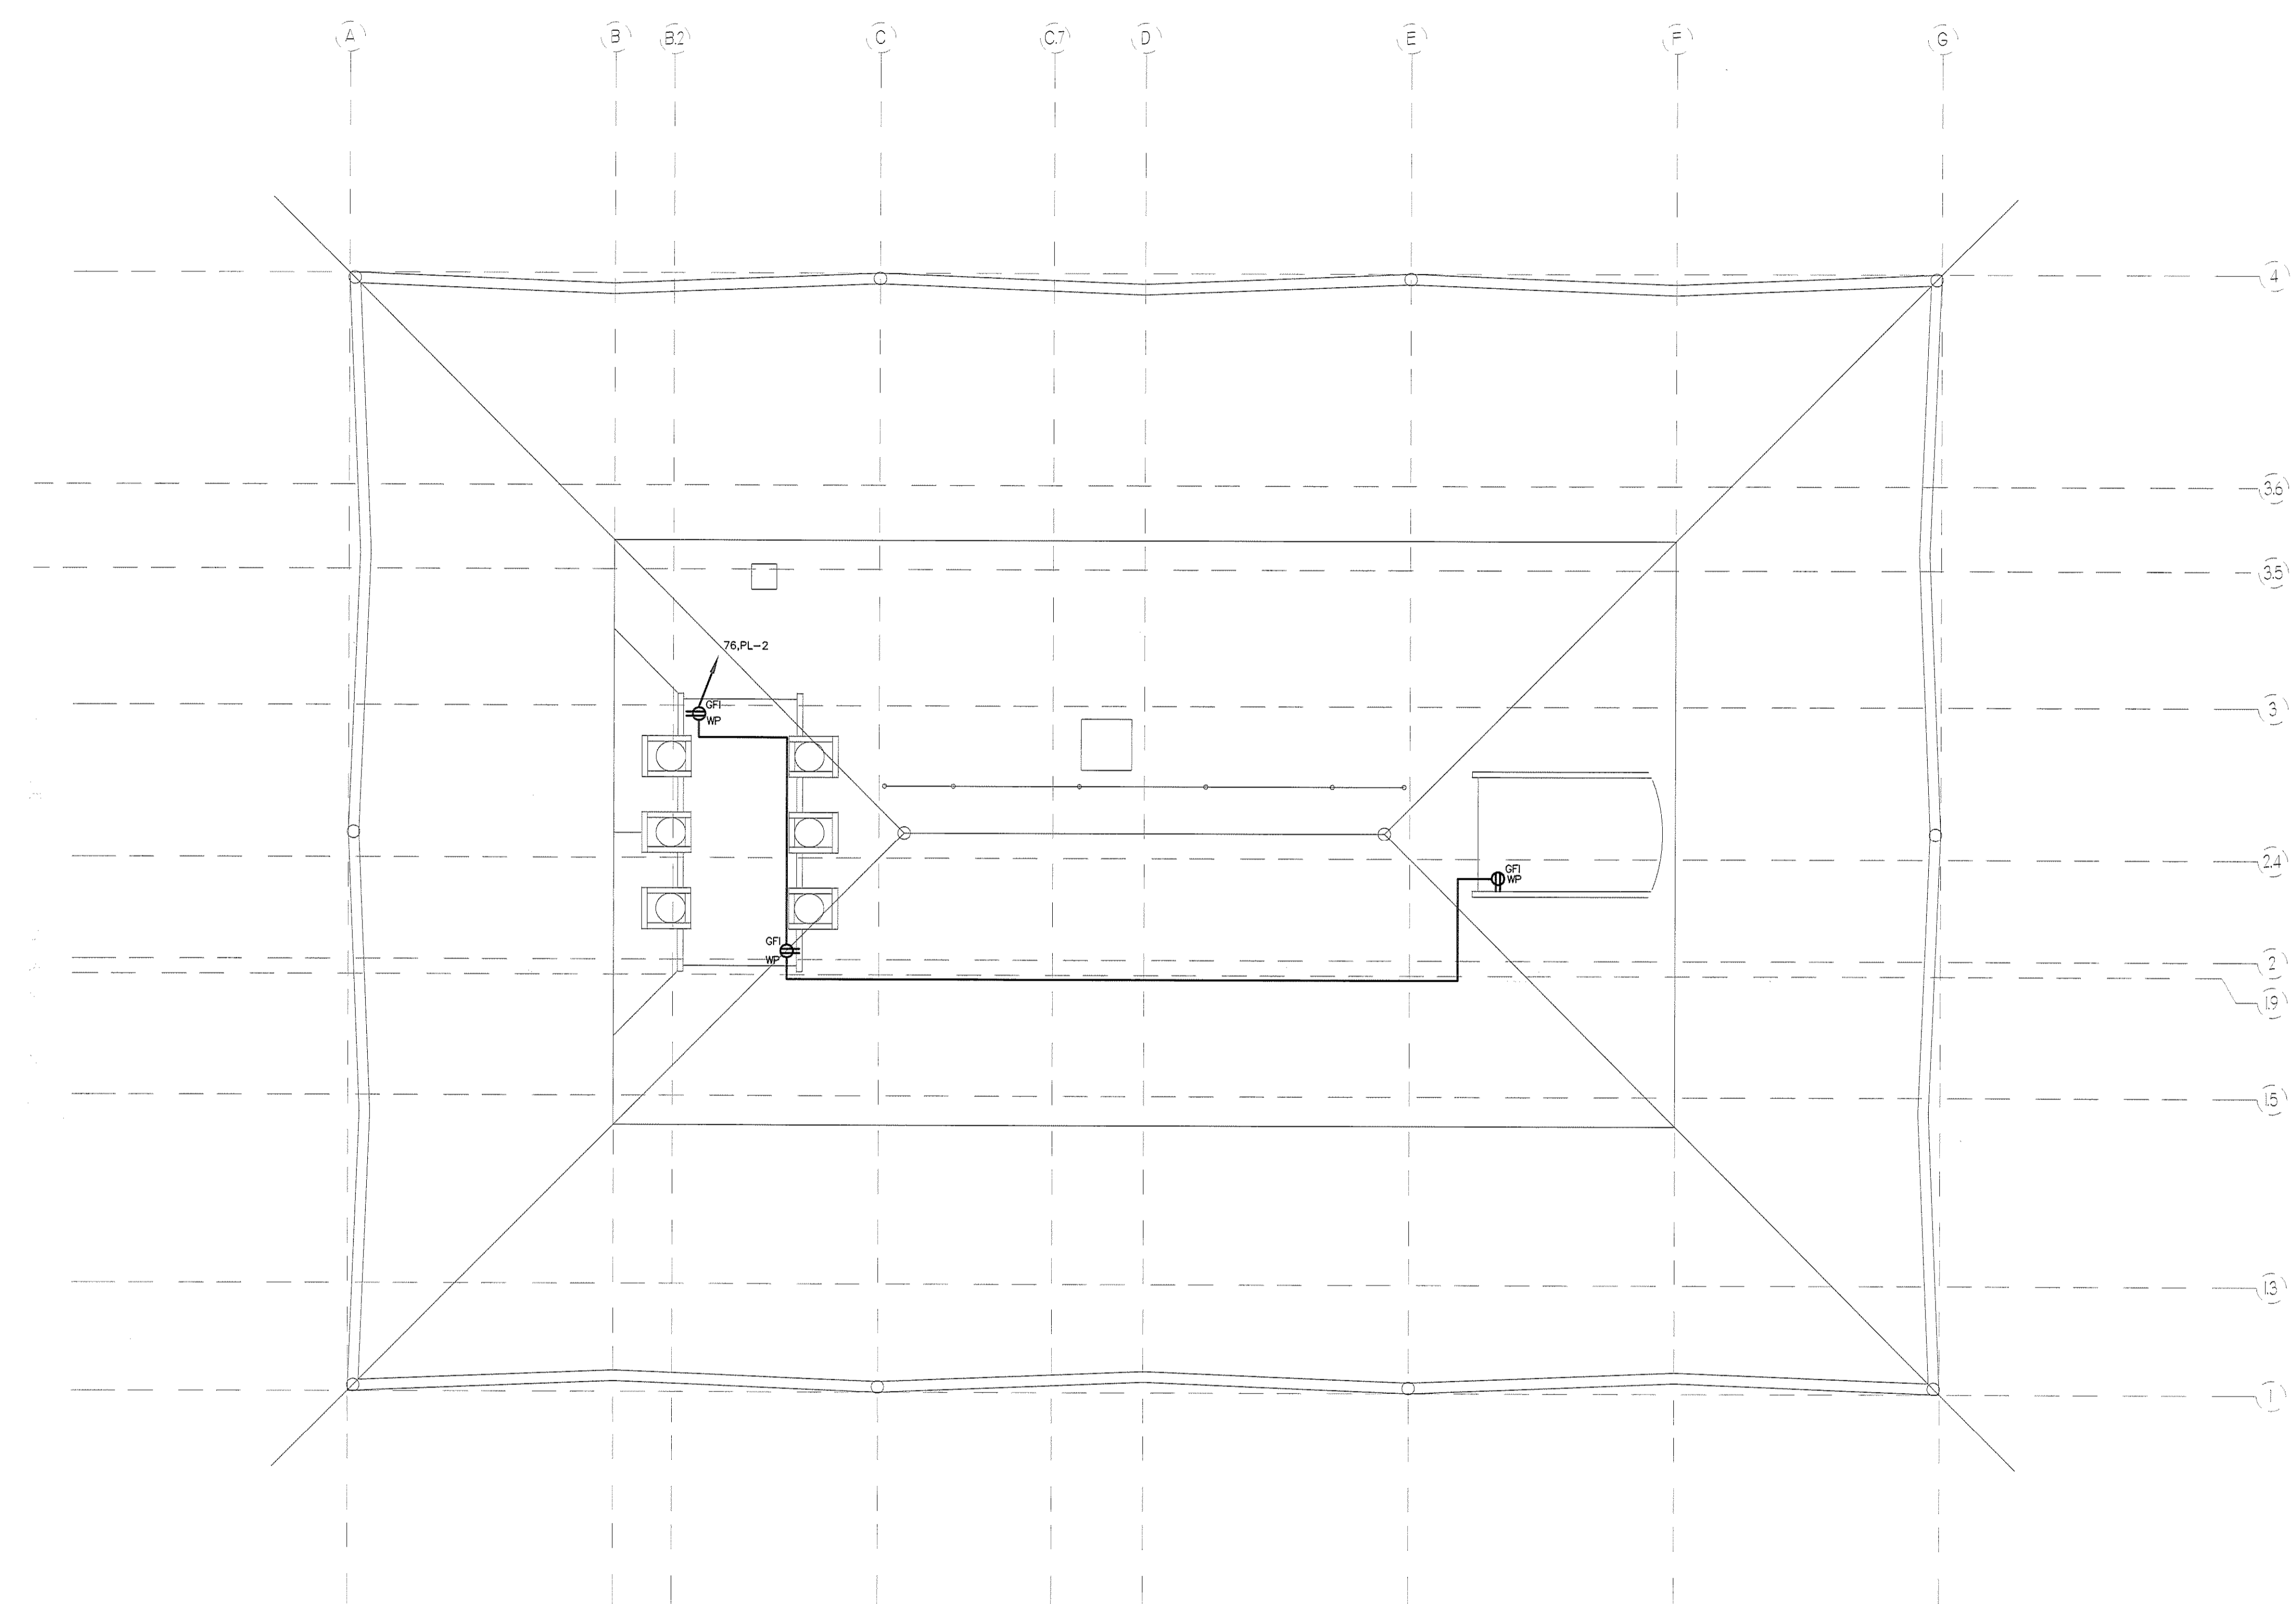

1 ROOF LEVEL PLAN
SCALE: 1/8" = 1'-0"

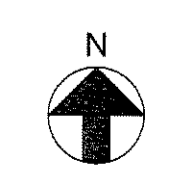

BID SET - NOT FOR CONSTRUCTION

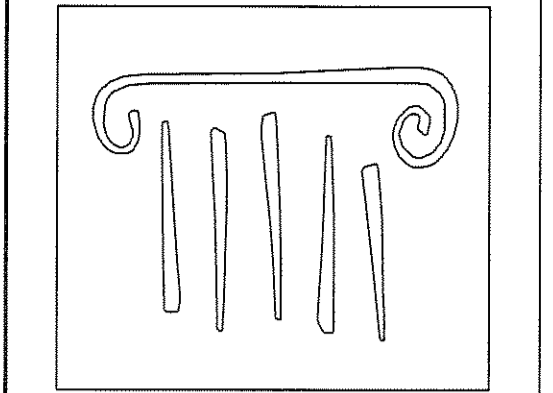

PORT CITY ARCHITECTURE

65 NEWBURY STREET
PORTLAND, ME 04101
207.761.9000
fax: 207.761.2010
lita@portcityarch.com

VANZELM ENGINEERS

VANZELM HEYWOOD & SHADFORD, INC.
19 BALCOFF NOTER FARMINGTON, CT 06032
TEL: (860) 264-2064 FAX: (860) 264-2098

PROJECT NO.: 2007120.00

BECKER
structural engineers, inc.

SYTDesign CONSULTANTS
CIVIL ENGINEERING & LANDSCAPE ARCHITECTURE

ALLIED/COOK CONSTRUCTION

Fareau
ALUMINUM

Titan Mechanical, Inc.
Deep Well Engineering - Mechanical Contracting

UNIVERSITY OF NEW ENGLAND

COLLEGE OF PHARMACY

716 STEVENS AVENUE,
PORTLAND, ME

#	DATE	DESCRIPTION
		BID SET
	Date Issued	02/08/08
	Project Number	06306

SHEET NAME

ELECTRICAL POWER PLAN - ROOF

Drawn By	XXX
Checked By	FBI

EP1.6