

PORT CITY ARCHITECTURE

65 NEWBURY STREET
 PORTLAND, ME 04101
 207.761.9000
 fax: 207.761.2010
 lita@portcityarch.com

VANZELM ENGINEERS

VANZELM HEYWOOD & SHADFORD, INC.
 19 TALCOTT NOTCH FARMINGTON, CT 06032
 TEL: (860) 284-2964 FAX: (860) 284-2966

PROJECT NO.: 2007120.00

BECKER
 structural engineers, inc.

SYTDesign CONSULTANTS
 CIVIL ENGINEERING & LANDSCAPE ARCHITECTURE

ALLIED/COOK CONSTRUCTION

Faireau
 electric

Titan Mechanical, Inc.
 Design-Build Engineering - Mechanical Contracting

UNIVERSITY OF NEW ENGLAND

COLLEGE OF PHARMACY

716 STEVENS AVENUE,
 PORTLAND, ME

#	DATE	DESCRIPTION
		BID SET
	02/08/08	Date Issued
	06506	Project Number


SHEET NAME
ELECTRICAL POWER PLAN - LOWER LEVEL

Drawn By
 ANM

Checked By
 MER

EP1.0

- KEYED NOTES:
1. TOP STACKED 30KVA TRANSFORMER IS ALTERNATE.
 2. BASE BID: INSTALL CONDUIT FROM ROOM "ELECT 1" FOR FEEDER FOR FUTURE PANELBOARD INSTALLATION. SEE DRAWING EP1.1 FOR PANELBOARD LOCATION. SEE DRAWINGS E3.0 AND E3.1 FOR CONDUIT SIZE. PROVIDE PULL STRING IN CONDUIT AND CAP AND SEAL CONDUIT.
 3. BASE BID: INSTALL CONDUIT FROM ROOM "ELEC 11" FOR FEEDER FOR FUTURE PANELBOARD INSTALLATION. SEE DRAWING EP1.1 FOR PANELBOARD LOCATION. SEE DRAWINGS E3.0 AND E3.1 FOR CONDUIT SIZE. PROVIDE PULL STRING IN CONDUIT AND CAP AND SEAL CONDUIT.
 4. CONTROLLER FOR ACCESS CONTROL SYSTEM. COORDINATE LOCATION WITH INSTALLER.
 5. INSTALL ONE 1/2" EMPTY CONDUIT FROM CARD READER/POWER SUPPLY TO ACCESS CONTROL SYSTEM CONTROLLER IN DATA ROOM 010; PROVIDE PULL STRING IN CONDUIT.
 6. POWER CONNECTION FOR DOOR CONTROL POWER SUPPLY. COORDINATE LOCATION WITH INSTALLER.
 7. SEWAGE EJECTOR PUMP CONTROL PANEL SUPPLIED BY VENDOR. COORDINATE LOCATION WITH INSTALLER.

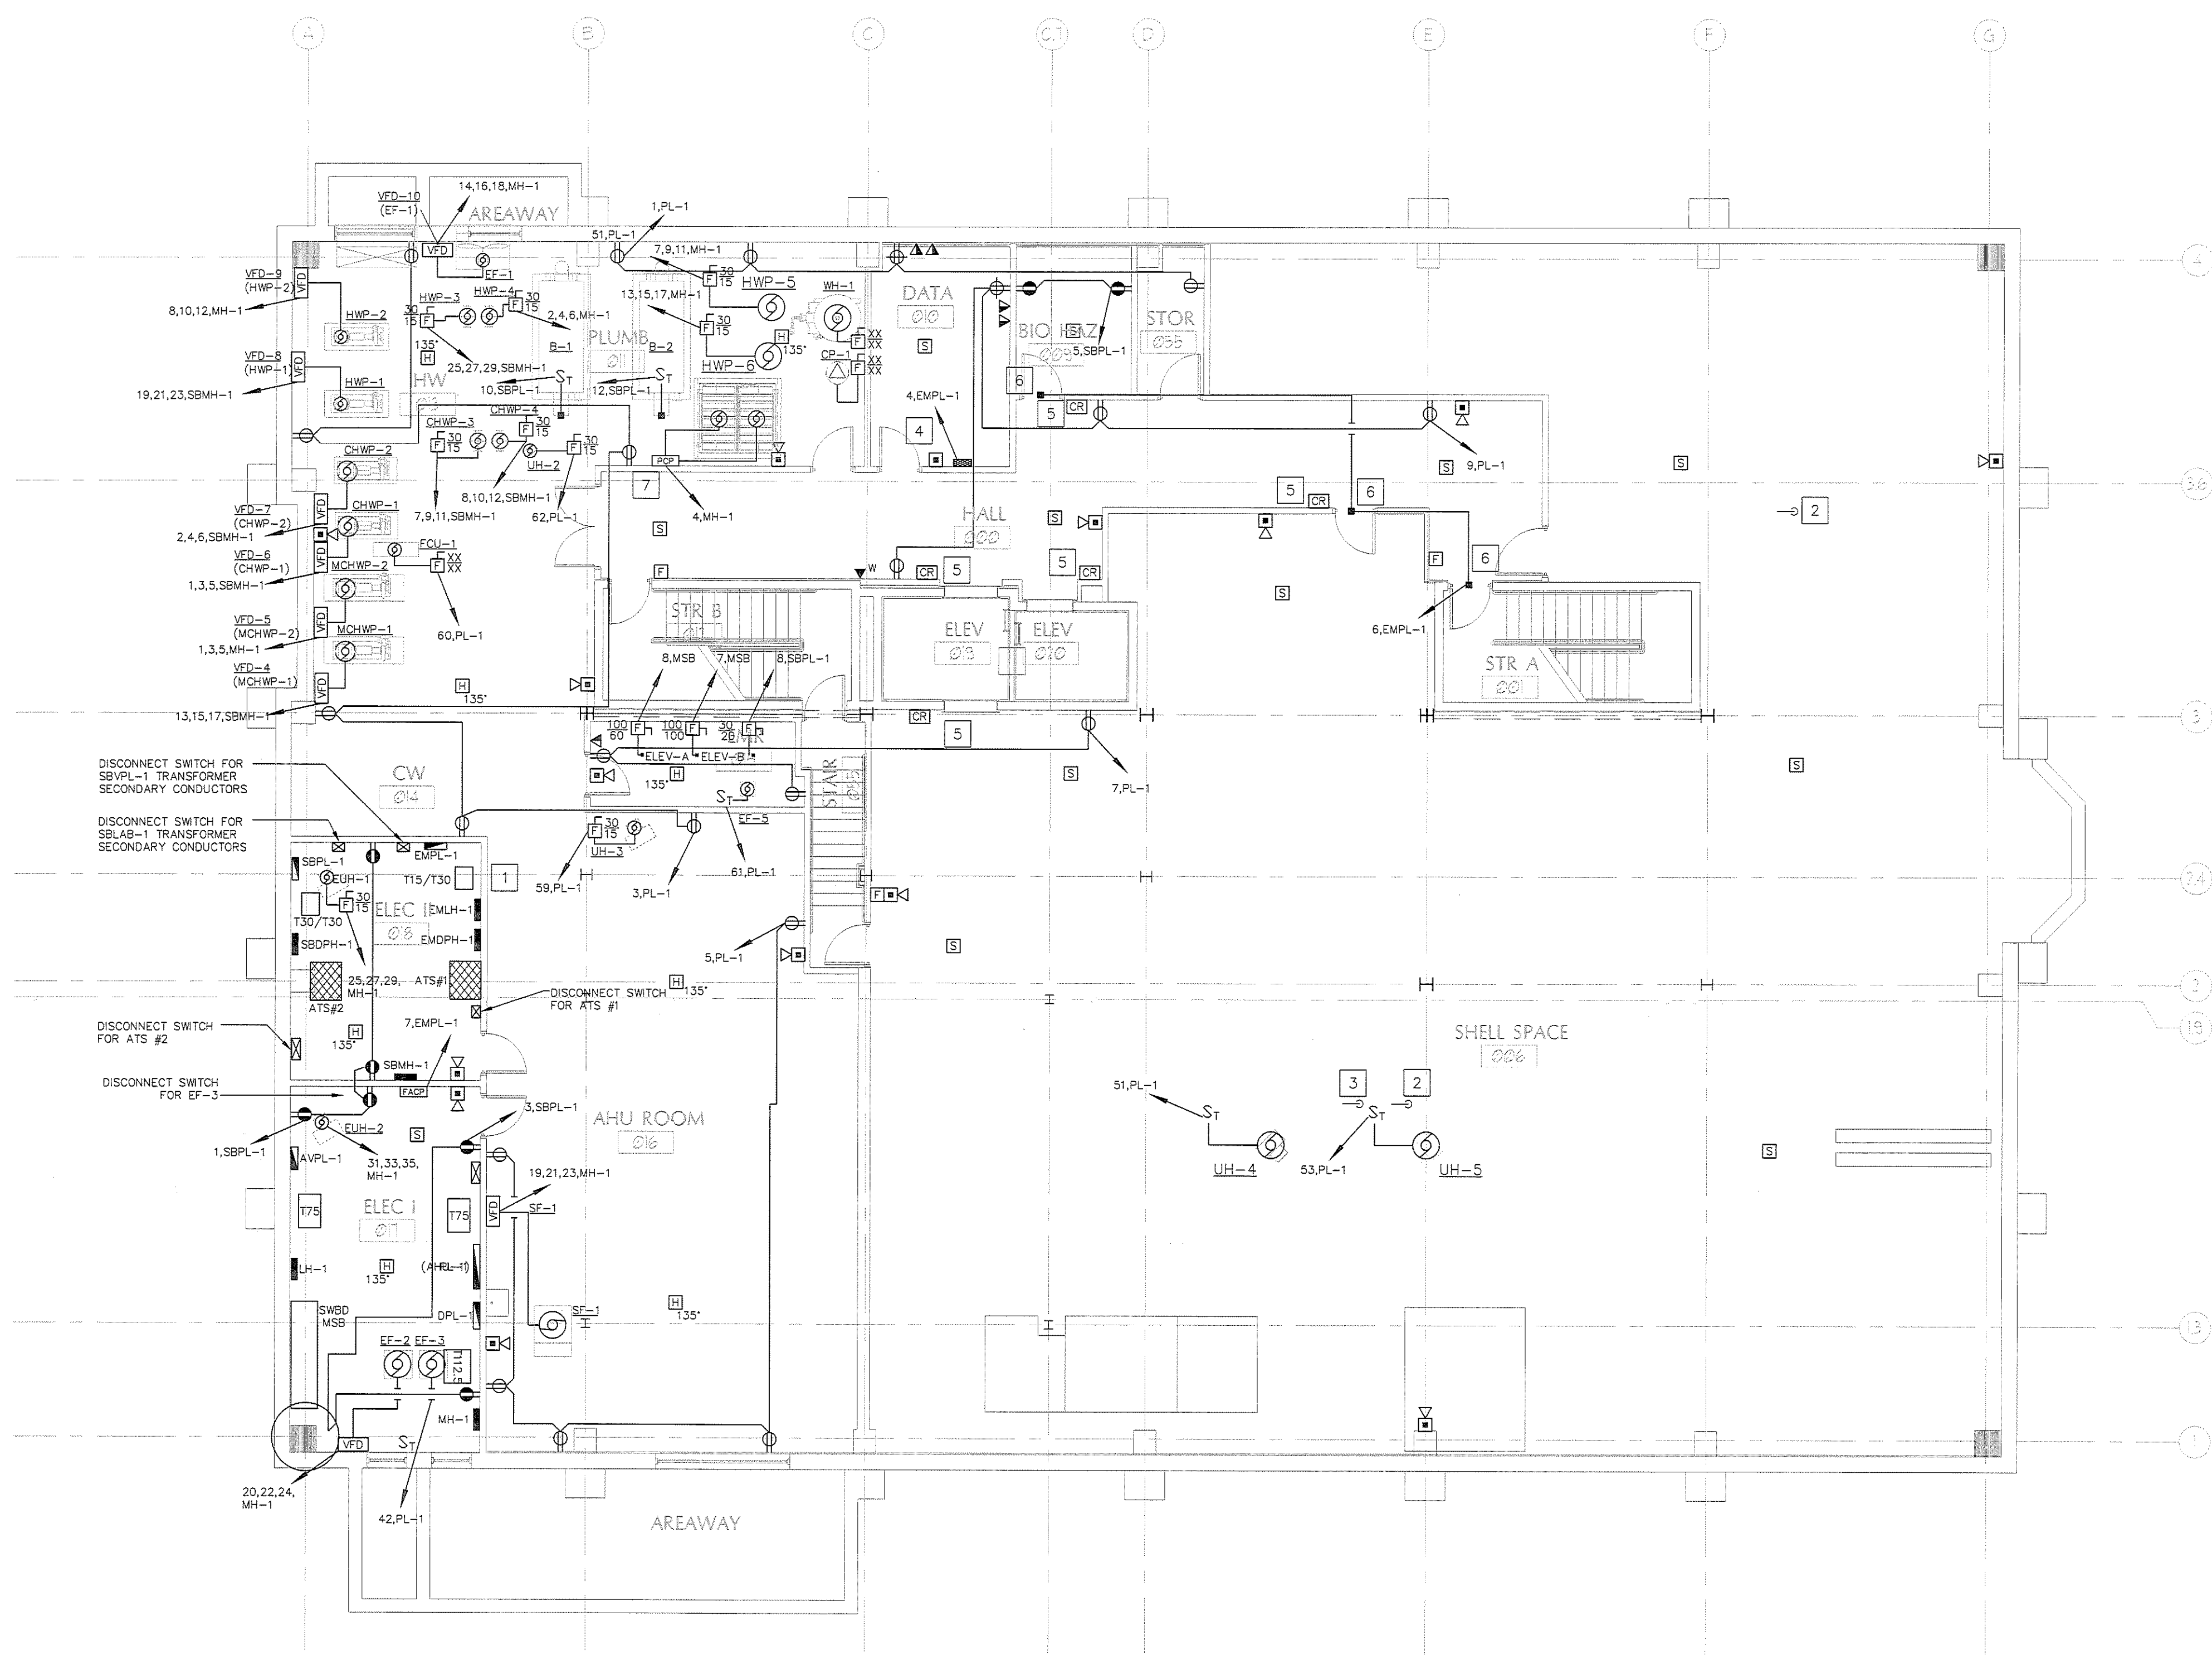

1 LOWER LEVEL POWER PLAN
 Scale: 1/8"=1'-0"

IF THIS SHEET IS NOT 24 X 36 IT IS A REDUCED SCALE PRINT - SCALE ACCORDINGLY

SCALE 1"=1'
 SCALE 3/4"=1'
 SCALE 1/2"=1'
 SCALE 1/4"=1'
 SCALE 1/8"=1'

BID SET - NOT FOR CONSTRUCTION

