


UNIVERSITY OF NEW ENGLAND COLLEGE OF PHARMACY

Portland, Maine

FEBRUARY 8, 2007

LIST OF DRAWINGS

**BID SET
NOT FOR CONSTRUCTION**

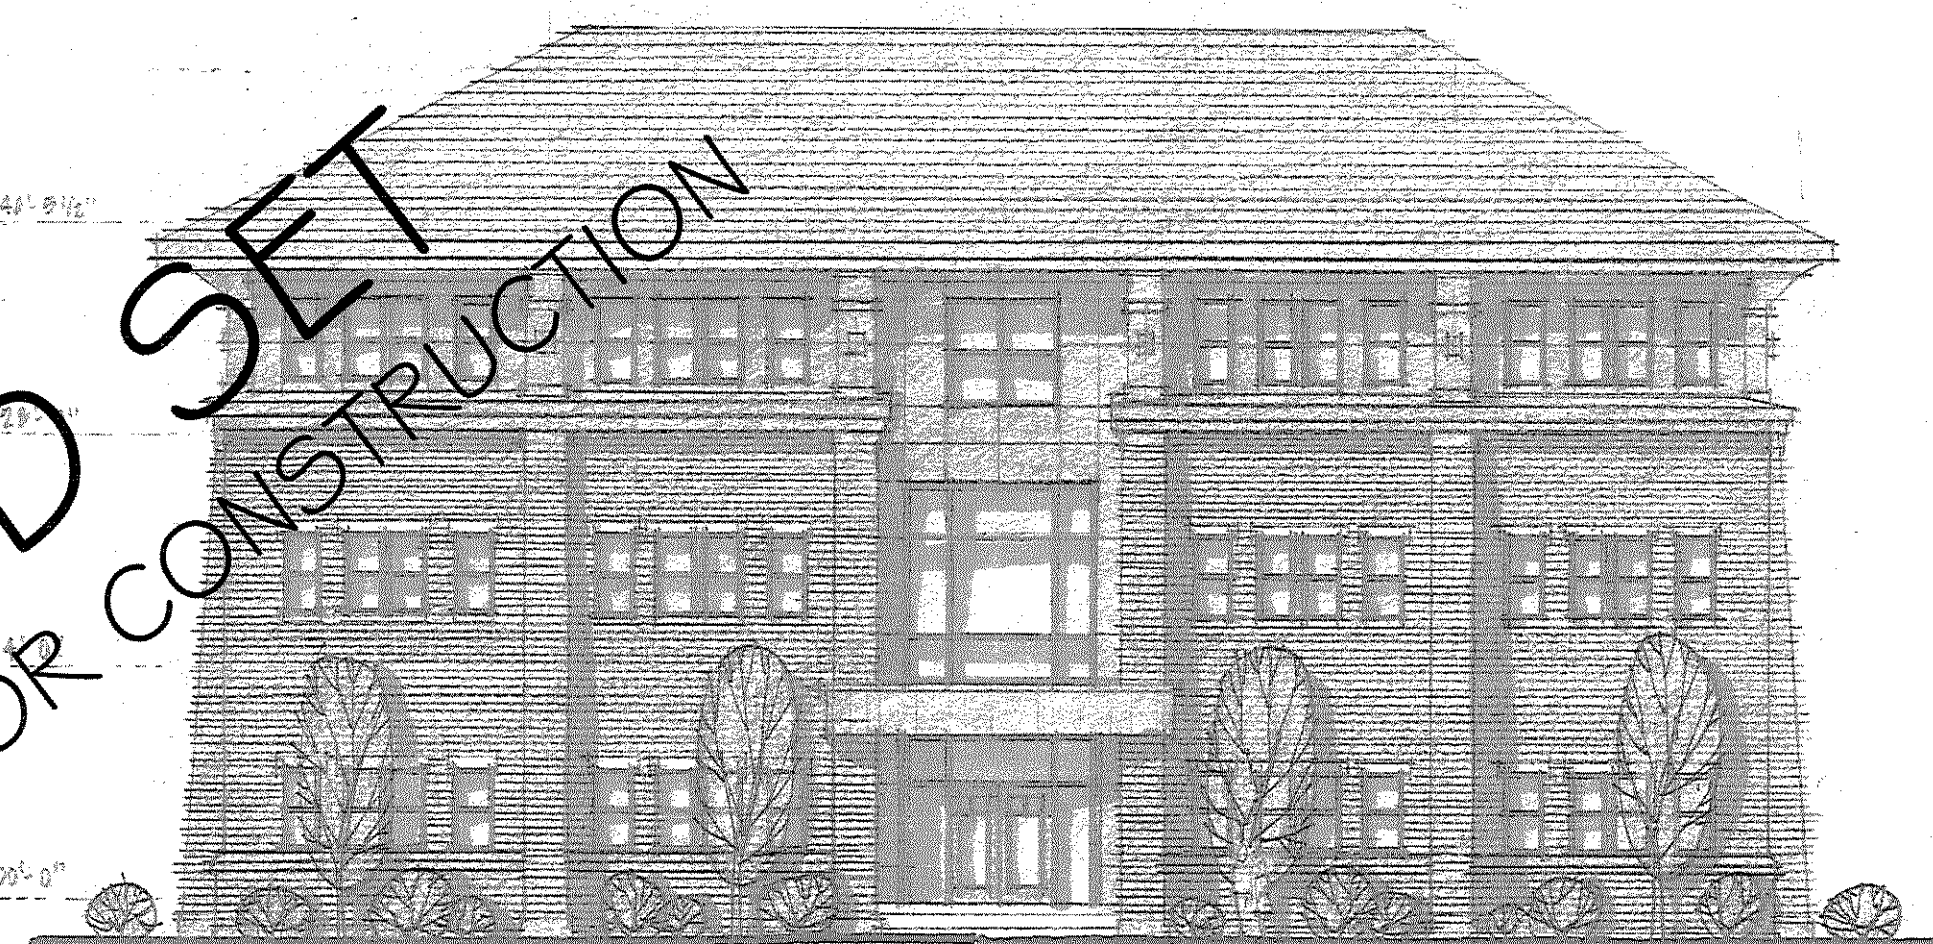

IF THIS SHEET IS NOT 24 X 36 IT IS A REDUCED SCALE PRINT - SCALE ACCORDINGLY

SCALE 1"=1'
SCALE 3/4"=1'
SCALE 1/2"=1'
SCALE 1/4"=1'
SCALE 1/8"=1'
SCALE 1/16"=1'

T1.1	TITLE SHEET - PACKAGE 1	A0.0	WALL TYPES	T2.1	TITLE SHEET - PACKAGE 2	E0.0	ELECTRICAL LEGEND
T1.2	ABBREVIATIONS AND NOTES	A1.0	LOWER LEVEL PLAN (NO VIVARIUM)	F0.1	GENERAL NOTES ETC.	E0.1	ELECTRICAL GENERAL NOTES
-	CAMPUS VICINITY PLAN	A1.1	LOWER LEVEL PLAN	F0.2	GENERAL NOTES ETC.	EL1.0	ELECTRICAL LIGHTING PLAN - LOWER LEVEL
C-100	EXISTING CONDITIONS & DEMOLITION PLAN	A1.2	FIRST FLOOR PLAN	F1.0	LOWER LEVEL W/ VIVARIUM	EL1.1	ELECTRICAL LIGHTING PLAN - LOWER LEVEL - ALT.
C-101	SITE PLAN	A1.3	SECOND FLOOR PLAN	F1.1	FIRST FLOOR	EL1.2	ELECTRICAL LIGHTING PLAN - FIRST FLOOR
C-102	GRADING, DRAINAGE & EROSION CONTROL	A1.4	THIRD FLOOR PLAN	F1.2	SECOND FLOOR	EL1.3	ELECTRICAL LIGHTING PLAN - SECOND FLOOR
C-103	SITE UTILITY PLAN	A1.5	ATTIC PLAN	F1.3	THIRD FLOOR	EL1.4	ELECTRICAL LIGHTING PLAN - THIRD FLOOR
C-104	LANDSCAPE PLAN	A1.6	ROOF PLAN	F2.0	LOWER LEVEL ELEVATIONS	EL1.5	ELECTRICAL LIGHTING PLAN - ATTIC
C-300	EROSION, SEDIMENTATION CONTROL & SPECIFICATIONS	A2.0	LOWER LEVEL RCP PLAN (NO VIVARIUM)	F2.1	FIRST FLOOR ELEVATIONS	EPI.0	ELECTRICAL POWER PLAN - LOWER LEVEL
C-301	SITE DETAILS	A2.1	LOWER LEVEL RCP PLAN	F2.2	SECOND FLOOR ELEVATIONS	EPI.1	ELECTRICAL POWER PLAN - LOWER LEVEL - ALT.
C-302	SITE DETAILS	A2.2	FIRST FLOOR RCP	F2.3	THIRD FLOOR ELEVATIONS	EPI.2	ELECTRICAL POWER PLAN - FIRST FLOOR
C-303	SITE DETAILS	A2.3	SECOND FLOOR RCP	F2.4	THIRD FLOOR ELEVATIONS	EPI.3	ELECTRICAL POWER PLAN - SECOND FLOOR
C-304	SITE DETAILS	A2.4	THIRD FLOOR RCP	F3.1	FIXED CASEWORK DETAILS	EPI.4	ELECTRICAL POWER PLAN - THIRD FLOOR
SU1.1	SITE UTILITY PLAN	A2.5	MECHANICAL MEZZANINE RCP	F3.2	ADD-A-DRAWER CASEWORK & MISC DETAILS	EPI.5	ELECTRICAL POWER PLAN - ATTIC
91.0	GENERAL NOTES	A3.1	EAST & SOUTH ELEVATIONS	F3.3	MOVABLE/FIXED TABLE DETAILS	EPI.6	ELECTRICAL POWER PLAN - ROOF
91.1	FOUNDATION PLAN	A3.2	WEST & NORTH ELEVATION	F3.4	RUMHOOD DETAILS	E2.0	LIGHTING PROTECTION PLAN
91.2	FIRST FLOOR FRAMING PLAN	A4.0	SHORT BUILDING SECTIONS	F3.5	WORKSTATION DETAILS	E2.1	LIGHTING PROTECTION DETAILS
91.3	SECOND FLOOR FRAMING PLAN	A4.1	SHORT BUILDING SECTIONS	M0.1	MECHANICAL LEGENDS	E3.0	ELECTRICAL POWER RISER DIAGRAM
91.4	THIRD FLOOR FRAMING PLAN	A4.2	LONG BUILDING SECTION (ATRIUM)	M1.0	MECHANICAL LOWER LEVEL PLAN	E3.1	LOW-VOLTAGE RISER DIAGRAMS & SCHEDULES
91.5	ATTIC FRAMING PLAN	A4.3	LONG BUILDING SECTION (LECTURE)	M1.1	MECHANICAL LOWER LEVEL PLAN -ALT.	E4.0	ELECTRICAL SCHEDULES
91.6	ROOF FRAMING PLAN	A4.4	WALL SECTIONS	M1.2	MECHANICAL FIRST FLOOR PLAN	E4.1	ELECTRICAL SCHEDULES
91.7	COLUMN SCHEDULE	A4.5	WALL SECTIONS	M1.3	MECHANICAL SECOND FLOOR PLAN	E4.2	ELECTRICAL SCHEDULES
91.8	BRACE FRAME ELEVATIONS	A4.6	WALL SECTIONS	M1.4	MECHANICAL THIRD FLOOR PLAN	E4.3	ELECTRICAL SCHEDULES
92.1	TYPICAL CONCRETE DETAILS	A5.1	STAIR-A PLANS	M1.5	MECHANICAL ATTIC PLAN	E4.4	ELECTRICAL SCHEDULES - ALTERNATE
92.2	CONCRETE SECTIONS	A5.2	STAIR-A SECTIONS	M1.6	MECHANICAL ROOF PLAN	E5.0	ELECTRICAL DETAILS
92.3	CONCRETE SECTIONS	A5.3	STAIR-B & ELEVATOR PLANS	MP1.0	MECHANICAL PIPING LOWER LEVEL BASE PLAN	E5.1	ELECTRICAL DETAILS
92.4	CONCRETE SECTIONS	A5.4	STAIR-B & ELEVATOR PLANS	MP1.1	MECHANICAL PIPING LOWER LEVEL PLAN ALT.	E6.0	CHILLIER PLANT ELECTRICAL PLAN
93.1	FRAMING SECTIONS & DETAILS	A5.5	STAIR-B & ELEVATOR SECTIONS	MP1.2	MECHANICAL PIPING FIRST FLOOR PLAN	P0.1	PLUMBING LEGEND, SCHEDULES AND NOTES
93.2	FRAMING SECTIONS & DETAILS	A5.6	ELEVATOR SECTION W/ DETAILS	MP1.3	MECHANICAL PIPING SECOND FLOOR PLAN	PS1.0	PLUMBING LOWER LEVEL PLAN - SUPPLY
93.3	FRAMING SECTIONS & DETAILS	A5.7	EXTERIOR STAIR PLANS	MP1.4	MECHANICAL PIPING THIRD FLOOR PLAN	PS1.1	PLUMBING LOWER LEVEL PLAN - SUPPLY - ALTERNATE
93.4	FRAMING SECTIONS & DETAILS	A6.0	ADA & BATH INTERIOR ELEVATIONS	M2.0	MECHANICAL LOWER LEVEL MER PART PLAN	PS1.2	PLUMBING FIRST FLOOR PLAN - SUPPLY
93.5	FRAMING SECTIONS & DETAILS	A6.1	LOWER LEVEL INTERIOR ELEVATIONS	M2.1	MECHANICAL LOWER LEVEL MER PART PLAN ALT	PS1.3	PLUMBING SECOND FLOOR PLAN - SUPPLY
		A6.2	1ST FLOOR INTERIOR ELEVATIONS	M2.2	MECHANICAL ATTIC MER PART PLANS	PS1.4	PLUMBING THIRD FLOOR PLAN - SUPPLY
		A6.3	1ST FLOOR INTERIOR ELEVATIONS	M2.3	MECHANICAL ATTIC MER SECTIONS	FUI.0	PLUMBING LOWER LEVEL PLAN - WASTE
		A6.4	1ST FLOOR INTERIOR ELEVATIONS	M2.4	MECHANICAL CHILLER PLANT PART PLANS	FUI.1	PLUMBING LOWER LEVEL PLAN - WASTE - ALTERNATE
		A6.5	1ST FLOOR INTERIOR ELEVATIONS	M3.1	MECHANICAL AIR RISER DIAGRAM	FUI.2	PLUMBING FIRST FLOOR PLAN - WASTE
		A6.6	2ND FLOOR INTERIOR ELEVATIONS	M3.2	MECHANICAL STEAM RISER DIAGRAM	FUI.3	PLUMBING SECOND FLOOR PLAN - WASTE
		A6.7	2ND FLOOR INTERIOR ELEVATIONS	M3.3	MECHANICAL HOT WATER RISER DIAGRAM	FUI.4	PLUMBING THIRD FLOOR PLAN - WASTE
		A6.8	2ND FLOOR INTERIOR ELEVATIONS	M3.4	MECHANICAL CHILLED WATER RISER DIAGRAM		
		A6.9	2ND FLOOR INTERIOR ELEVATIONS	M3.5	MECHANICAL CHILLER PLANT FLOW DIAGRAM		
		A6.10	3RD FLOOR INTERIOR ELEVATIONS	M4.1	MECHANICAL DETAILS	P1.5	PLUMBING ATTIC PLAN
		A6.11	3RD FLOOR INTERIOR ELEVATIONS	M4.2	MECHANICAL DETAILS	P1.6	PLUMBING ROOF PLAN
		A6.12	3RD FLOOR INTERIOR ELEVATIONS	M4.3	MECHANICAL DETAILS	P2.0	PLUMBING THIRD FLOOR PLAN - ENLARGED
		A6.13	3RD FLOOR INTERIOR ELEVATIONS	M4.4	MECHANICAL DETAILS	P2.0	PLUMBING THIRD FLOOR PLAN - ENLARGED
		A6.14	3RD FLOOR INTERIOR ELEVATIONS	M4.5	MECHANICAL DETAILS	P3.0	PLUMBING PURE WATER (RODI) RISER
		A6.15	DETAILS	M4.6	MECHANICAL DETAILS	P3.1	PLUMBING GAS, AIR, AND VACUUM RISER
		A7.1	DOOR SCHEDULE	M5.1	MECHANICAL TEMPERATURE CONTROLS	P4.0	PLUMBING DETAILS
		A7.2	WINDOW SCHEDULE	M5.2	MECHANICAL TEMPERATURE CONTROLS	P4.1	PLUMBING DETAILS
		A7.3	ROOM FINISH SCHEDULE	M5.3	MECHANICAL TEMPERATURE CONTROLS	FP0.1	FIRE PROTECTION LEGEND, SCHEDULE AND NOTES
		A8.1	DETAILS	M6.1	MECHANICAL EQUIPMENT SCHEDULES	FP1.1	FIRE PROTECTION FLOOR PLANS
		A9.3	SECOND FLOOR FINISH PLAN	M6.2	MECHANICAL EQUIPMENT SCHEDULES		
		A9.4	THIRD FLOOR FINISH PLAN	M6.3	MECHANICAL EQUIPMENT SCHEDULES		
		A10.1	CHILLER PLANT	M6.4	MECHANICAL EQUIPMENT SCHEDULES		

PACKAGE 2: FURNISHING, MECHANICAL, ELECTRICAL & PLUMBING

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BECKER
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SYTDDesign CONSULTANTS
CIVIL ENGINEERING & LANDSCAPE ARCHITECTURE

ALLIED/COOK CONSTRUCTION

Favreau ELECTRIC

Titan Mechanical, Inc.
Design Build Engineering - Mechanical Contracting

UNIVERSITY OF NEW ENGLAND
COLLEGE OF PHARMACY
716 STEVENS AVENUE, PORTLAND, ME

#	DATE	DESCRIPTION
		BID SET
Date Issued	02/08/08	
Project Number	06506	
SHEET NAME		
TITLE SHEET 2		
Drawn By	EC, AM, BK	T2.1
Checked By	LAS	

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