
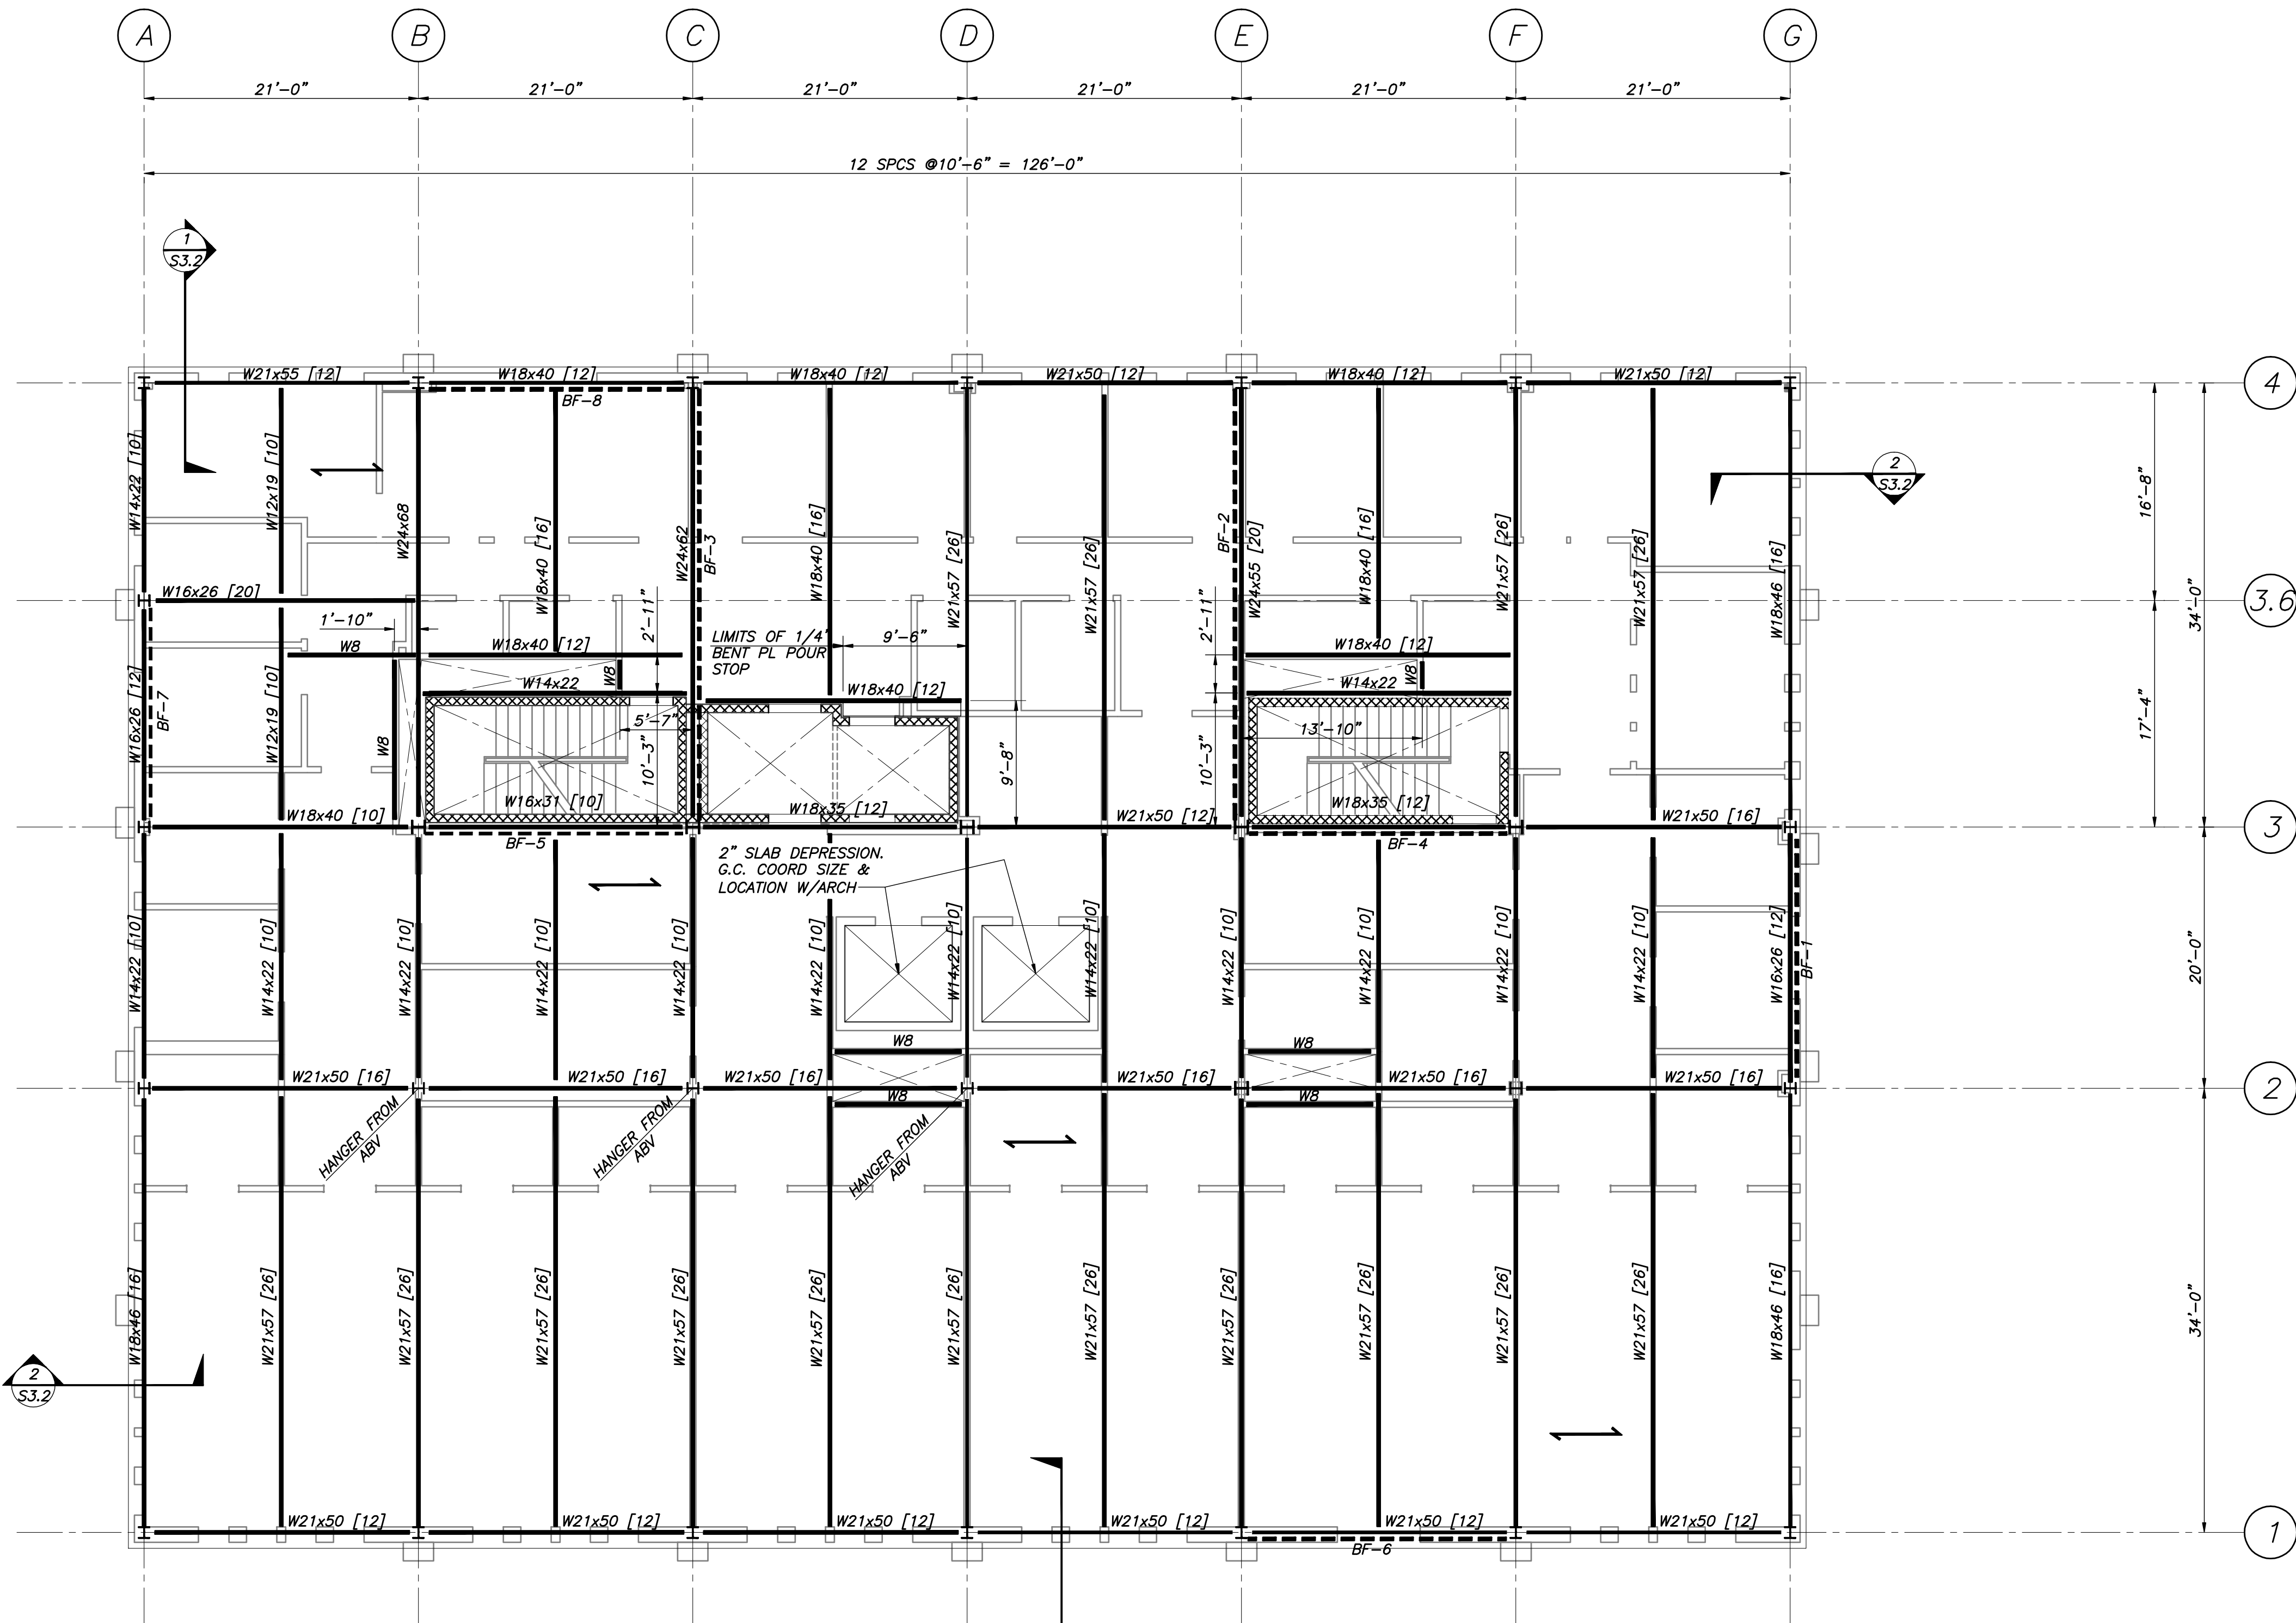



IF THIS SHEET IS NOT 24 X 36 IT IS A REDUCED SCALE PRINT - SCALE ACCORDINGLY

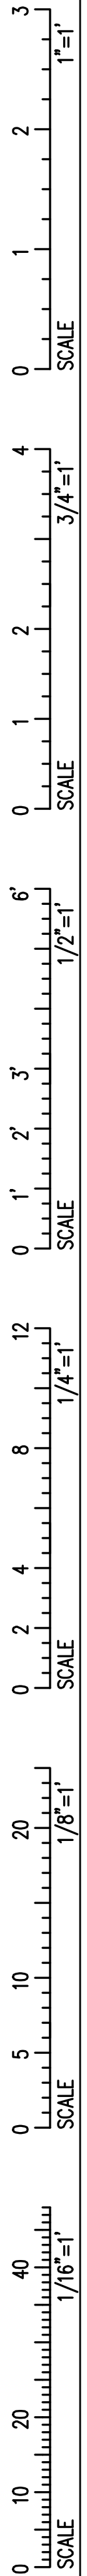

THIRD FLOOR FRAMING PLAN  
1/8"=1'-0"


- NOTES:
- INDICATES DIRECTION OF 6 1/2" NORMAL WEIGHT CONCRETE SLAB ON 3VL1 18GA GALVANIZED METAL DECK (3 1/2" CONCRETE FILL OVER 3" DECK, 3 SPAN MIN), U.N.O. PROVIDE 6x6-W21xW21 W.W.F. TOP OF SLAB EL 126'-8" @ H.P. CONC THICKNESS IS MINIMUM. PROVIDE SUFFICIENT CONC TO ACCOUNT FOR STRUCTURE DEFLECTION. SEE SPECS.
  - TOP OF STEEL EL 126'-1 1/2" U.N.O.
  - [XX], ETC INDICATES 3/4"x5 1/2" LG HEADED SHEAR STUDS SPACED UNIFORMLY ALONG BEAM OR BTWN CONCENTRATED LOADS (U.N.O.).
  - C=1", ETC INDICATES THE AMOUNT OF POSITIVE CAMBER REQD AT MIDSPAN OF STRUCT MEMBER
  - INDICATES BRACING. SEE BRACING ELEVATIONS DWG S1.8.
  - INDICATES MOMENT CONNECTION. SEE DETAILS.
  - REINFORCE CONC SLABS AROUND ALL FLOOR PENETRATIONS PER TYPICAL DETAILS DWG S3.1, U.N.O. COORD ALL OPENING SIZES & LOCATIONS W/ARCH & OTHER DISCIPLINES DWGS.
  - UNLESS NOTED OTHERWISE, BEAMS TO BE PLACED AT EQUAL SPACES BETWEEN COL LINES.
  - FOR COMPOSITE BEAM END REACTIONS, SEE SIMPLE SHEAR BEAM CONNECTION SCHEDULE, DWG S3.1.
  - FOR COLUMN SIZES, SEE COLUMN SCHEDULE, DWG S1.7.
  - WB INDICATES WBx15 FRAMING AT FLOOR PENETRATIONS.

PERMIT SET - NOT FOR CONSTRUCTION

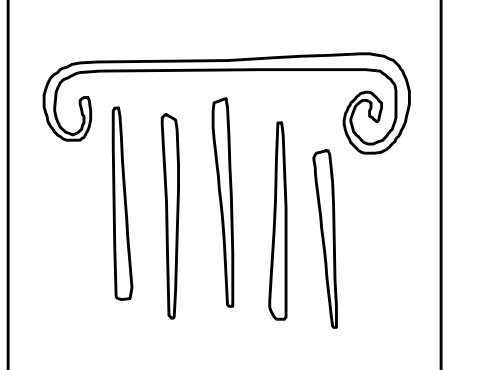

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ALLIED/COOK CONSTRUCTION

Favreau ELECTRIC

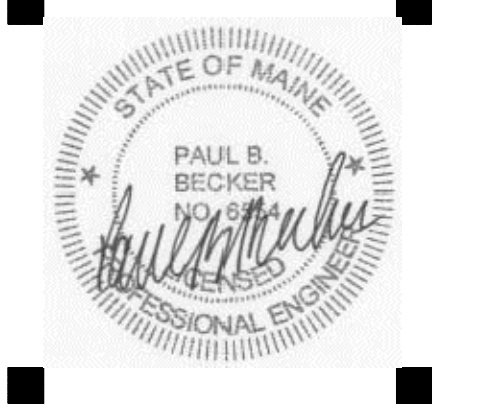Titan Mechanical, Inc.  
Design-Build Engineering - Mechanical Contracting

UNIVERSITY OF NEW ENGLAND

COLLEGE OF PHARMACY

716 STEVENS AVENUE, PORTLAND, ME

#	DATE	DESCRIPTION
		PERMIT SET
	01/24/08	Date Issued
	06506	Project Number

SHEET NAME  
THIRD FLOOR FRAMING PLAN

Drawn By  
APP  
Checked By  
DSB

S1.4