
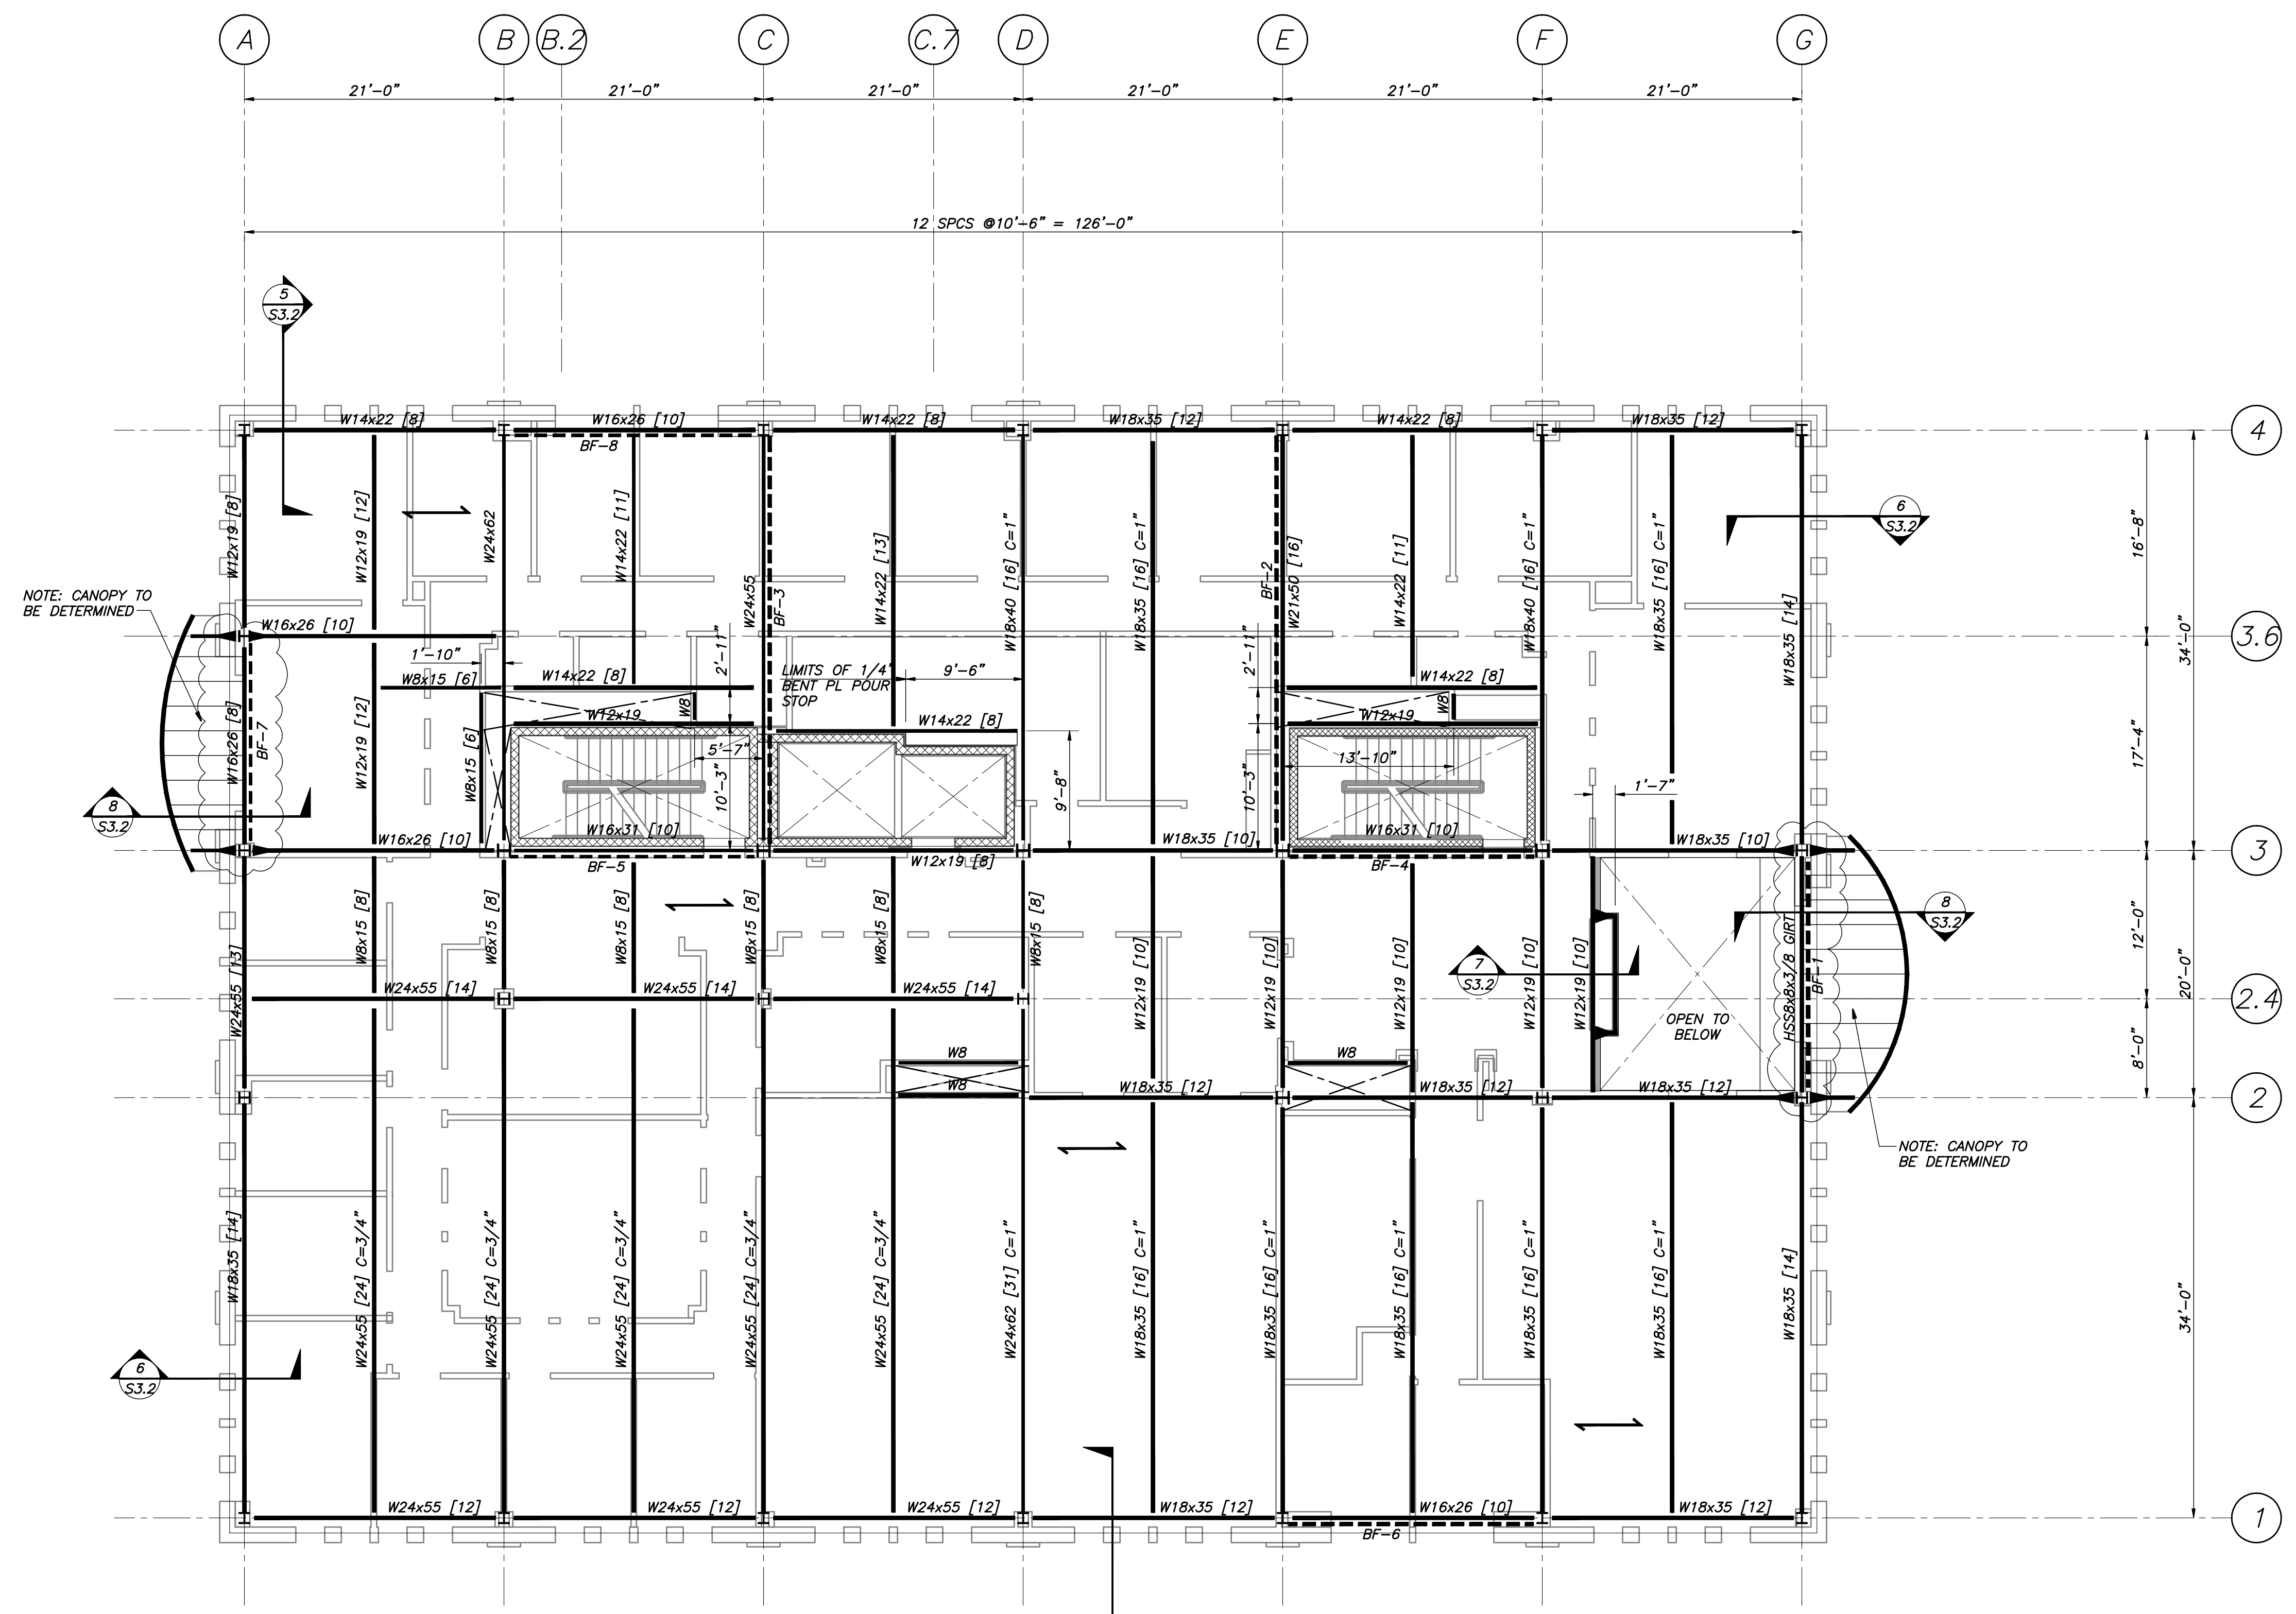



IF THIS SHEET IS NOT 24 X 36 IT IS A REDUCED SCALE PRINT - SCALE ACCORDINGLY

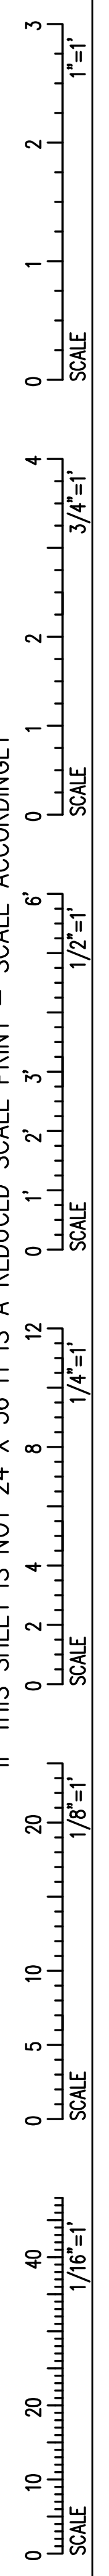

SECOND FLOOR FRAMING PLAN
1/8"=1'-0"


- NOTES:**
- INDICATES DIRECTION OF 5 1/2" NORMAL WEIGHT CONCRETE SLAB ON 3VL1 18GA GALVANIZED METAL DECK (2 1/2" CONCRETE FILL OVER 3" DECK; 3 SPAN MIN), U.N.O. PROVIDE 6x6-W2.1xW2.1 W.W.F. TOP OF SLAB EL 113'-4" @ H.P. CONC THICKNESS IS MINIMUM. PROVIDE SUFFICIENT CONC TO ACCOUNT FOR STRUCTURE DEFLECTION. SEE SPECS.
 - TOP OF STEEL EL 112'-10 1/2" U.N.O.
 - [XX], ETC INDICATES 3/4"x4 1/2" LG HEADED SHEAR STUDS SPACED UNIFORMLY ALONG BEAM OR BTWN CONCENTRATED LOADS (U.N.O.).
 - C=1", ETC INDICATES THE AMOUNT OF POSITIVE CAMBER REQD AT MIDSPAN OF STRUCT MEMBER
 - BF-1 INDICATES BRACING. SEE BRACING ELEVATIONS DWG S1.8.
 - INDICATES MOMENT CONNECTION. SEE DETAILS.
 - REINFORCE CONC SLABS AROUND ALL FLOOR PENETRATIONS PER TYPICAL DETAILS DWG S3.1, U.N.O. COORD ALL OPENING SIZES & LOCATIONS W/ARCH & OTHER DISCIPLINES DWGS.
 - UNLESS NOTED OTHERWISE, BEAMS TO BE PLACED AT EQUAL SPACES BETWEEN COL LINES.
 - FOR COMPOSITE BEAM END REACTIONS, SEE SIMPLE SHEAR BEAM CONNECTION SCHEDULE, DWG S3.1.
 - FOR COLUMN SIZES, SEE COLUMN SCHEDULE, DWG S1.7.
 - W8 INDICATES W8x15 FRAMING AT FLOOR PENETRATIONS.

PERMIT SET - NOT FOR CONSTRUCTION

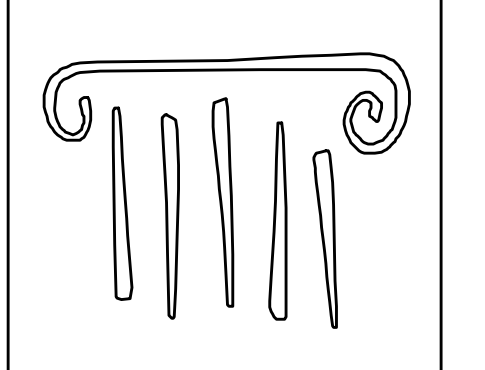

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ALLIED/COOK CONSTRUCTION

Favreau electric

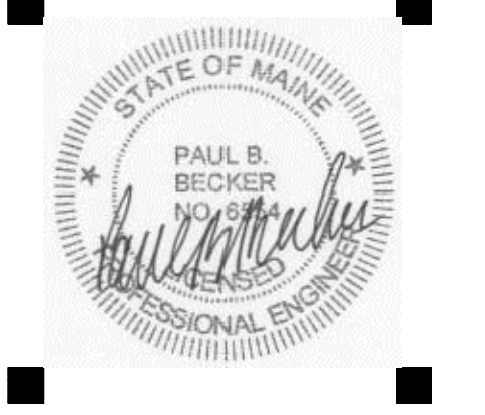Titan Mechanical, Inc.
Design Build Engineering - Mechanical Contracting

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COLLEGE OF PHARMACY

716 STEVENS AVENUE, PORTLAND, ME

#	DATE	DESCRIPTION
		PERMIT SET
	01/24/08	Date Issued
	06506	Project Number

SHEET NAME
SECOND FLOOR FRAMING PLAN

Drawn By
APP
Checked By
DSB

S1.3