
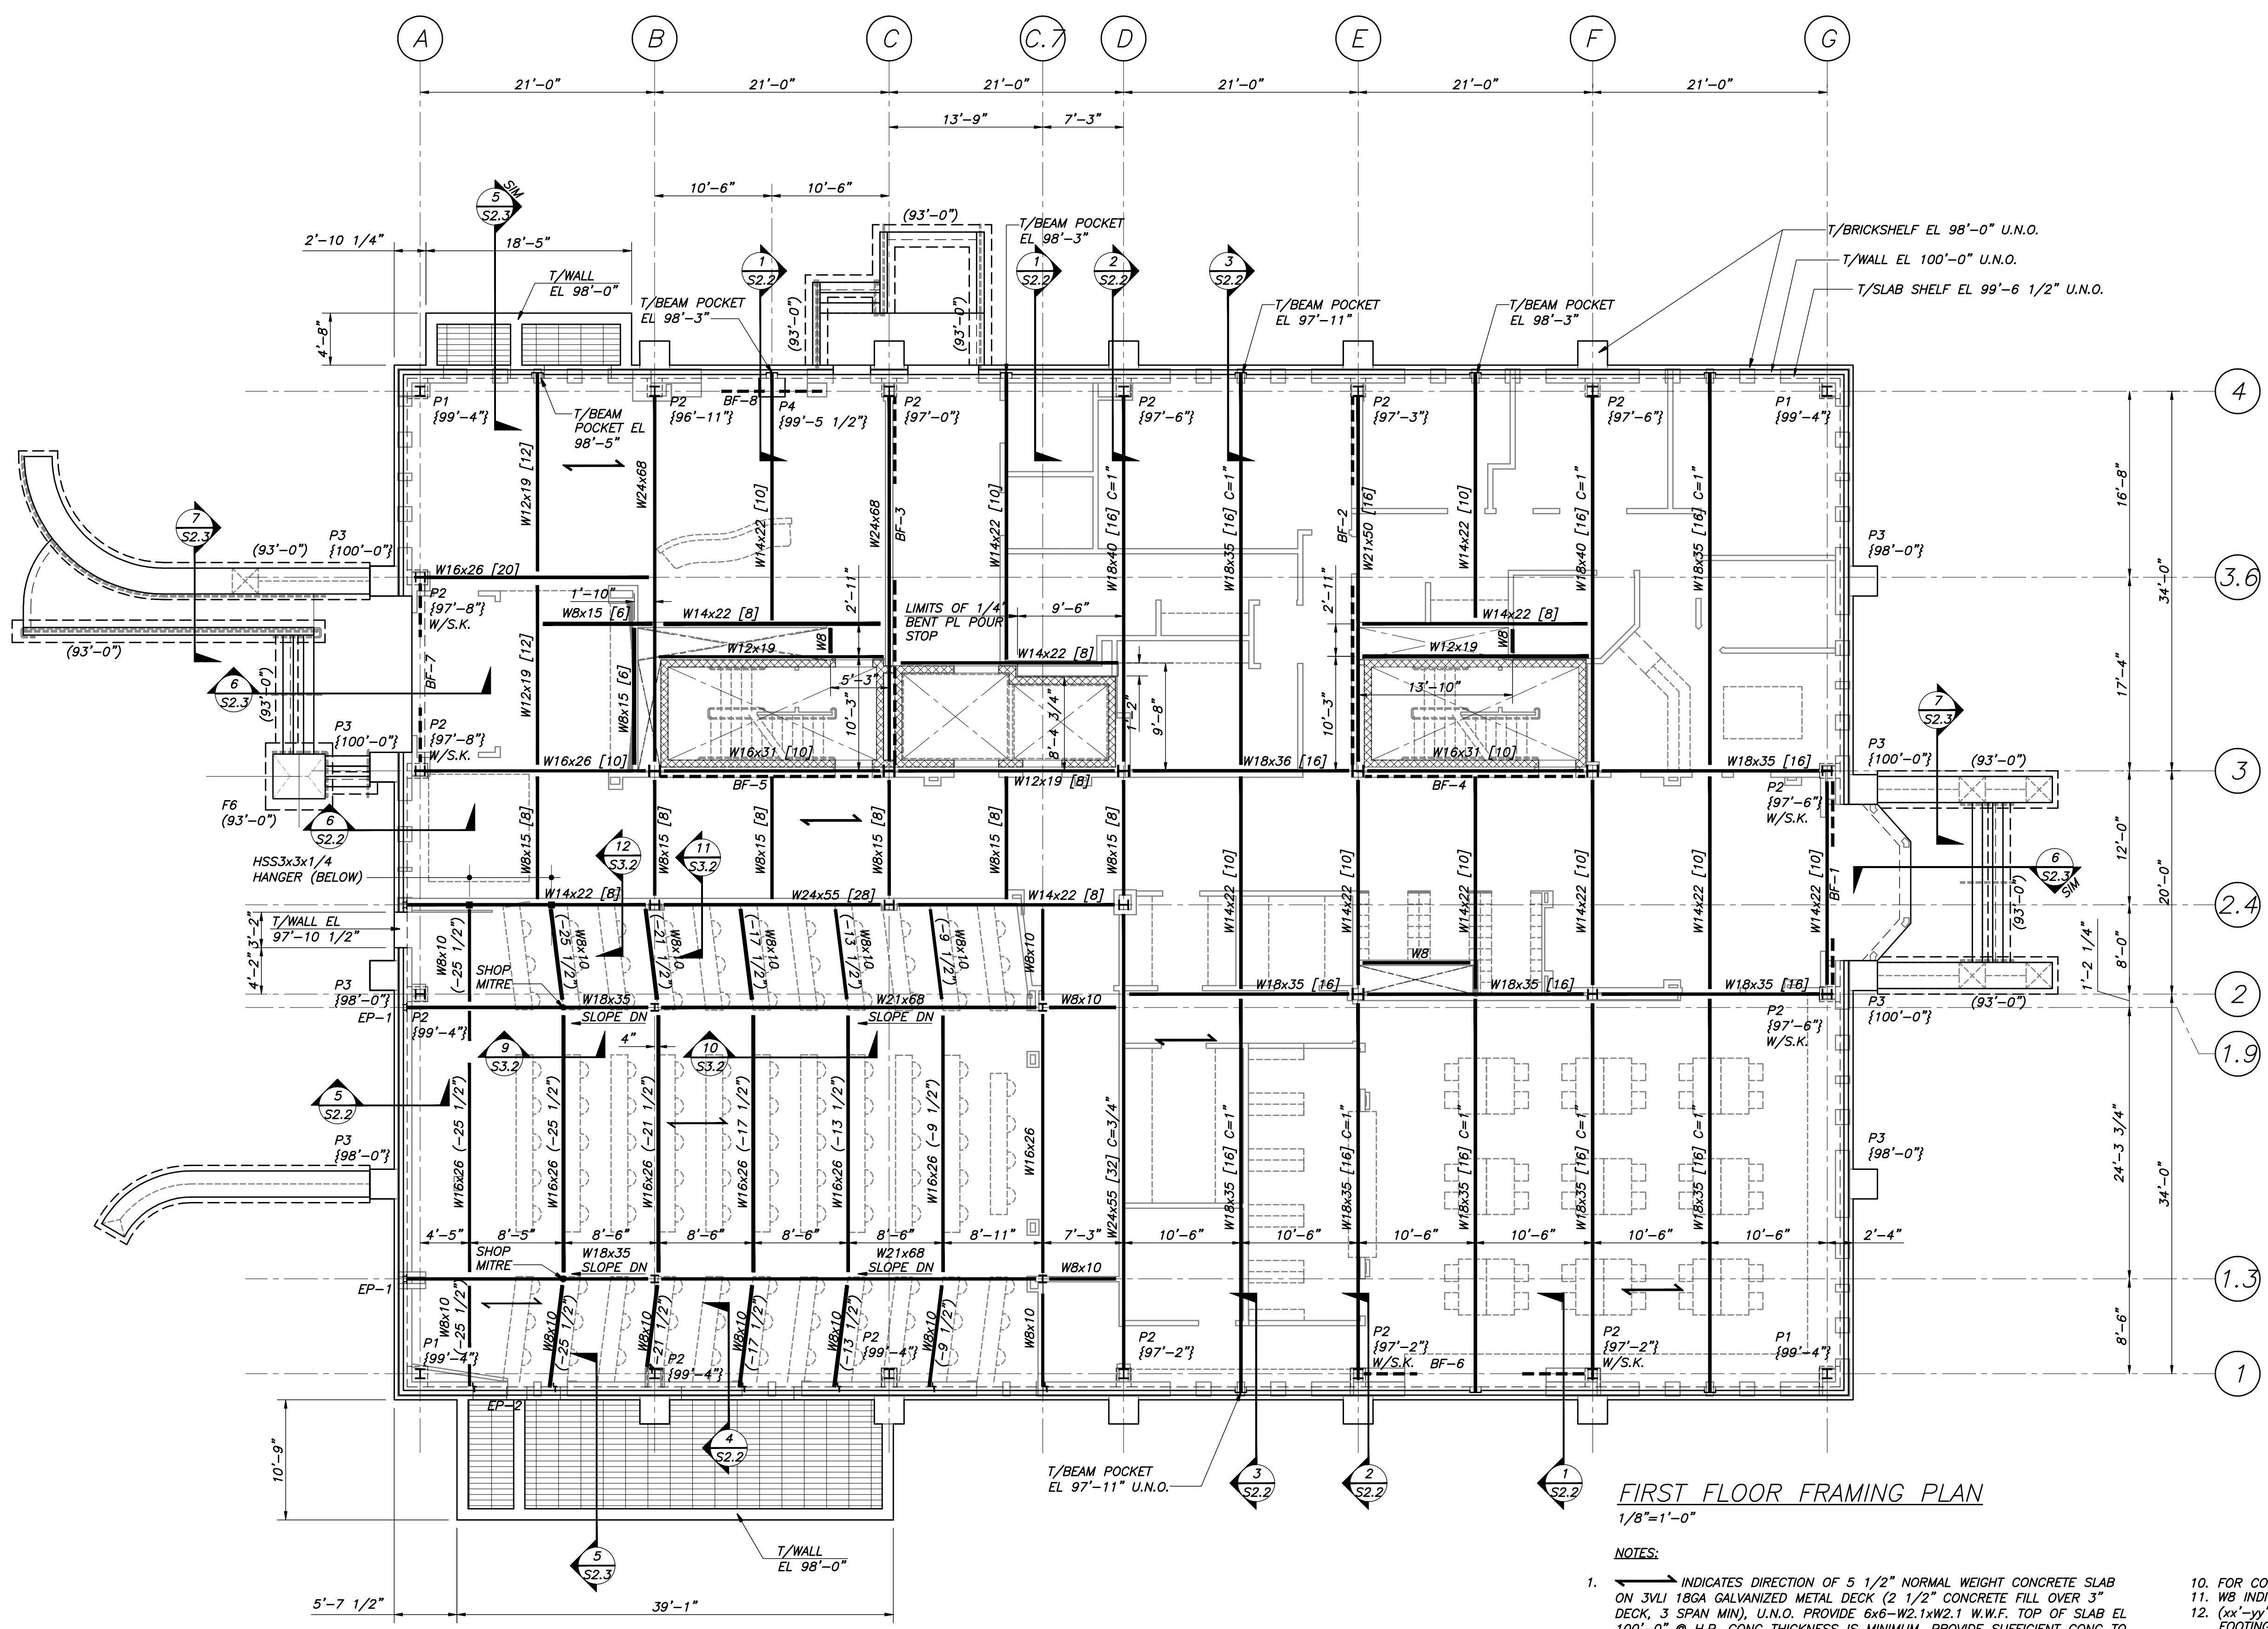



IF THIS SHEET IS NOT 24 X 36 IT IS A REDUCED SCALE PRINT - SCALE ACCORDINGLY

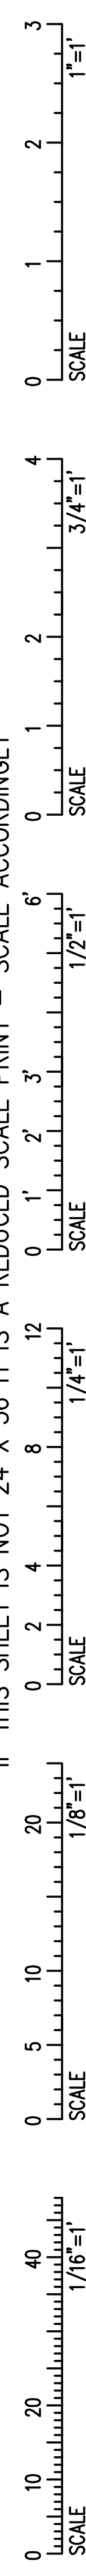

**FIRST FLOOR FRAMING PLAN**  
1/8"=1'-0"


- NOTES:**
- INDICATES DIRECTION OF 5 1/2" NORMAL WEIGHT CONCRETE SLAB ON 3VL1 18GA GALVANIZED METAL DECK (2 1/2" CONCRETE FILL OVER 3" DECK, 3 SPAN MIN), U.N.O. PROVIDE 6x6-W2.1x2.1 W.W.F. TOP OF SLAB EL 100'-0" @ H.P. CONC THICKNESS IS MINIMUM. PROVIDE SUFFICIENT CONC TO ACCOUNT FOR STRUCTURE DEFLECTION. SEE SPECS.
  - TOP OF STEEL EL 99'-5 1/2" U.N.O.
  - [XX], ETC INDICATES 3/4"x4 1/2" LG HEADED SHEAR STUDS SPACED UNIFORMLY ALONG BEAM OR BTWN CONCENTRATED LOADS (U.N.O.).
  - C=1", ETC INDICATES THE AMOUNT OF POSITIVE CAMBER REQD AT MIDSPAN OF STRUCT MEMBER
  - BF-1 INDICATES BRACING. SEE BRACING ELEVATIONS DWG S1.8.
  - INDICATES MOMENT CONNECTION. SEE DETAILS.
  - REINFORCE CONC SLABS AROUND ALL FLOOR PENETRATIONS PER TYPICAL DETAILS DWG S3.1. U.N.O. COORD ALL OPENING SIZES & LOCATIONS W/ARCH & OTHER DISCIPLINES DWGS.
  - UNLESS NOTED OTHERWISE, BEAMS TO BE PLACED AT EQUAL SPACES BETWEEN COL LINES.
  - FOR COMPOSITE BEAM END REACTIONS, SEE SIMPLE SHEAR BEAM CONNECTION SCHEDULE, DWG S3.1.
  - FOR COLUMN SIZES, SEE COLUMN SCHEDULE, DWG S1.7.
  - WB INDICATES W8x15 FRAMING AT FLOOR PENETRATIONS.
  - (xx'-yy') INDICATES TOP OF FOOTING ELEVATION. SEE DWG SCHEDULE.
  - Px INDICATES PIER DESIGNATION. SEE PIER DETAILS DWG S2.

**PERMIT SET - NOT FOR CONSTRUCTION**

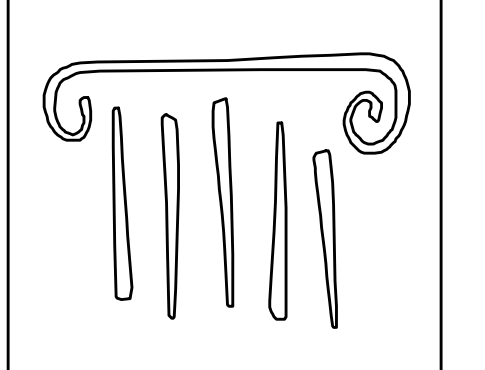

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**COLLEGE OF PHARMACY**

716 STEVENS AVENUE, PORTLAND, ME
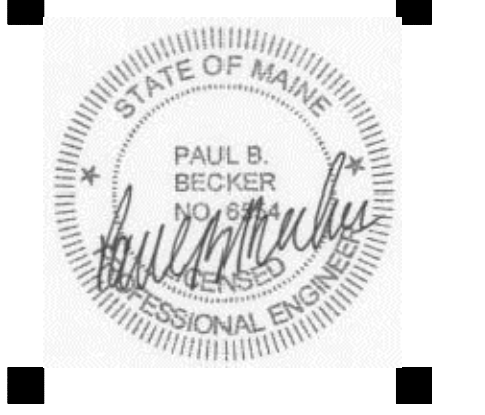
#	DATE	DESCRIPTION
		PERMIT SET
Date Issued	01/24/08	
Project Number	06506	

SHEET NAME  
**FIRST FLOOR FRAMING PLAN**

Drawn By  
APP  
Checked By  
DSB

**S1.2**