



IF THIS SHEET IS NOT 24 X 36 IT IS A REDUCED SCALE PRINT - SCALE ACCORDINGLY

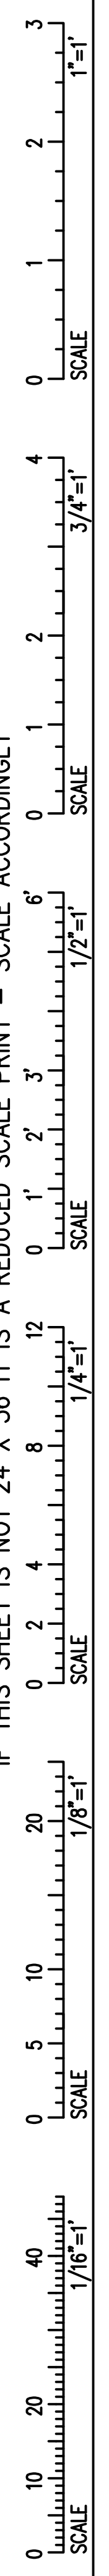


**1** LOWER LEVEL POWER PLAN - BASE BID  
Scale: 1/8"=1'-0"

- NOTES:
1. TOP STACKED 30KVA TRANSFORMER IS ALTERNATE.
  2. BASE BID: INSTALL CONDUIT FROM ROOM "ELECT I" FOR FEEDER FOR FUTURE PANELBOARD INSTALLATION. SEE DRAWING EP1.1 FOR PANELBOARD LOCATION. SEE DRAWINGS E3.0 AND E3.1 FOR CONDUIT SIZE. PROVIDE PULL STRING IN CONDUIT AND CAP AND SEAL CONDUIT.
  3. BASE BID: INSTALL CONDUIT FROM ROOM "ELEC II" FOR FEEDER FOR FUTURE PANELBOARD INSTALLATION. SEE DRAWING EP1.1 FOR PANELBOARD LOCATION. SEE DRAWINGS E3.0 AND E3.1 FOR CONDUIT SIZE. PROVIDE PULL STRING IN CONDUIT AND CAP AND SEAL CONDUIT.

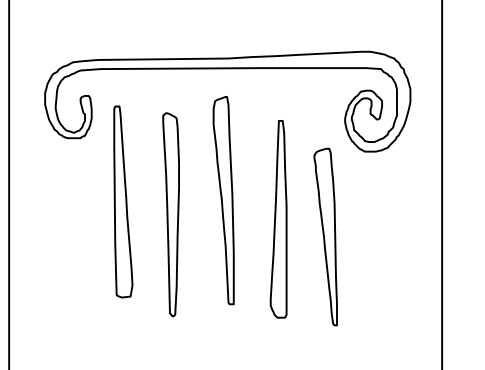

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PROJECT NO.: 2007120.00

**BECKER**  
structural engineers, inc.

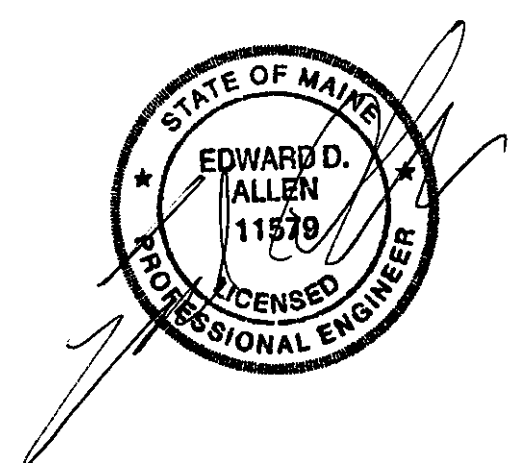**SYTDesign**  
CONSULTANTS  
CIVIL ENGINEERING & LANDSCAPE ARCHITECTURE

**ALLIED/COOK**  
CONSTRUCTION

**Favreau**  
MECHANICAL

**Titan Mechanical, Inc.**  
Design-Build Engineering - Mechanical Contracting


#	DATE	DESCRIPTION
		PERMIT SET
	01/24/08	Date Issued
	06506	Project Number

SHEET NAME  
**ELECTRICAL POWER PLAN - LOWER LEVEL**

Drawn By  
**AMM**

Checked By  
**MER**

**EP1.0**

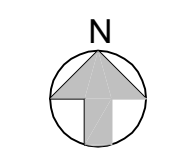

**PERMIT SET - NOT FOR CONSTRUCTION**