


LEGEND:

- EXISTING TREE TYPICAL MATURE SIZE
- EXISTING DECIDUOUS TREE
- EXISTING DECIDUOUS TREE WITH MULCH RING
- EXISTING CONIFEROUS TREE
- EXISTING CONIFEROUS TREE
- EXISTING POLE & LIGHT FIXTURE
- EXISTING BENCH
- EXISTING MOVABLE CHAIR

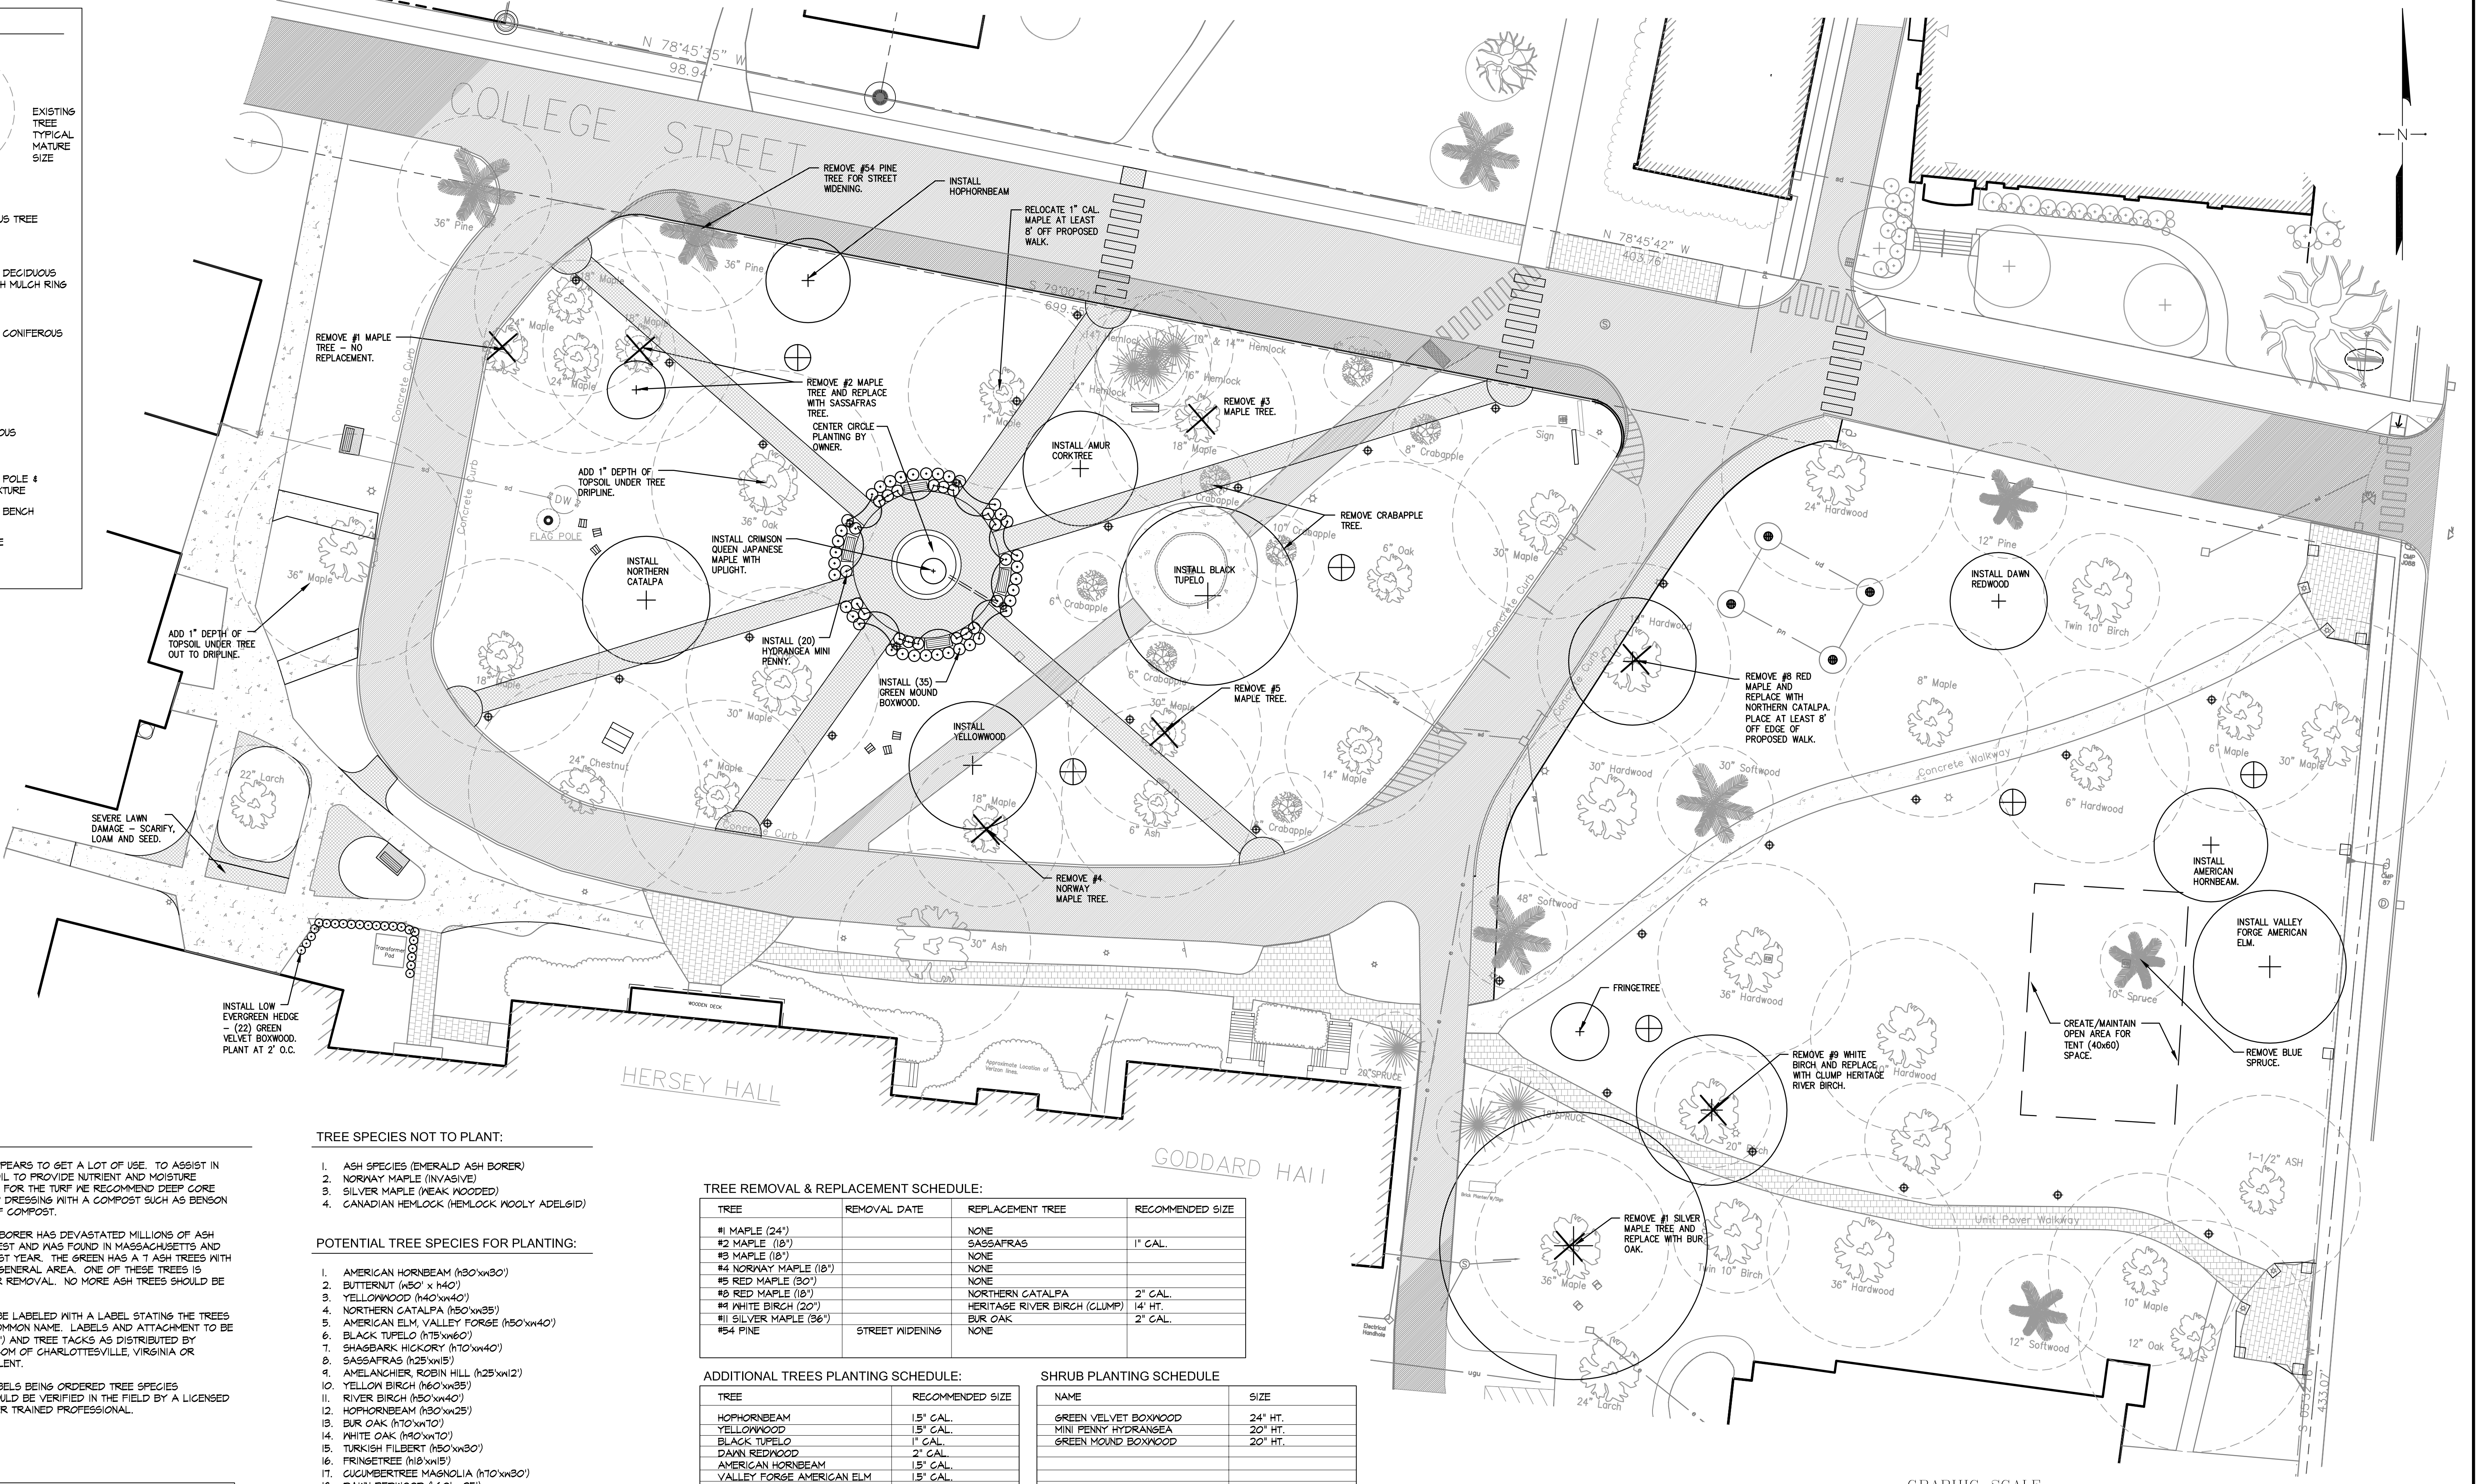

- PLAN NOTES:**
- THE LAWN AREA APPEARS TO GET A LOT OF USE. TO ASSIST IN BUILDING UP THE SOIL TO PROVIDE NUTRIENT AND MOISTURE HOLDING CAPACITY FOR THE TURF WE RECOMMEND DEEP CORE AERATION AND TOP DRESSING WITH A COMPOST SUCH AS BENSON FARMS SURF & TURF COMPOST.
 - THE EMERALD ASH BORER HAS DEVASTATED MILLIONS OF ASH TREES IN THE MIDWEST AND HAS FOUND IN MASSACHUSETTS AND NEW HAMPSHIRE LAST YEAR. THE GREEN HAS A T ASH TREES WITH 5 OF THE T IN ONE GENERAL AREA. ONE OF THESE TREES IS RECOMMENDED FOR REMOVAL. NO MORE ASH TREES SHOULD BE PLANTED.
 - ALL TREES SHALL BE LABELED WITH A LABEL STATING THE TREES BOTANICAL AND COMMON NAME. LABELS AND ATTACHMENT TO BE TREE LABELS (3"x4") AND TREE TACKS AS DISTRIBUTED BY GARDENMARKERS.COM OF CHARLOTTESVILLE, VIRGINIA OR APPROVED EQUIVALENT.
 - PRIOR TO TREE LABELS BEING ORDERED TREE SPECIES IDENTIFICATION SHOULD BE VERIFIED IN THE FIELD BY A LICENSED ARBORIST OR OTHER TRAINED PROFESSIONAL.
- SCULPTURE**
- THERE ARE MANY LAWN AREAS WHICH WOULD BE CONDUCTIVE TO THE PLACEMENT OF A SCULPTURE TO PROVIDE INTEREST TO THOSE PASSING THROUGH THE GREEN.

- TREE SPECIES NOT TO PLANT:**
- ASH SPECIES (EMERALD ASH BORER)
 - NORWAY MAPLE (INVASIVE)
 - SILVER MAPLE (WEAK WOODED)
 - CANADIAN HEMLOCK (HEMLOCK WOOLY ADELGID)
- POTENTIAL TREE SPECIES FOR PLANTING:**
- AMERICAN HORNBREAM (h30'xw30')
 - BUTTERNUT (h50' x h40')
 - YELLOWWOOD (h40'xw40')
 - NORTHERN CATALPA (h50'xw35')
 - AMERICAN ELM, VALLEY FORGE (h50'xw40')
 - BLACK TUPELO (h15'xw60')
 - SHAGBARK HICKORY (h70'xw40')
 - SASSAFRAS (h25'xw15')
 - AMELANCHIER, ROBIN HILL (h25'xw12')
 - YELLOW BIRCH (h60'xw35')
 - RIVER BIRCH (h50'xw40')
 - HOPHORNBEAM (h30'xw25')
 - BUR OAK (h70'xw70')
 - WHITE OAK (h90'xw70')
 - TURKISH FILBERT (h50'xw20')
 - FRINGETREE (h18'xw15')
 - CULMBERTREE MAGNOLIA (h70'xw30')
 - DAWN REDWOOD (h60'xw25')
 - AMUR CORKTREE, MACHO (h35'xw30')
 - GINKGO BILOBA, SARATOGA (h65'xw40')

TREE REMOVAL & REPLACEMENT SCHEDULE:

TREE	REMOVAL DATE	REPLACEMENT TREE	RECOMMENDED SIZE
#1 MAPLE (24')		NONE	
#2 MAPLE (18')		SASSAFRAS	1" CAL.
#3 MAPLE (18')		NONE	
#4 NORWAY MAPLE (18')		NONE	
#5 RED MAPLE (30')		NONE	
#6 RED MAPLE (18')		NORTHERN CATALPA	2" CAL.
#7 WHITE BIRCH (20')		HERITAGE RIVER BIRCH (CLUMP)	14' HT.
#8 SILVER MAPLE (36')		BUR OAK	2" CAL.
#54 PINE	STREET WIDENINGS	NONE	


ADDITIONAL TREES PLANTING SCHEDULE:

TREE	RECOMMENDED SIZE
HOPHORNBEAM	15" CAL.
YELLOWWOOD	15" CAL.
BLACK TUPELO	1" CAL.
DAWN REDWOOD	2" CAL.
AMERICAN HORNBREAM	15" CAL.
VALLEY FORGE AMERICAN ELM	15" CAL.
FRINGETREE	1" CAL.
MACHO AMUR CORKTREE	15" CAL.
CRIMSON QUEEN JAPANESE MAPLE	20" CAL.


SHRUB PLANTING SCHEDULE

NAME	SIZE
GREEN VELVET BOXWOOD	24" HT.
MINI PENNY HYDRANGEA	20" HT.
GREEN MOUND BOXWOOD	20" HT.

** THIS TREE IS TO BE A SPECIMEN AND MUST BE APPROVED BY THE LANDSCAPE ARCHITECT PRIOR TO PURCHASING.

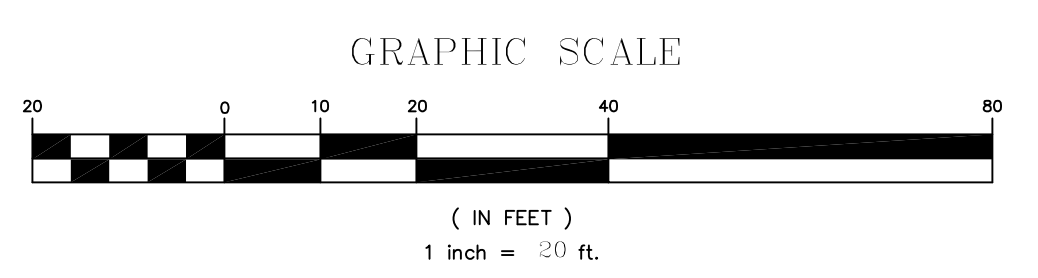


REV.	DATE	STATUS	BY	CHKD.	APPD.	REV.	DATE	STATUS	BY	CHKD.	APPD.
A	5/23/14	ISSUED TO OWNER FOR REVIEW	DEPT.	PBB	PBB						

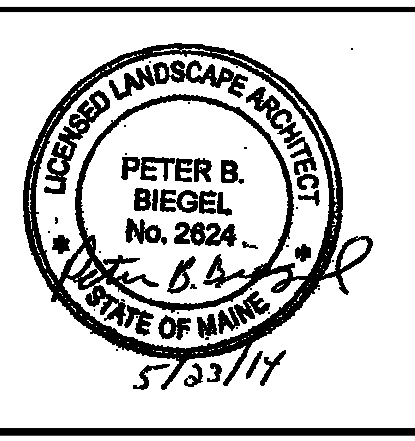


LAND DESIGN SOLUTIONS
 LAND PLANNING, SITE PLANNING & LANDSCAPE ARCHITECTURE
 P.O. Box 316, 160 Longwoods Road, Cumberland, ME 04081 tel: (207) 494-7171
 CLIENT & OWNER:
UNIVERSITY OF NEW ENGLAND
 11 HILLS BEACH ROAD, BIDDEFORD, ME 04005

DESIGN: PBB
 DRAWN: DEPT.
 CHKD: PBB
 DATE: SEPT. 2013
 SCALE: 1"=20'


CAMPUS GREEN LANDSCAPE
 UNE CAMPUS, PORTLAND, MAINE
PLANTING PLAN
 PROJ. NO. _____
 DWG. NO. _____
 REV. _____
L-1.4 A

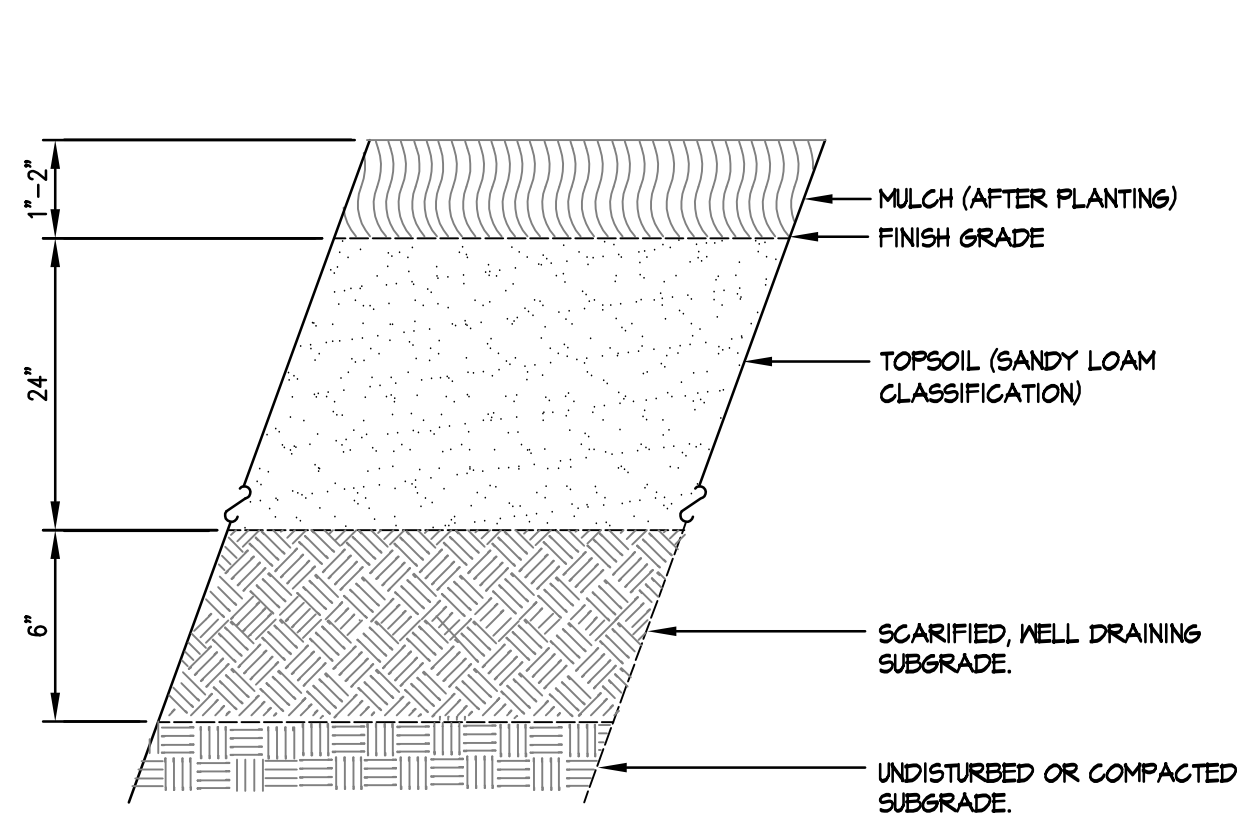


1 CENTER CIRCLE PREPARED PLANT BED
SCALE: N.T.S.

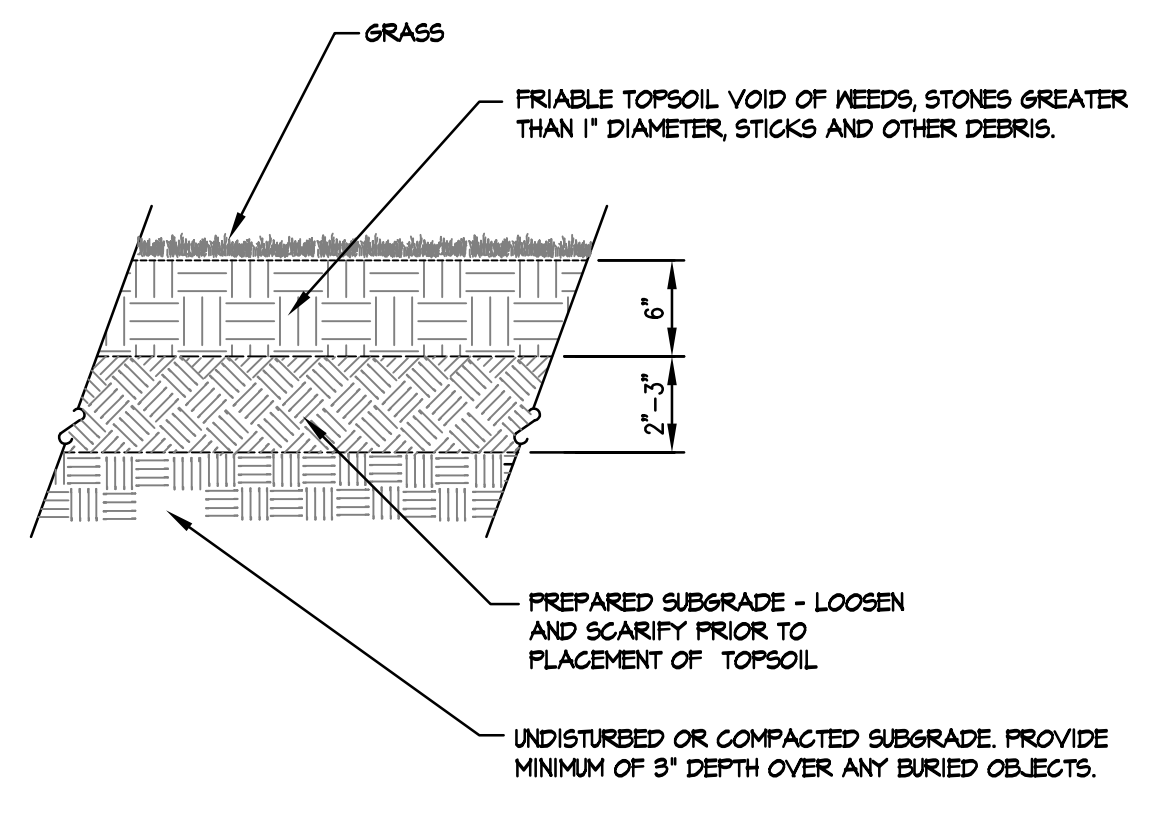

2 LAWN INSTALLATION (SEED OR SOD)
SCALE: N.T.S.

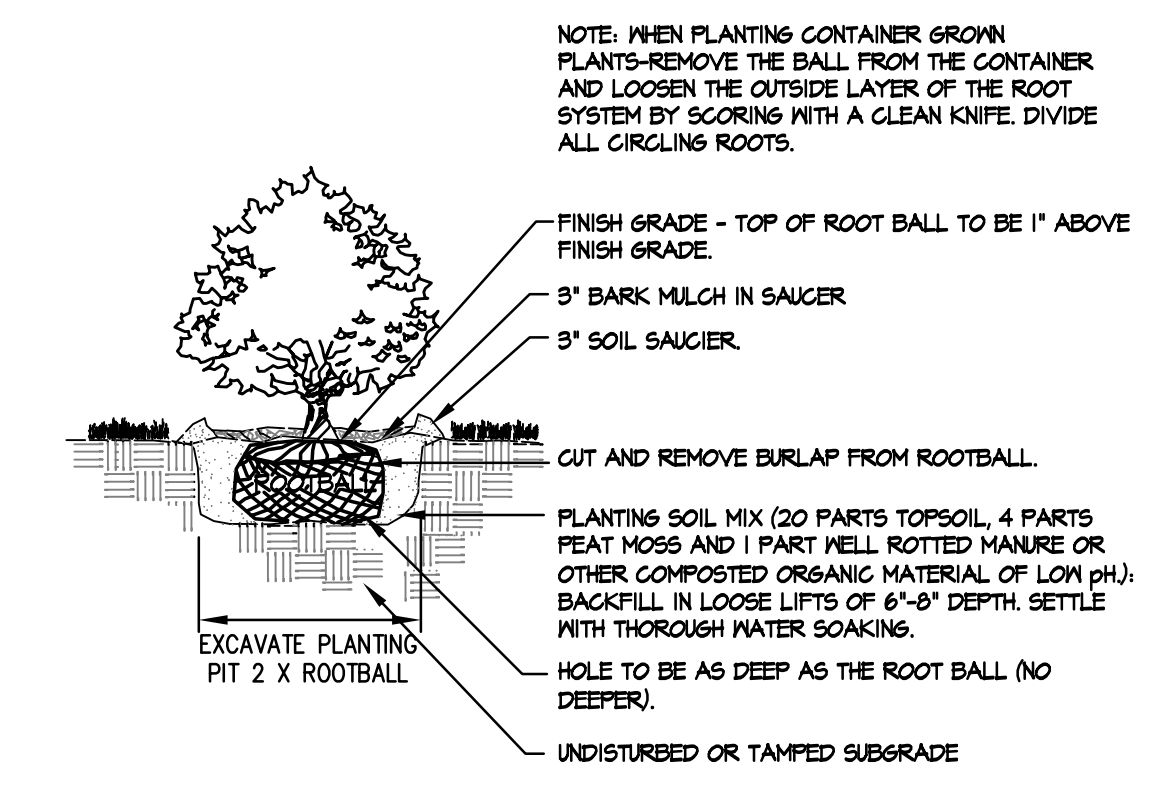


3 SHRUB PLANTING DETAIL
SCALE: N.T.S.

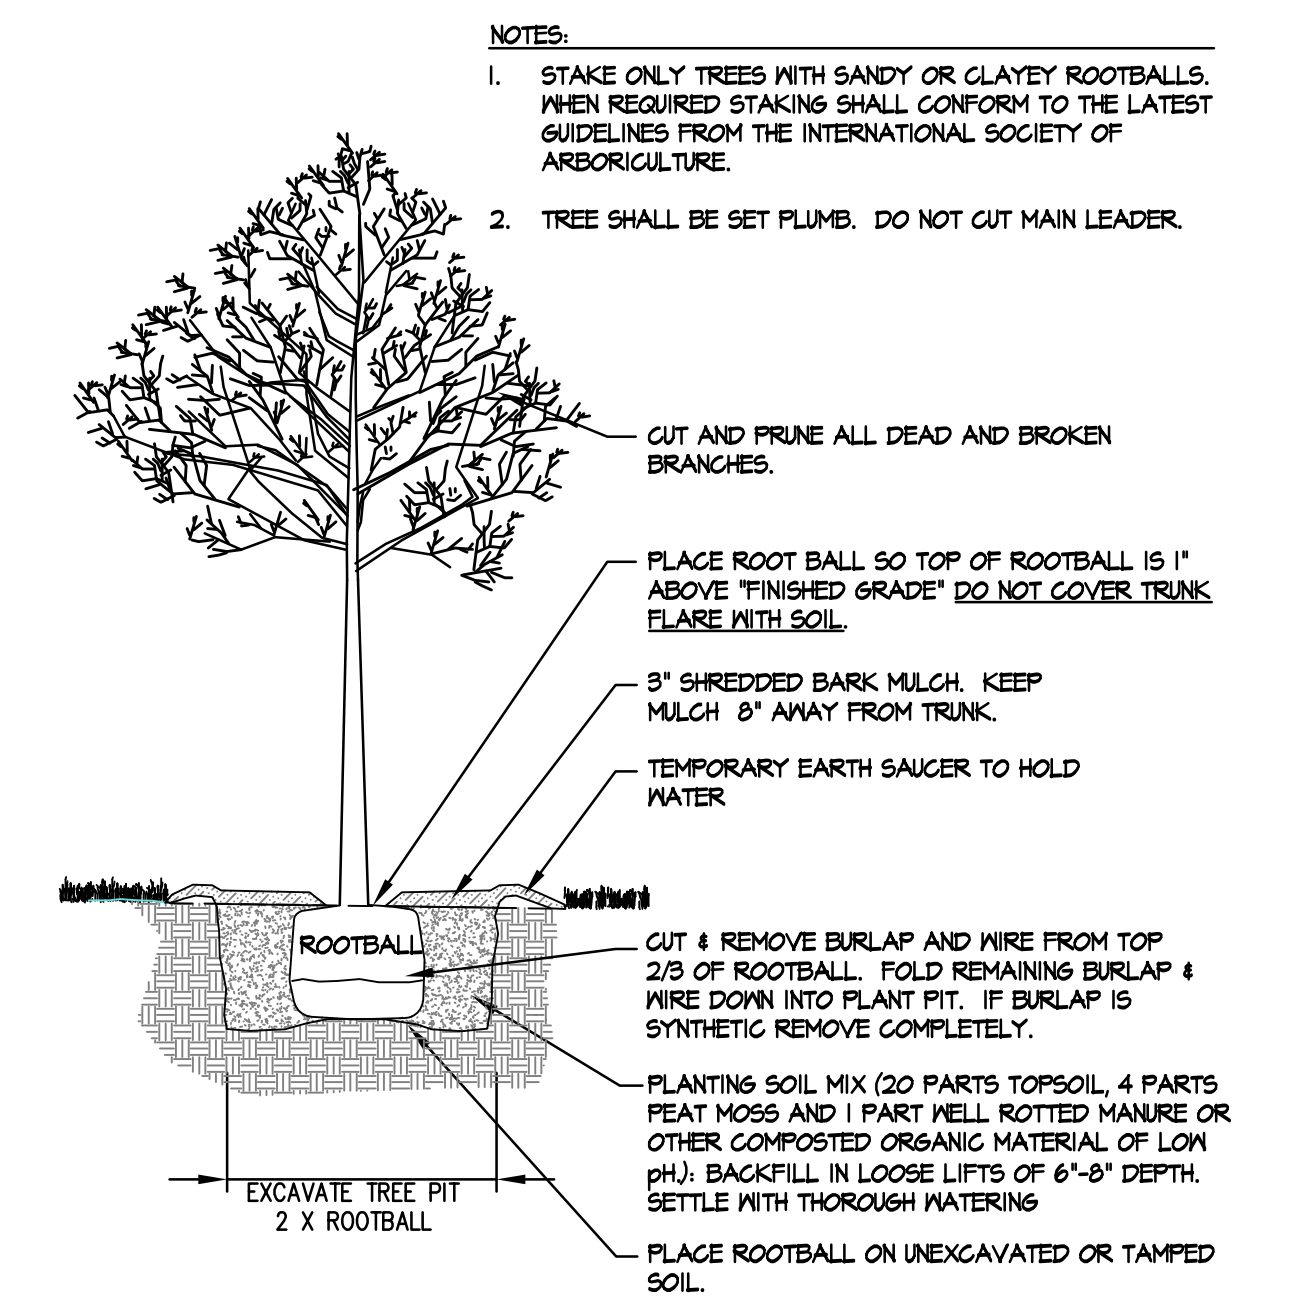

4 DECIDUOUS TREE PLANTING
SCALE: N.T.S.


- NOTES:
1. ALL PAVERS SHALL BE SAW CUT ONLY. NO FRAGMENT SHALL BE SMALLER THAN 2". FINAL SURFACE SHALL PITCH TO DRAIN PER GRADING PLAN.
 2. BRICK PAVER TO BE THE PATHWAY RED BRICK PAVER IN A 4x2-1/4"x8" SIZE AS MANUFACTURED BY PINE HALL BRICK AND DISTRIBUTED BY GENEST CONCRETE PRODUCTS OF WINDHAM AND SANFORD, MAINE OR APPROVED EQUIVALENT. BRICK SAMPLES SHALL BE PROVIDED TO THE OWNER FOR APPROVAL PRIOR TO PURCHASING.
 3. POLYMERIC SAND TO BE GATOR XP SAND AS MANUFACTURED BY ALLIANCE DESIGNER PRODUCTS AND DISTRIBUTED BY GENEST CONCRETE PRODUCTS OR APPROVED EQUIVALENT.
 4. COMPACT BASE GRAVELS TO 95% OF THEIR DRY MAXIMUM DENSITY.

- NOTES:
1. ALL PAVERS SHALL BE SAW CUT ONLY. NO FRAGMENT SHALL BE SMALLER THAN 2". FINAL SURFACE SHALL PITCH TO DRAIN PER GRADING PLAN.
 2. CONCRETE UNIT PAVERS SHALL BE THE TREVIA TUMBLED PAVER IN ASH CHARCOAL COLOR AS MANUFACTURED BY RINOX OF MONTREAL, CANADA (1-888-855-4994) OR DISTRIBUTED BY LANDSCAPERS DEPOT OF KINGSTON, NH (603-842-6677). SAMPLES SHALL BE PROVIDED TO THE OWNER PRIOR TO PURCHASE FOR APPROVAL.
 3. POLYMERIC SAND TO BE GATOR XP SAND AS MANUFACTURED BY ALLIANCE DESIGNER PRODUCTS AND DISTRIBUTED BY GENEST CONCRETE PRODUCTS OR APPROVED EQUIVALENT.
 4. COMPACT BASE GRAVELS TO 95% OF THEIR DRY MAXIMUM DENSITY.

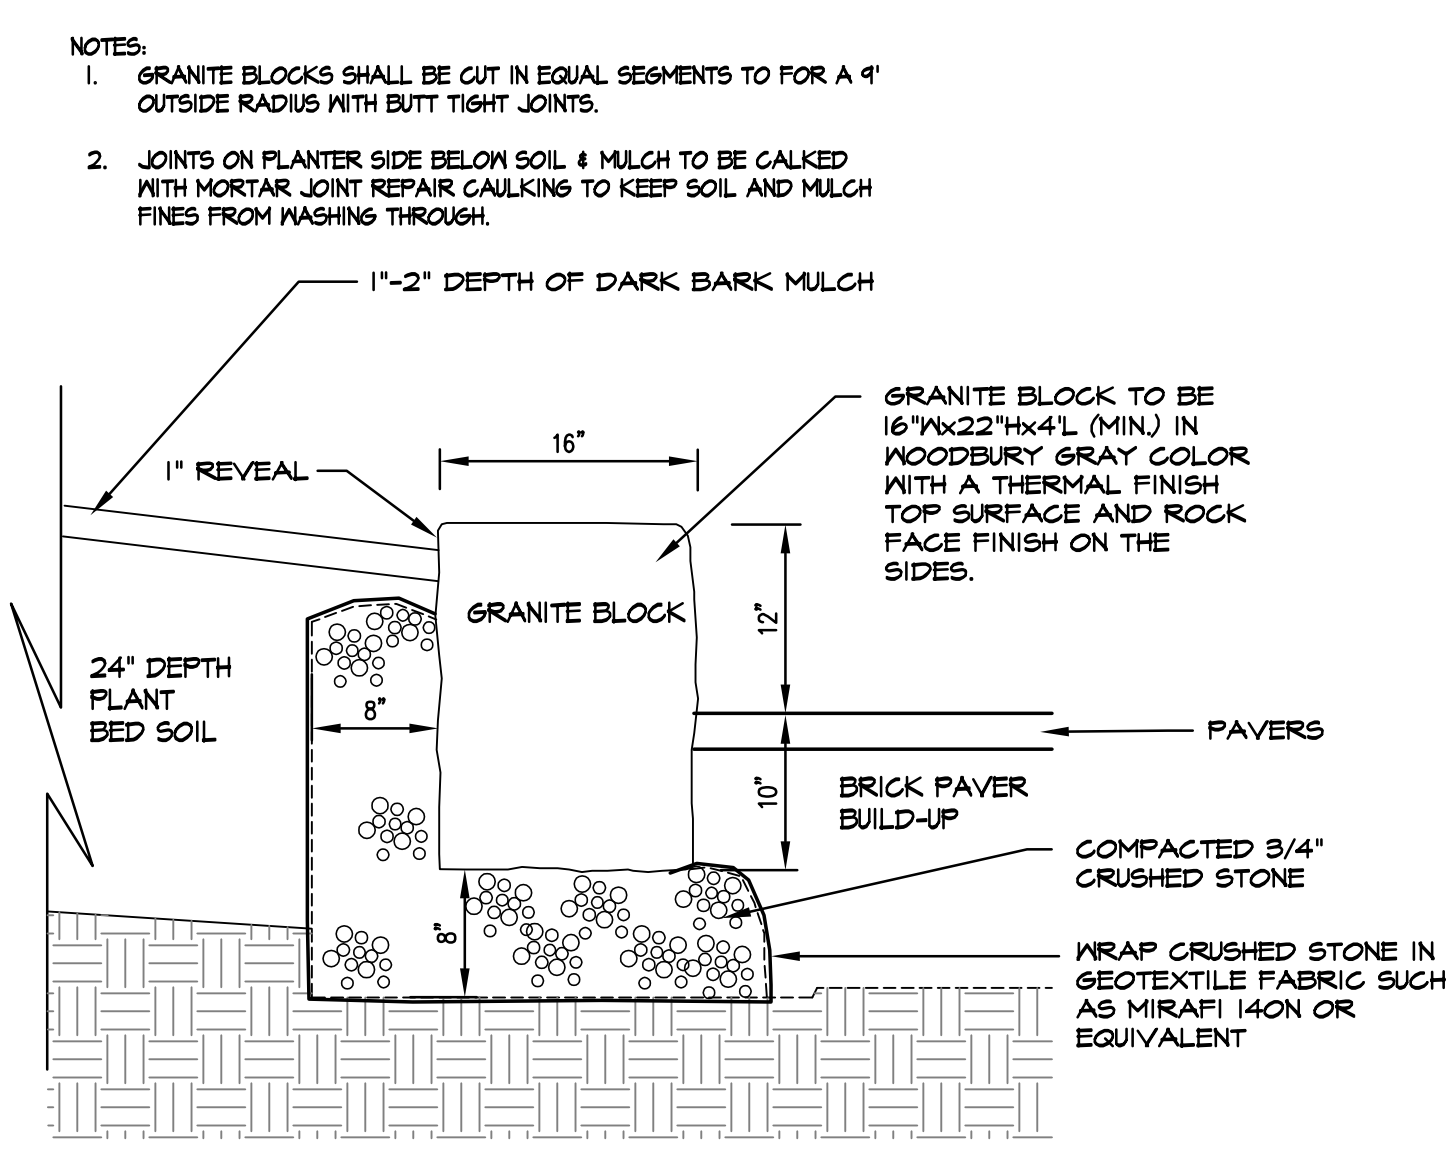


7 CIRCLE GARDEN GRANITE EDGING
SCALE: N.T.S.


- NOTES:
1. CROSSWALKS SHALL CONFORM TO THE REQUIREMENTS OF THE AMERICANS WITH DISABILITIES ACT AND ALL LOCAL CODES AND MUTCD STANDARDS.
 2. ALL PAINT SHALL BE LEAD FREE, FAST DRYING, 100% ACRYLIC WATERBORNE TRAFFIC PAINT WITH SILICA SAND FOR SKID RESISTANCE, MEETING THE REQUIREMENTS OF TT-P-1952E TYPE I & II. PAINT SHALL BE APPLIED AS SPECIFIED BY THE MANUFACTURER.
 3. OWNER TO APPROVE THE LAYOUT OF CROSSWALKS PRIOR TO PAINTING.

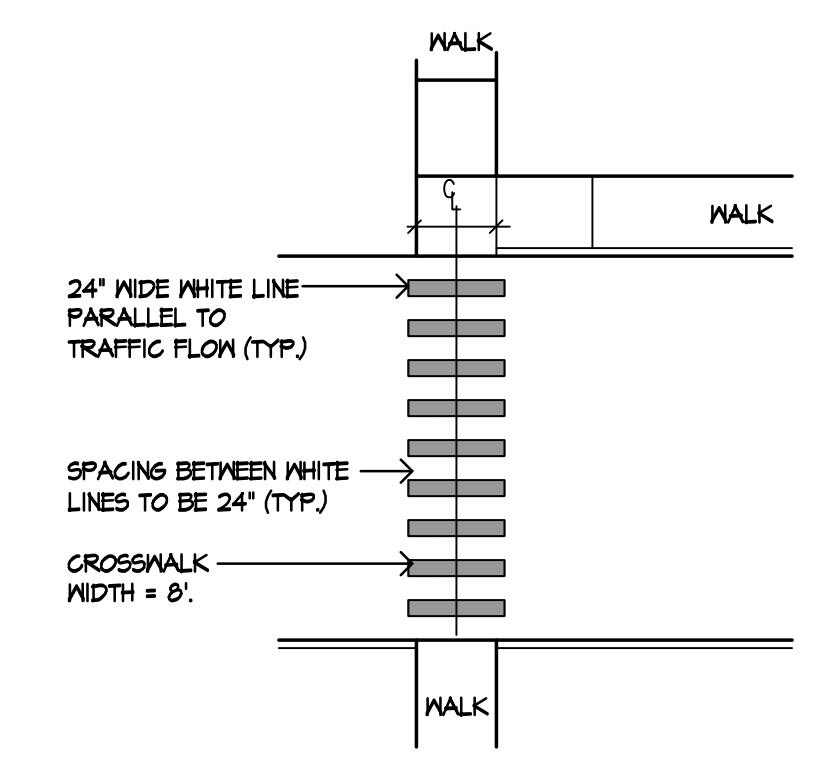


8 PAINTED CROSSWALK
SCALE: N.T.S.

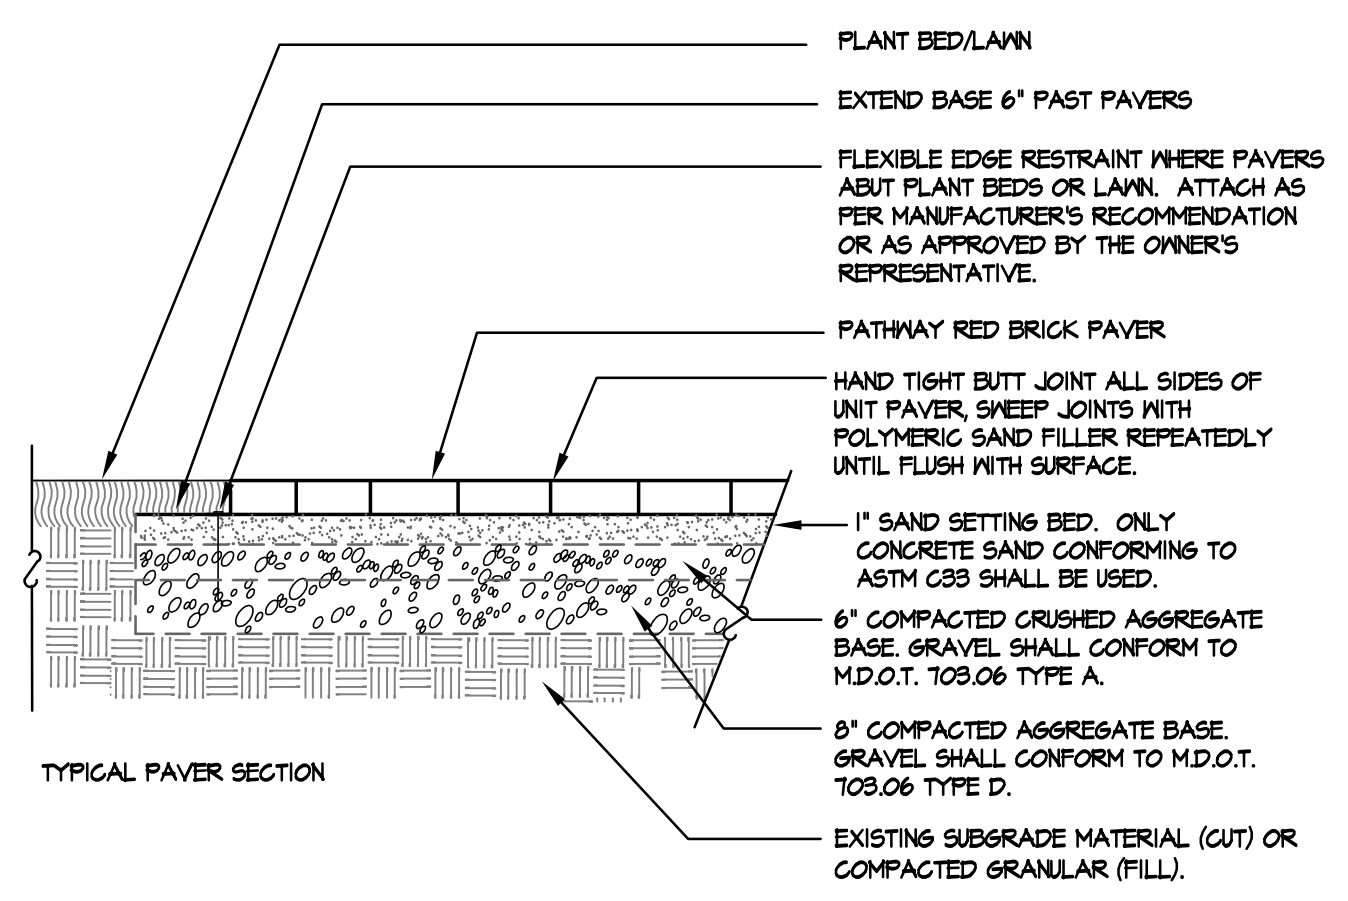


5 BRICK PAVER INSTALLATION
SCALE: N.T.S.

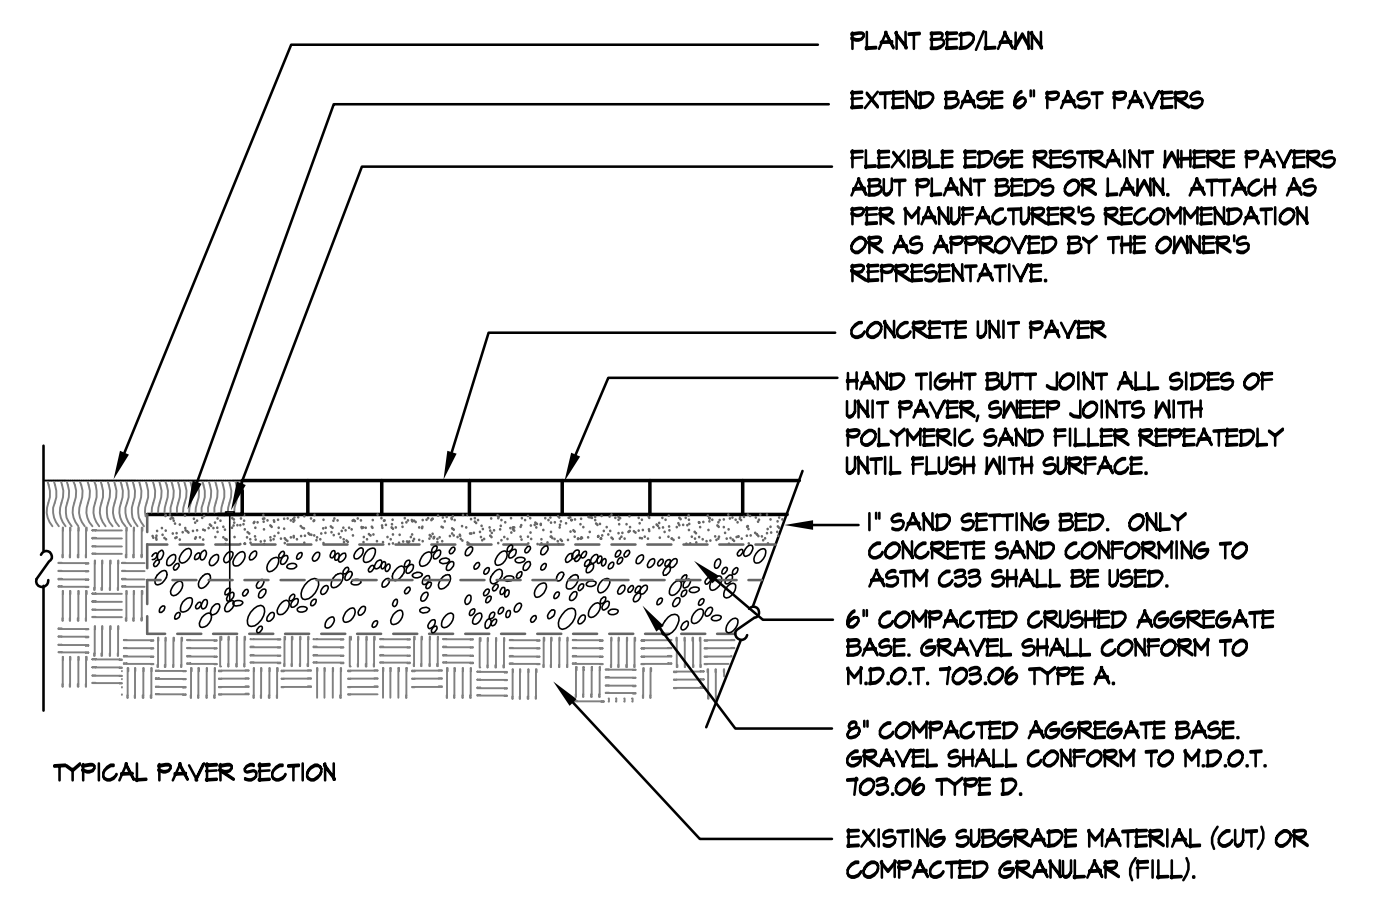


6 CONCRETE UNIT PAVER INSTALLATION
SCALE: N.T.S.

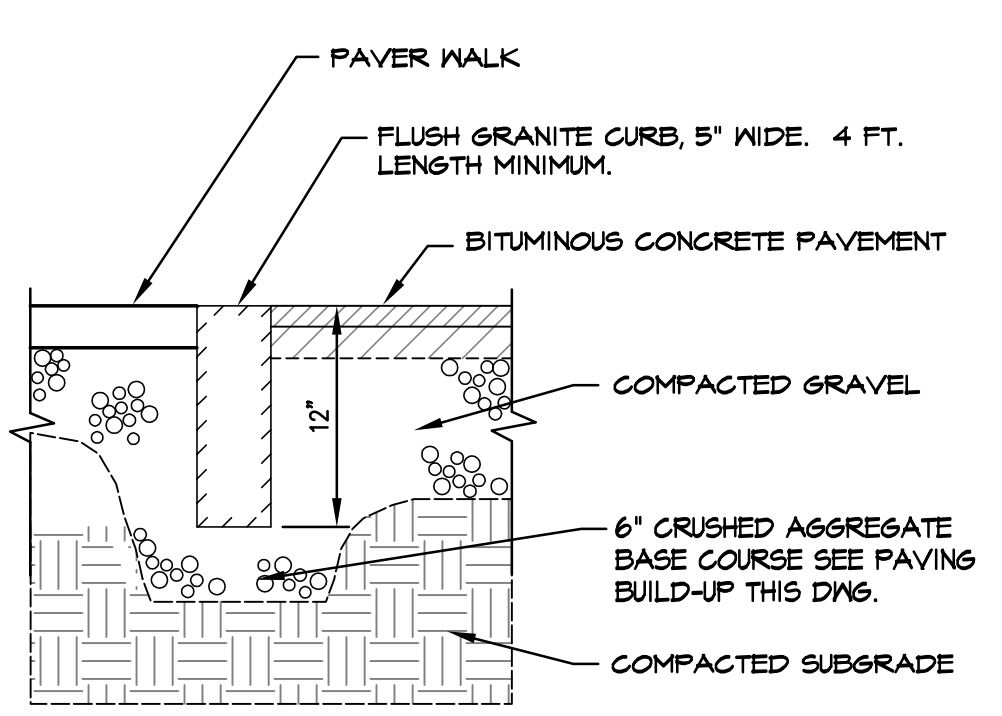

9 FLUSH GRANITE EDGE / CURB
SCALE: N.T.S.

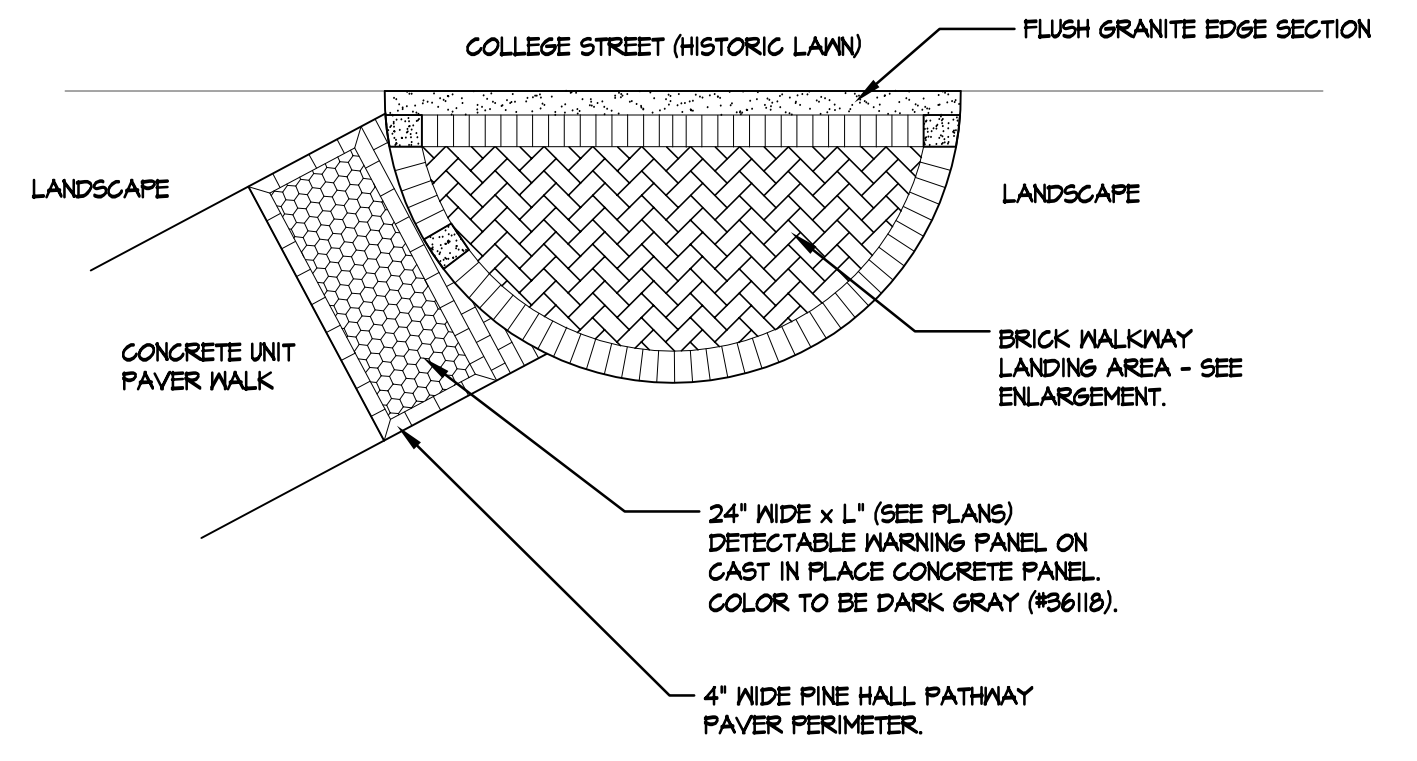

10 COLLEGE STREET DETECTABLE WARNING PANELS
SCALE: N.T.S.

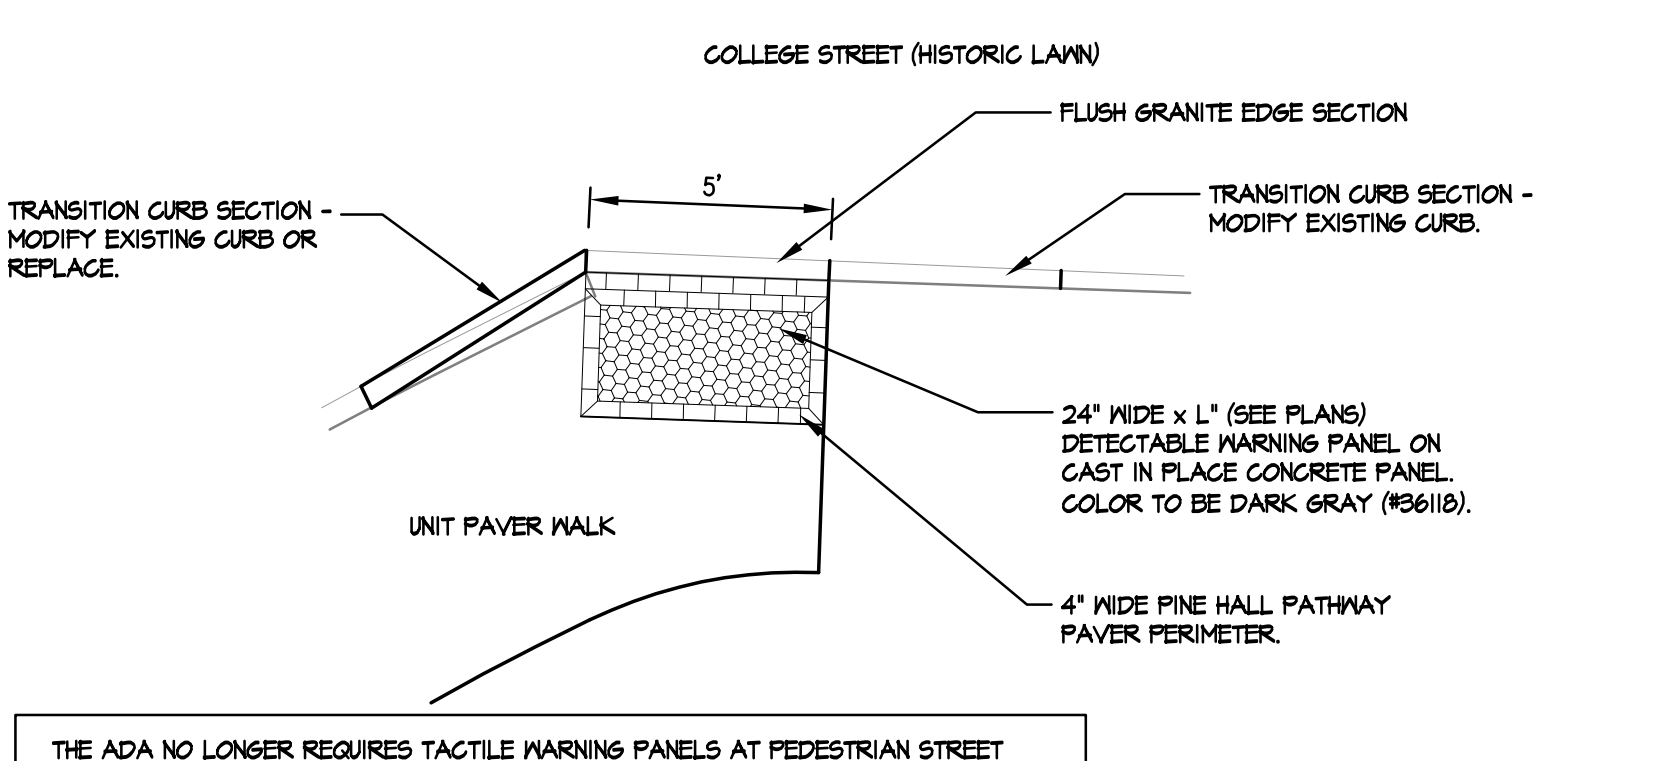

THE ADA NO LONGER REQUIRES TACTILE WARNING PANELS AT PEDESTRIAN STREET CROSSINGS, HOWEVER THE CITY OF PORTLAND DOES. THIS ISSUE SHOULD BE REVISITED WITH THE CITY OF PORTLAND AT THE TIME THE WALKS ARE TO BE CONSTRUCTED.

- NOTES:
1. DIMENSIONS ARE SUBJECT TO CHANGE IN FIELD. ALL SLOPES AND DIMENSIONS TO COMPLY WITH A.D.A. REQUIREMENTS.
 2. CONTRACTOR TO INSTALL 24" WIDE DETECTABLE WARNING STRIP PER ADA GUIDELINES AND THE CITY OF PORTLAND TECHNICAL STANDARDS, FIGURE I-TA. DETECTABLE WARNING PANELS SHALL BE COMPOSITE (NET SET (REPLACEABLE) IN DARK GRAY COLOR (#3611B) AS MANUFACTURED BY ADA SOLUTIONS INC. OR APPROVED EQUIVALENT.
 3. CONCRETE PANELS SHALL BE CAST IN PLACE, 5" THICK AND MEET SPECIFICATIONS FOR MAINE D.O.T. CLASS A STRUCTURAL CONCRETE, MINIMUM COMPRESSIVE STRENGTH 4000 PSI. CONCRETE SHALL BE SEALED PRIOR TO SETTING PANELS.
 4. CONTRACTOR SHALL PROVIDE THE OWNER'S REPRESENTATIVE WITH SHOP DRAWING SHOWING INSTALLATION AND DIMENSIONS OF ALL CURBS, WALKS AND TACTILE WARNING PANELS FOR REVIEW AND APPROVAL PRIOR TO CONSTRUCTION.
 5. ALL WORK IN THE CITY OF PORTLAND STREET RIGHT OF WAY MUST MEET THE CITY TECHNICAL STANDARDS AND IS SUBJECT TO CITY REVIEW.

Drawing Name: C:\Users\NCTE\OneDrive\Desktop\Submittal\04-14-14\04-14-14.dwg / Title: Campus Green Landscape / Date: 5/23/14

REV.	DATE	STATUS	BY	CHKD.	APPD.	REV.	DATE	STATUS	BY	CHKD.	APPD.
A	5/23/14	ISSUED FOR CLIENT REVIEW		DEPT.	PBB	PBB					

LAND DESIGN SOLUTIONS
LAND PLANNING, SITE PLANNING & LANDSCAPE ARCHITECTURE
P.O. Box 316, 160 Longwoods Road, Cumberland, ME 04081 tel: (207) 494-7171
CLIENT & OWNER:
UNIVERSITY OF NEW ENGLAND
11 HILLS BEACH ROAD, BIDDEFORD, ME 04005

DESIGN: PBB
DRAWN: DEPT.
CHKD: PBB
DATE: SEPT. 2013
SCALE: AS NOTED

PROJ. NO.
DWG. NO.

CAMPUS GREEN LANDSCAPE
STEVENS AVENUE, PORTLAND, MAINE

LANDSCAPE DETAILS

REV. A
L-2.1

REINFORCED HANDHOLE W/
COVER AND STAINLESS
STEEL SCREWS

CONDUITS STUBBED
UP INSIDE POLE

BASE PLATE

NON-SHRINK
GROUT (1" MAX)

3/4" CHAMFER

FINISH GRADE

3/4" DIA x 10'
LONG GROUNDING
ROD (COPPER
CLAD STEEL)

LIGHT POLE
PROVIDE INTERNAL
GROUNDING LUG, SIZE
GROUNDING CONDUCTOR
PER NFPA 70

BASE COVER

GALV ANCHOR BOLTS (SIZE AND
NUMBER PER MANUFACTURERS
RECOMMENDATIONS)

LEVELING NUTS

TOP OF FOUNDATION

12"

18" DIA FORMED CONC
FDN (4,000 PSI MIN)

COMPACTED COMMON FILL

#4 TIES @ 12" OC (TYP)

RGS CONDUIT RISER, TYP

4 #5 EQUALLY SPACED

3" CLEAR


(4) 1'-0" LONG #4'S
EPOXY GROUT 6" MIN
INTO EXISTING ROCK

2" CLEAR (TYP)

5'-0"

COMPACT EXIST SUBGRADE OR
RANULAR BRROW/COMMON FILL

ROCK

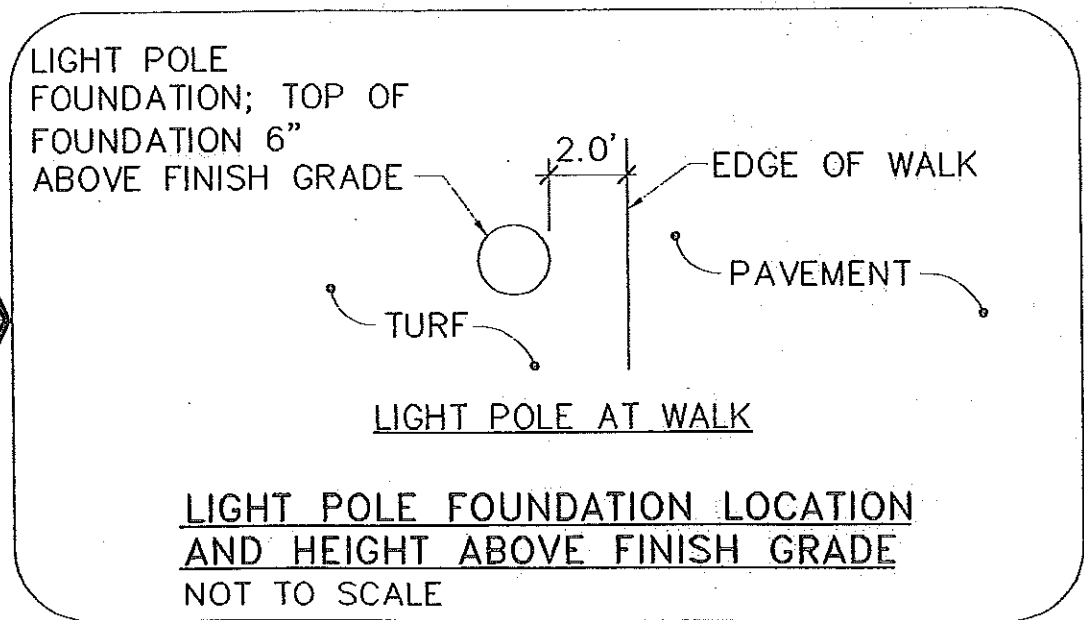

TOTAL 19