

DESIGNED BY: WFG
 DRAWN BY: MJC
 CHECKED BY: DNM
 PROJECT: 21602.16

UNIVERSITY OF NEW ENGLAND
 PORTLAND CAMPUS
 Fine Arts Gallery
 716 Stevens Avenue
 Portland, ME 04103-2693

FINE ARTS GALLERY
 ELEVATOR ADDITION
 FOR PERMITTING ONLY - NOT FOR CONSTRUCTION

ELEVATOR ADDITION
 FOUNDATION
 PLAN AND
 DETAILS

SCALE: AS NOTED
 DATE: 3-29-17


DWG.: SB101

SHEET: 8 OF 26


GENERAL NOTE:
 ELEVATOR PIT SIZE: 5'-10" WIDE x 9'-0" LONG x 4'-0" DEEP.

- EXISTING KEYNOTES:** (THIS SHEET ONLY)
- △ EXISTING 5"± REINFORCED CONCRETE SLAB-ON-GRADE.
 - △ EXISTING 1'-6"± x 4'-6"± CONTINUOUS REINFORCED CONCRETE FOOTING.
 - △ EXISTING 1'-0"± x 3'-0"± CONTINUOUS REINFORCED CONCRETE FOOTING.
 - △ EXISTING 11"± REINFORCED CONCRETE FOUNDATION WALL.
 - △ EXISTING 8-1/2"± REINFORCED CONCRETE FOUNDATION WALL.
 - △ EXISTING 3'-0"± x 3'-0"± x 1'-6"± DEEP REINFORCED CONCRETE FOOTING WITH 1'-1"± x 1'-1"± REINFORCED CONCRETE PIER.
 - △ EXISTING 8"± CMU BLOCK SUPPORTED ON 1'-0"± DEEP REINFORCED CONCRETE FOOTING.


- KEYNOTES:** (THIS SHEET ONLY)
- △ 1'-0" REINFORCED CONCRETE SLAB WITH #6'S AT 1'-0" ON-CENTER EACH WAY. TOP OF SLAB ELEVATION = 121.07'.
 - △ 8" REINFORCED CONCRETE FOUNDATION WALL.
 - △ 10" REINFORCED CONCRETE FOUNDATION WALL.
 - △ 2'-0" x 2'-0" x 2'-0" DEEP SUMP PIT WITH 1" GALVANIZED STEEL GRATING COVER. NOTCH CORNER OF GRATE FOR 2" DIAMETER PUMP DRAIN LINE (COORDINATE WITH MECHANICAL DRAWINGS).
 - △ CONCRETE SLAB PATCH. REFER TO DETAIL 5/SB101.
 - △ METAL LADDER. REFER TO DETAIL 2/AE301.

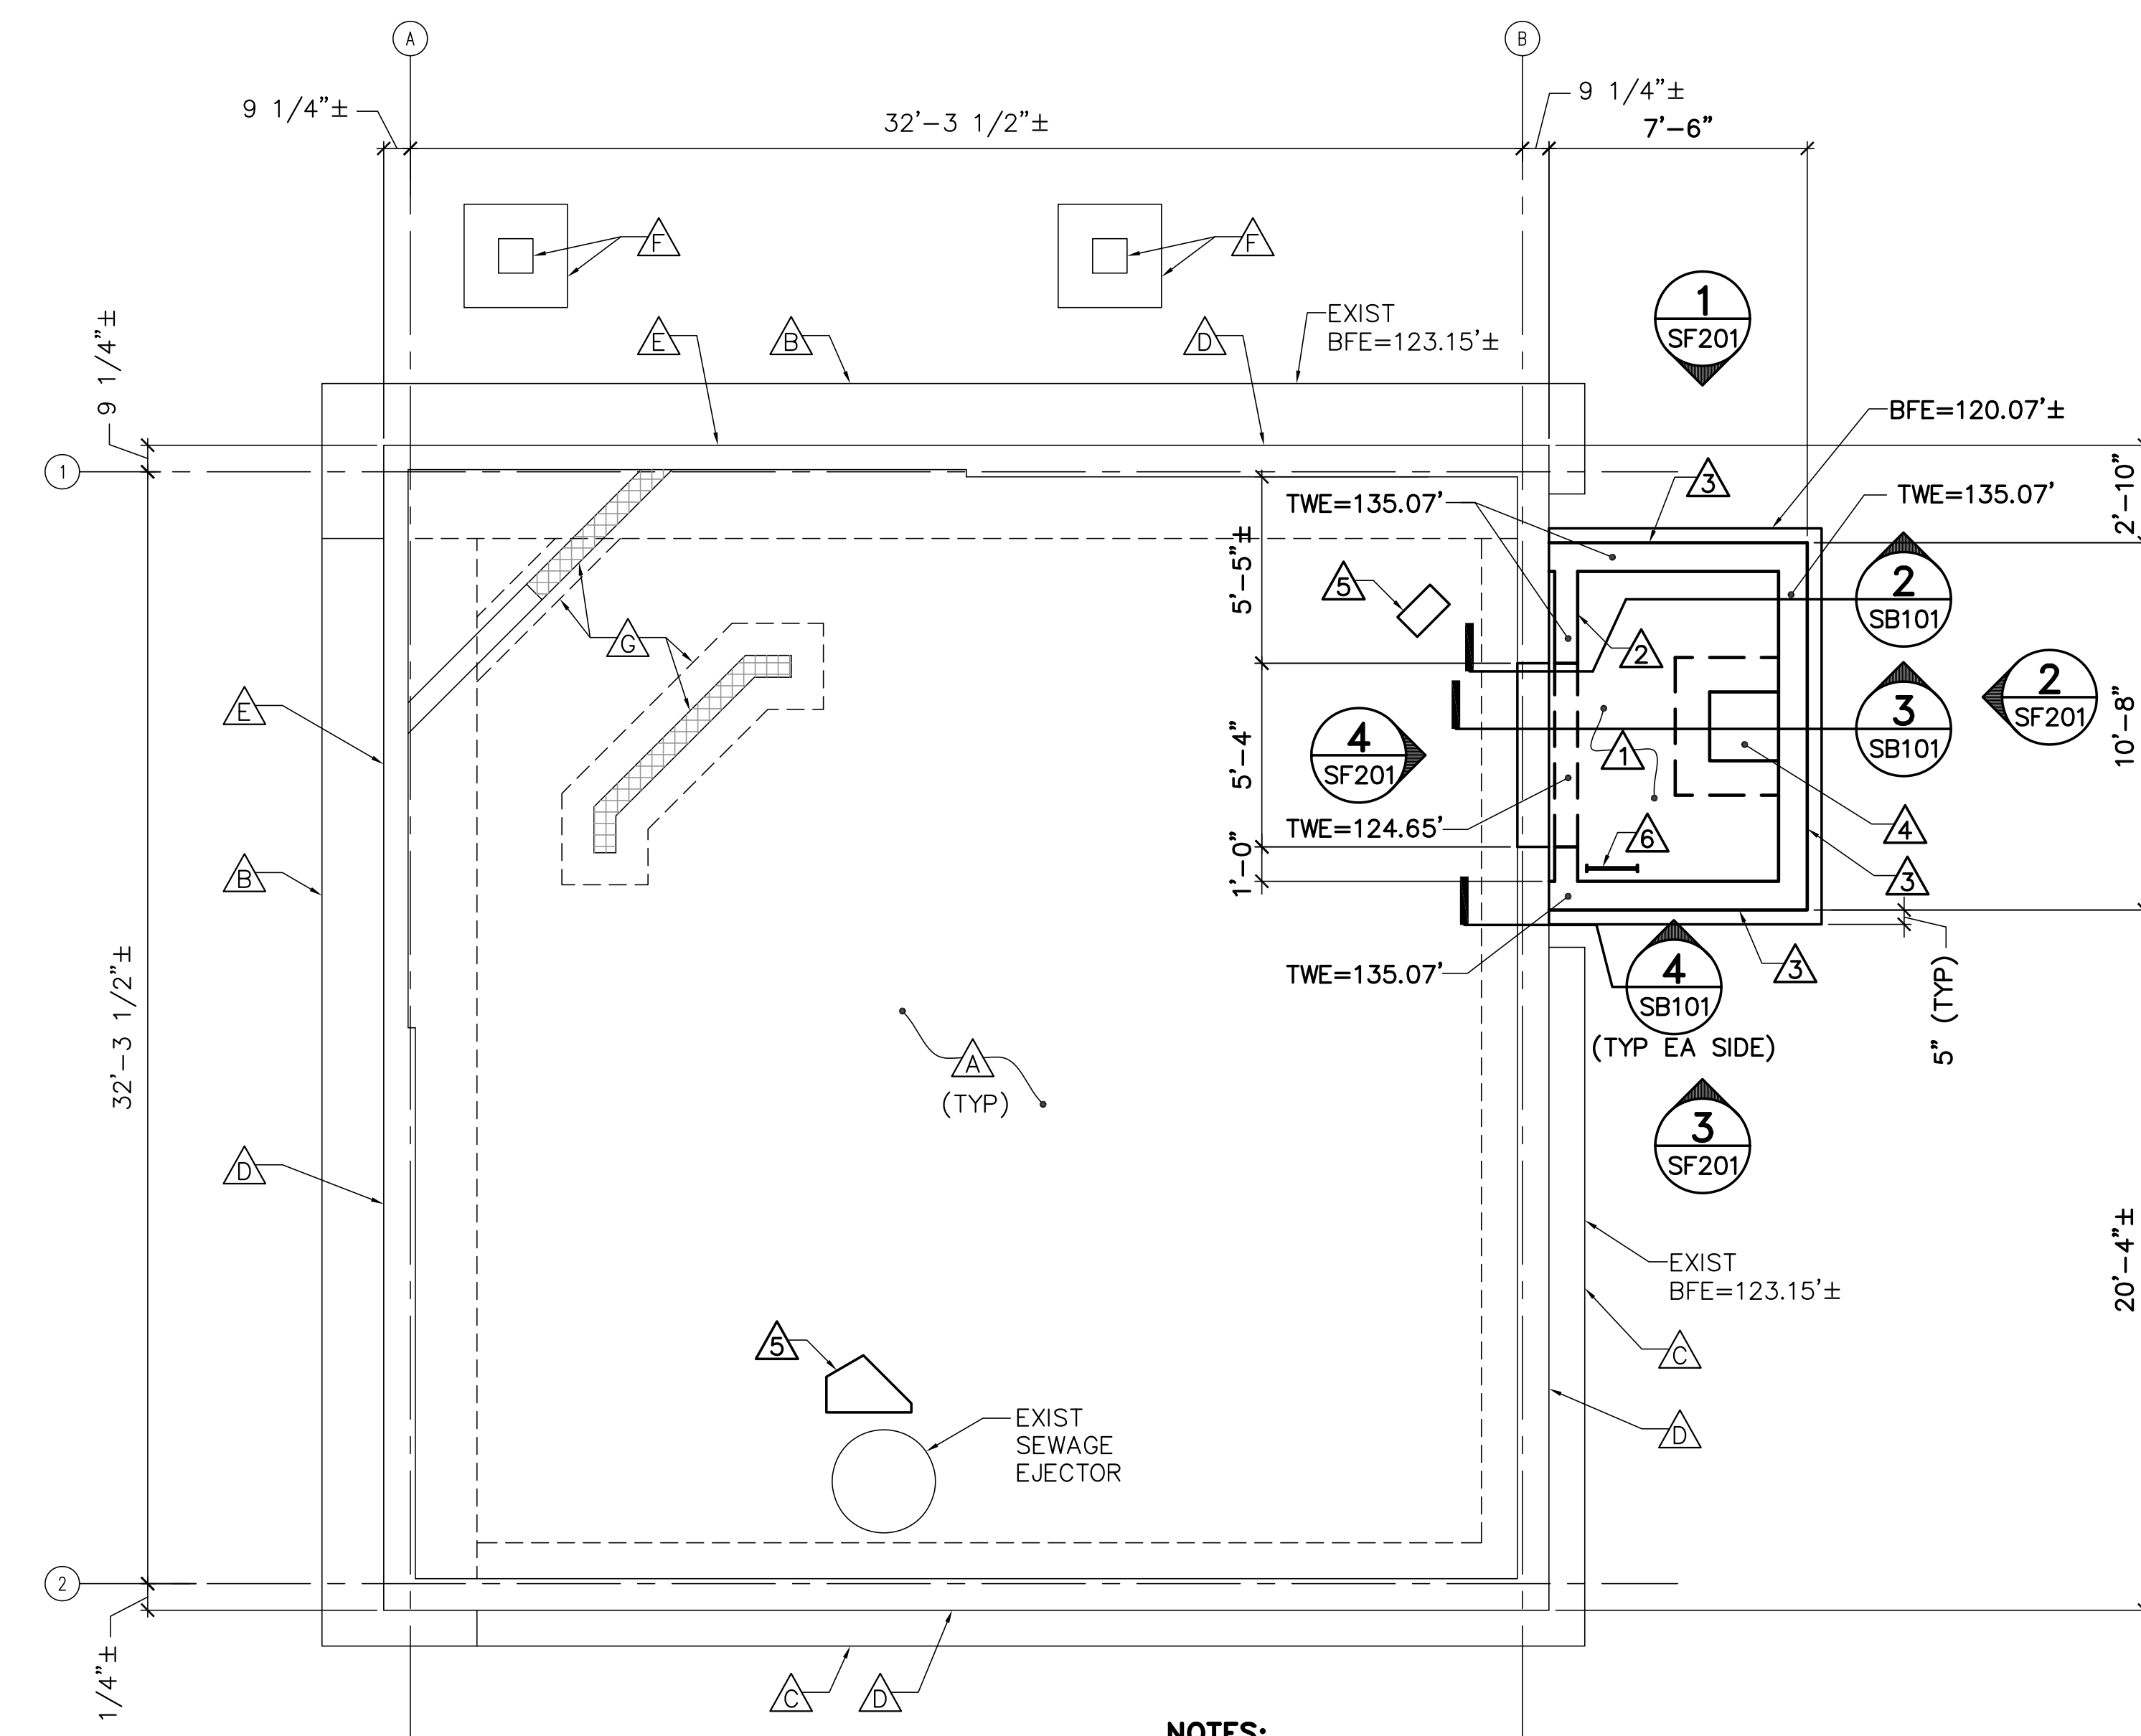

NOTES:
 1. TOP OF EXISTING SLAB ELEVATION = 125.07'±.
 2. UNDERPINNING NOT SHOWN FOR CLARITY.

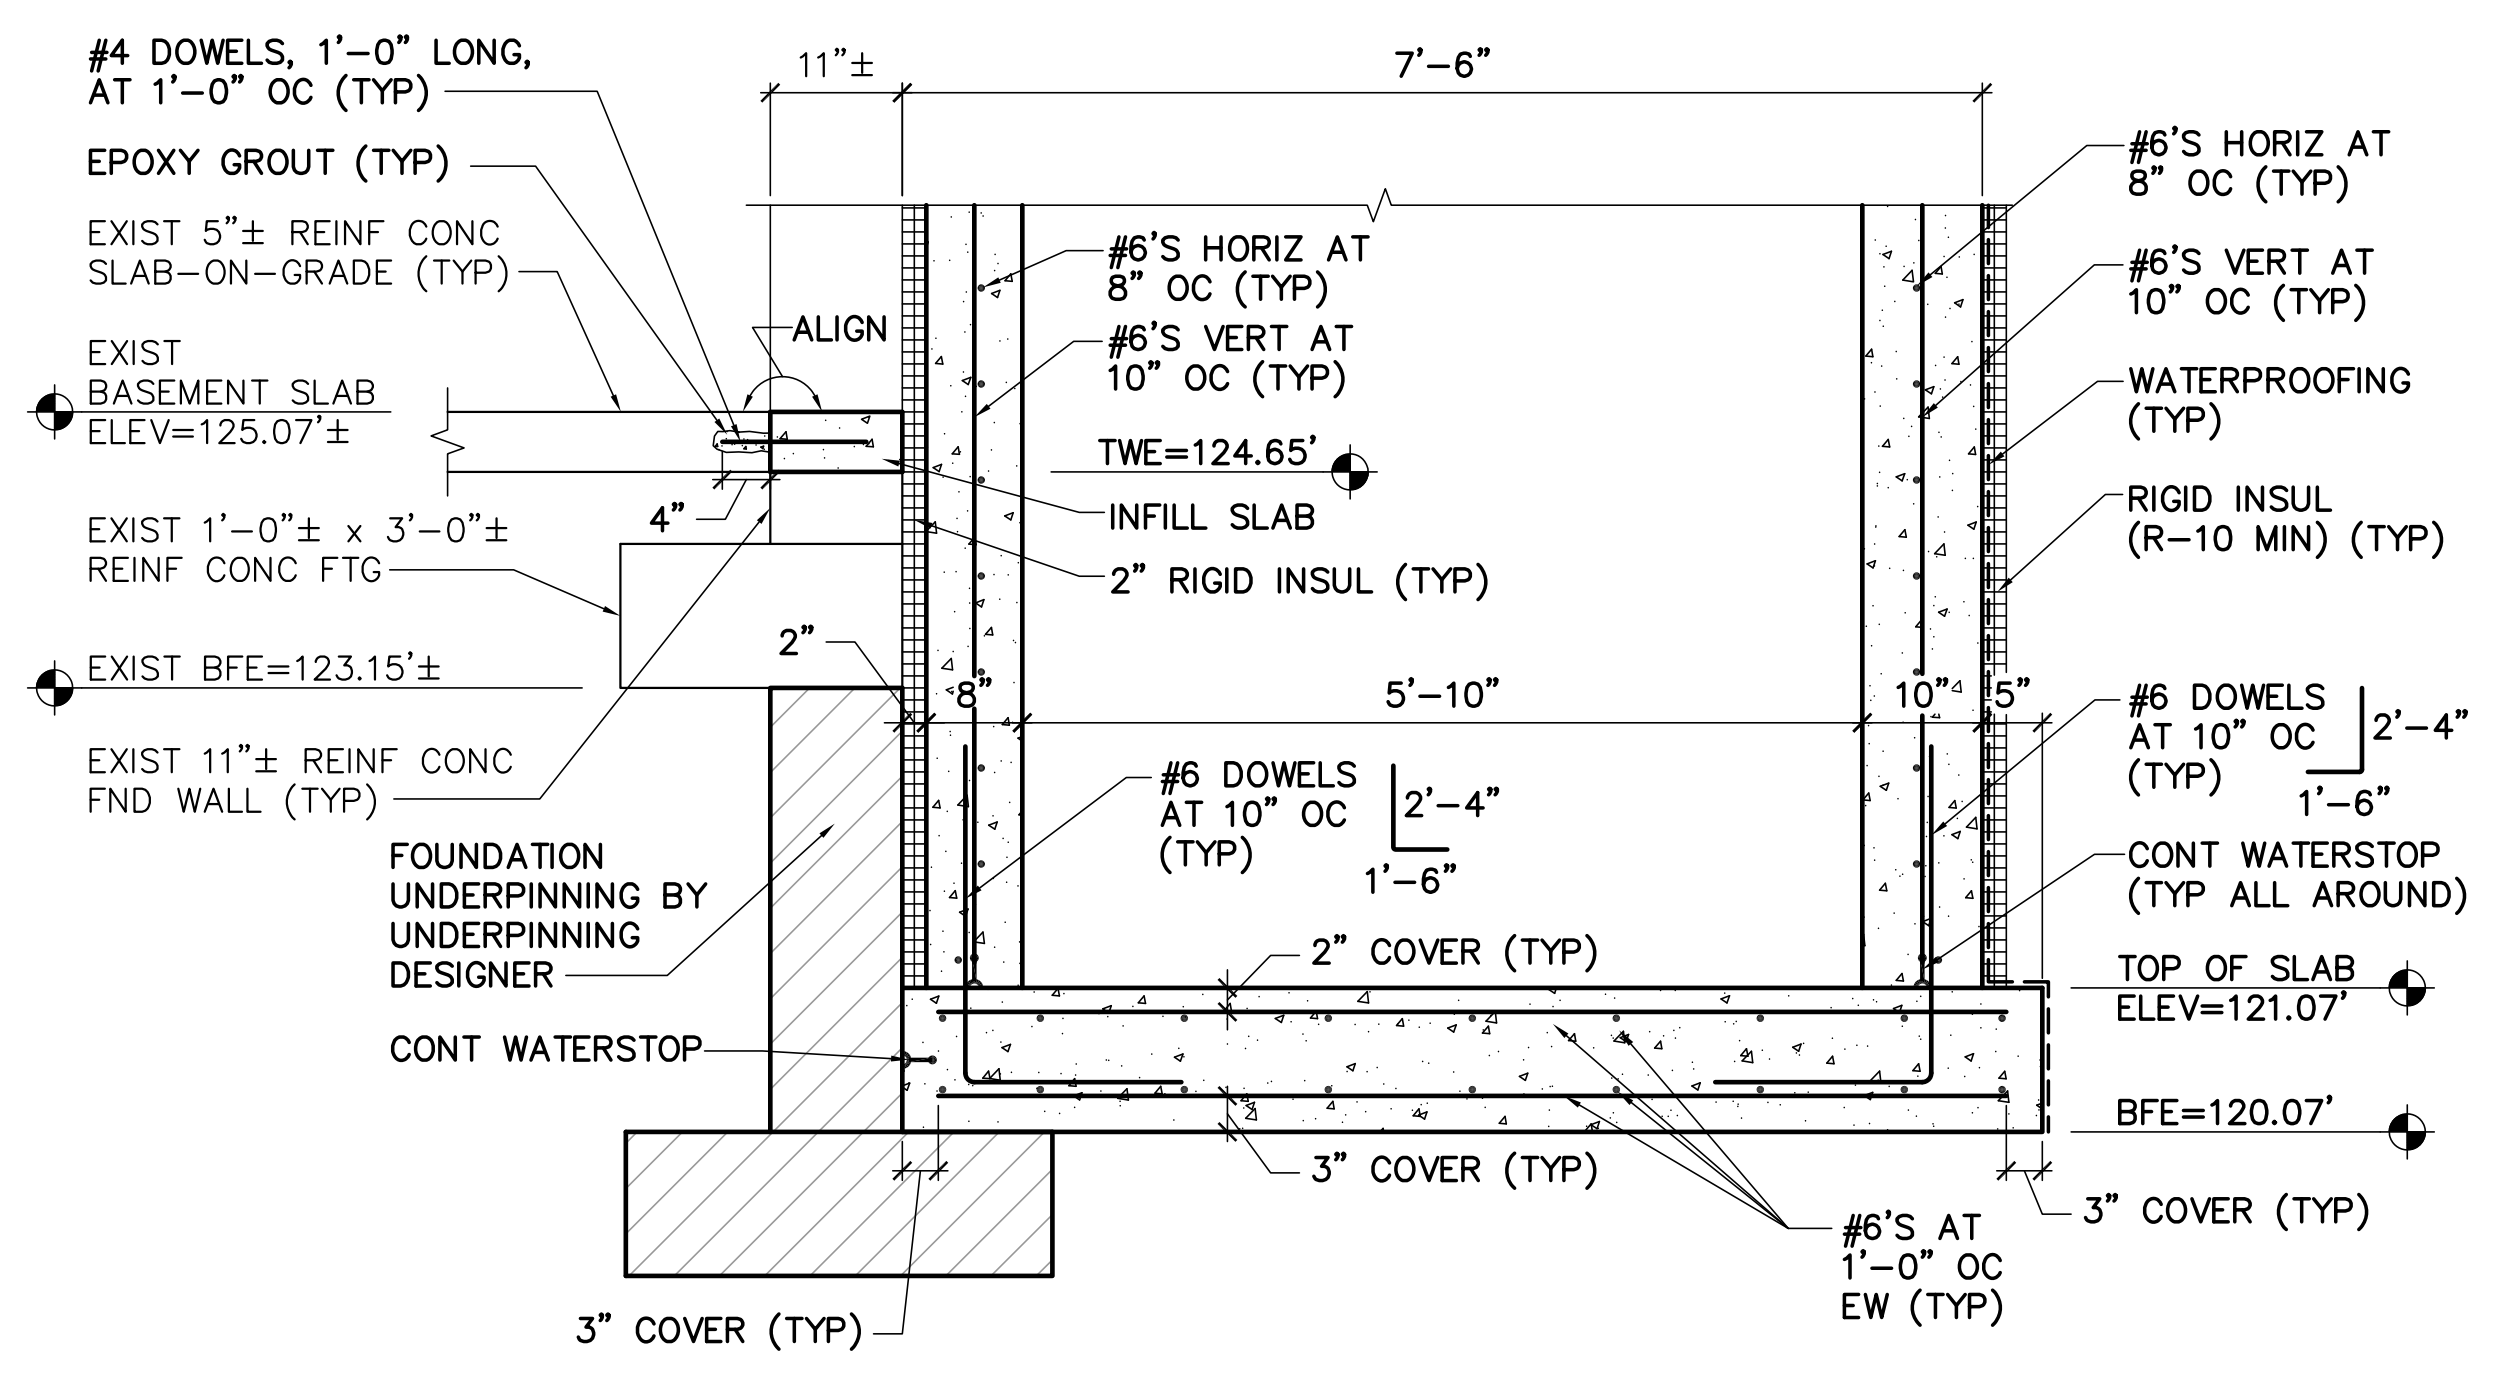


2 ELEVATOR PIT SECTION AT DOOR JAMB
 SB101 SCALE: 3/4"=1'-0"

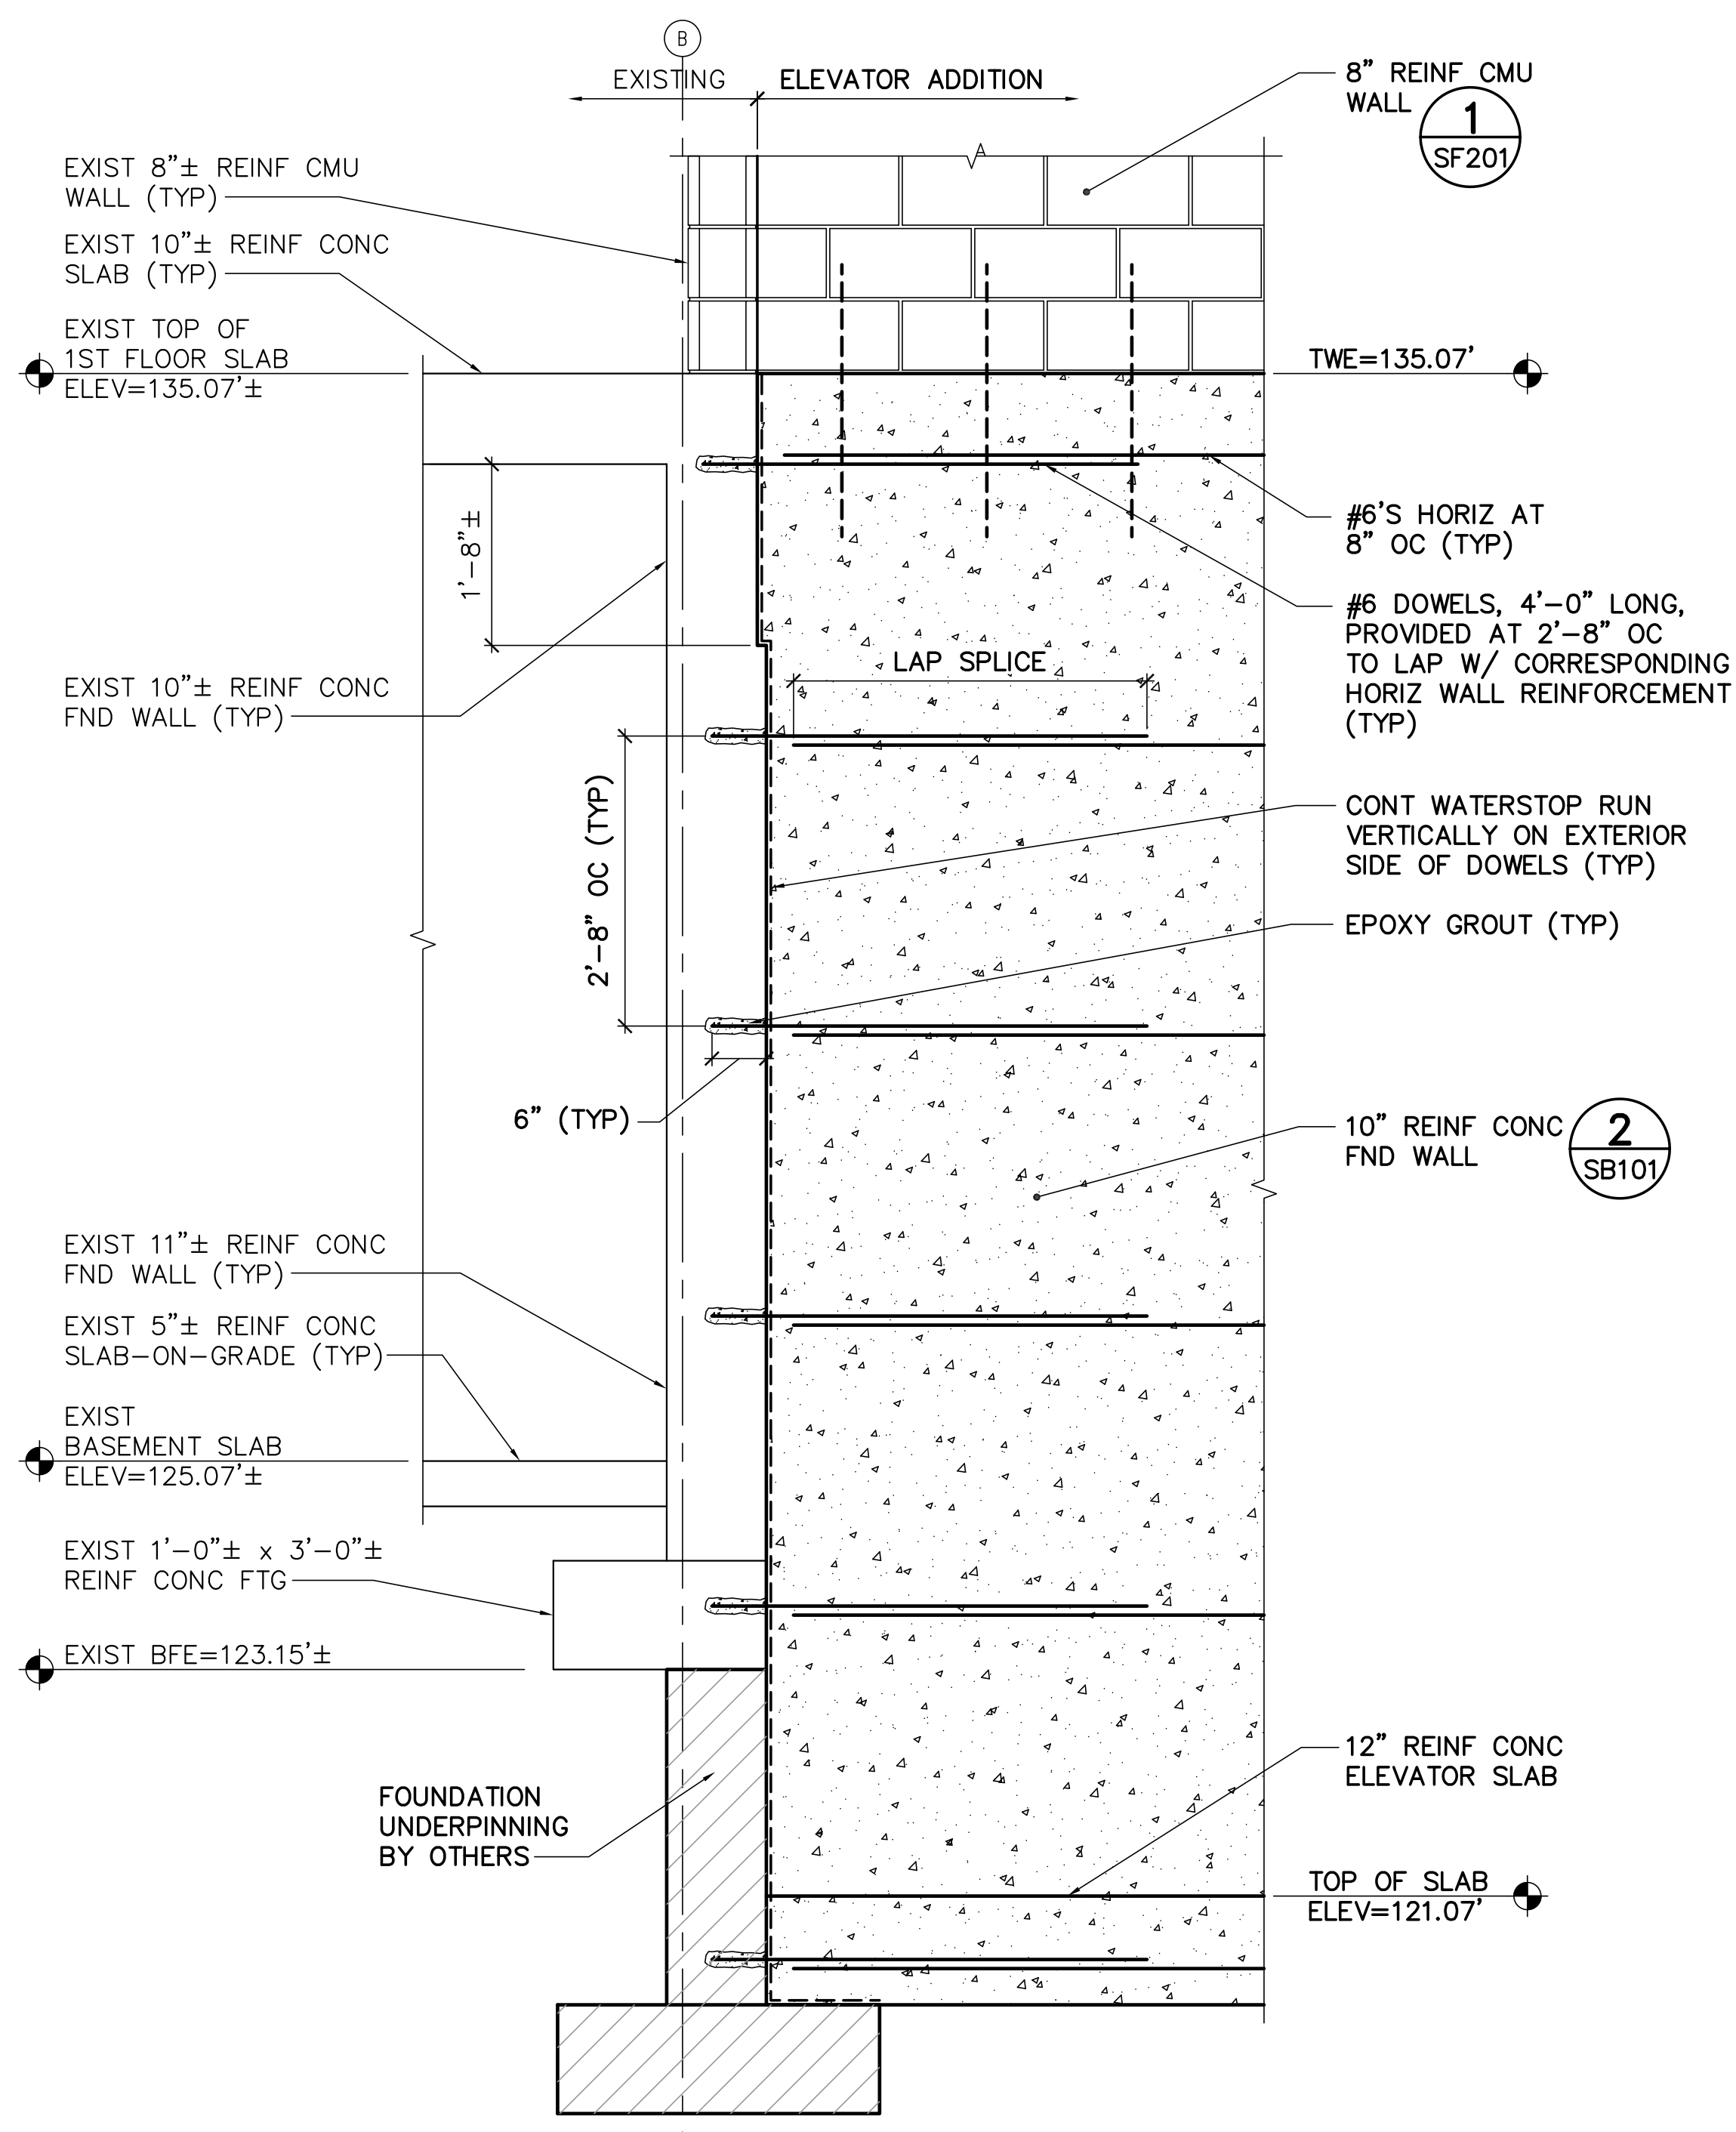

3 ELEVATOR SUMP PIT SECTION AT DOOR OPENING
 SB101 SCALE: 3/4"=1'-0"

NOTE:
 NEW FOUNDATION WALL REINFORCEMENT NOT SHOWN FOR CLARITY EXCEPT AT DOWEL LOCATIONS.

4 EXIST TO NEW FND WALL SECTION
 SB101 SCALE: 3/4"=1'-0"

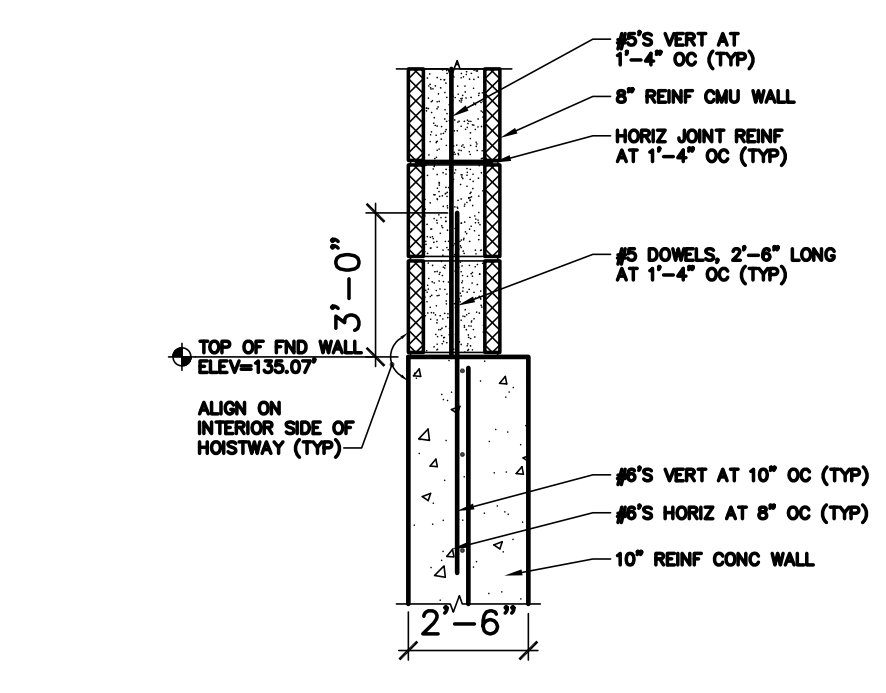

5 TYP SLAB PATCH DETAIL
 SB101 SCALE: 3/4"=1'-0"

