


LEGEND

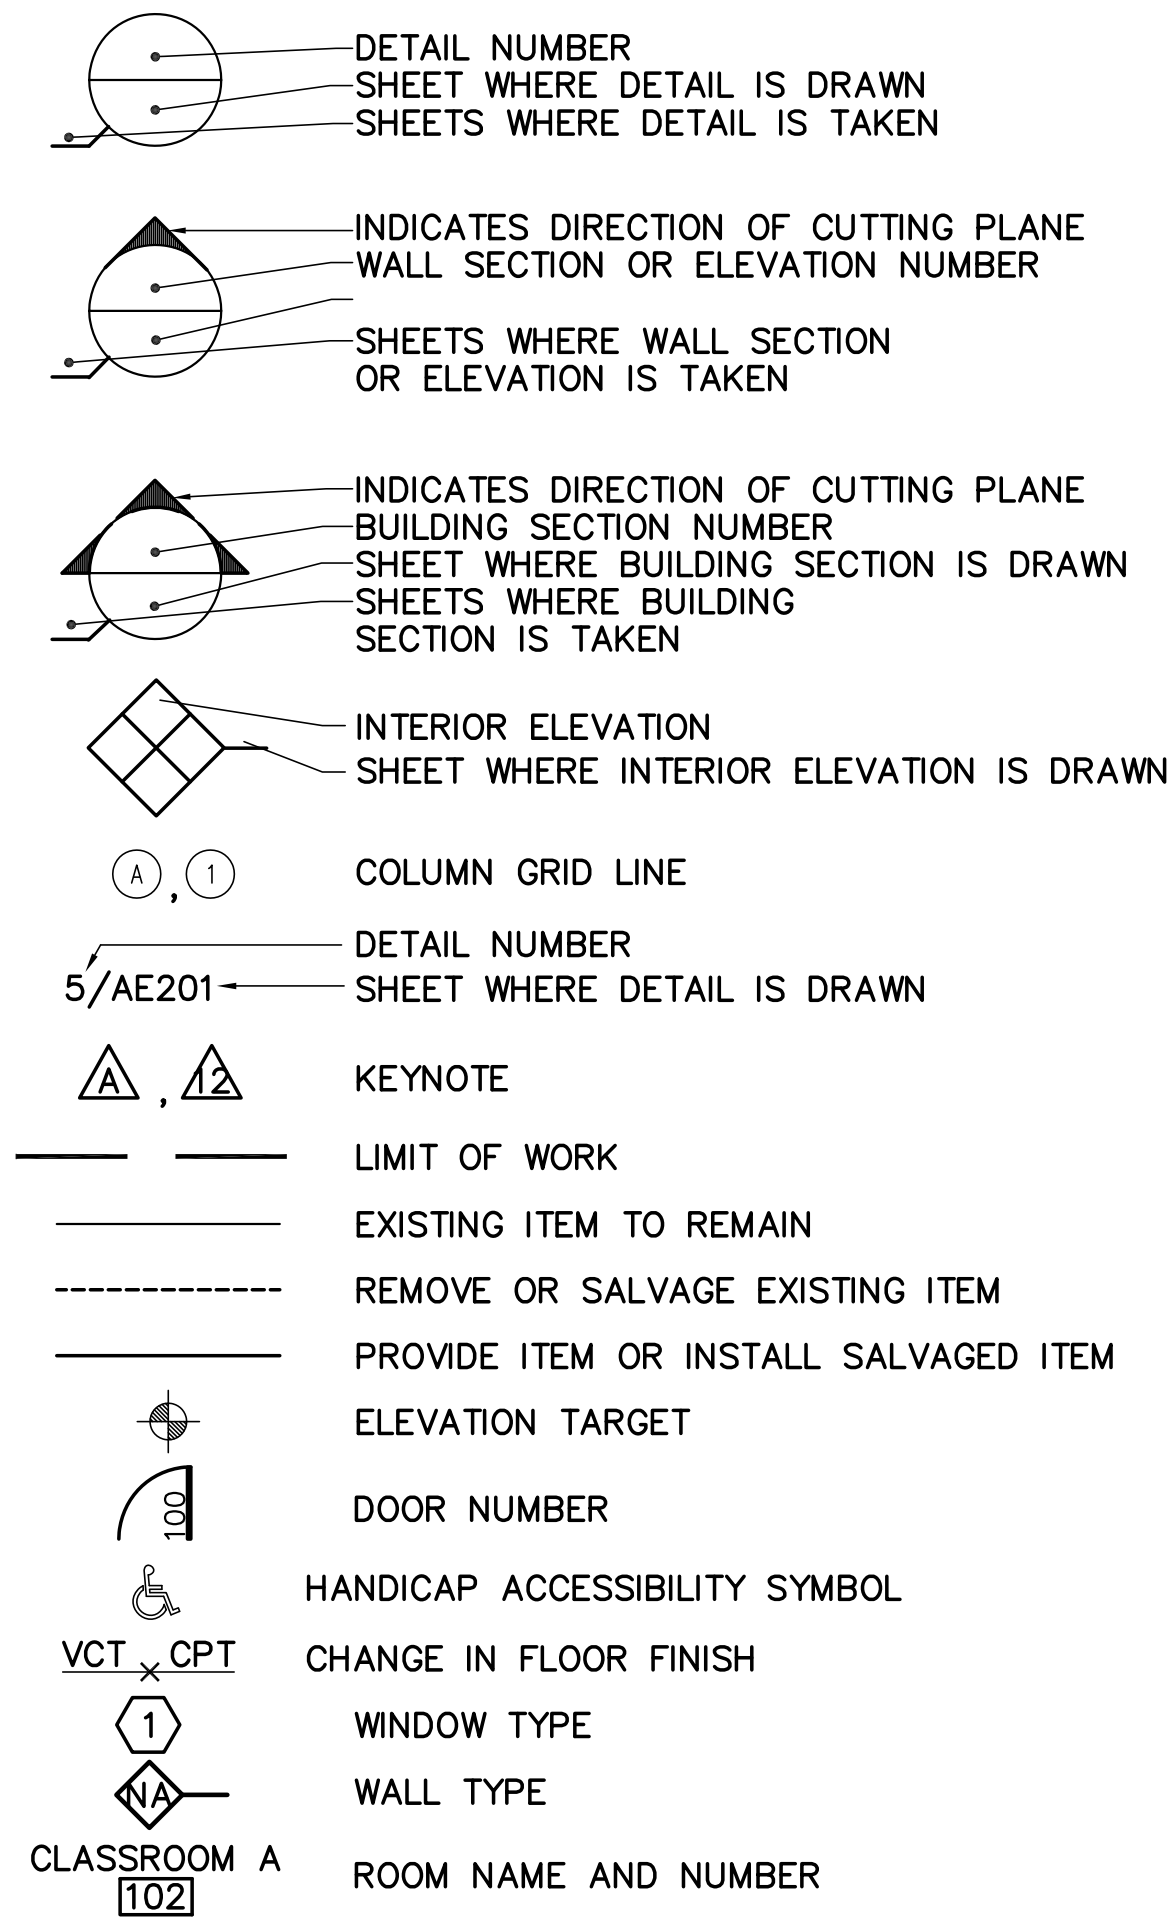

ABBREVIATIONS




&	AND	IBC	INTERNATIONAL BUILDING CODE
⊕	AT	INV	INVERT
±	PLUS/MINUS	LLV	LONG LEG VERTICAL
%	PERCENT	MAX	MAXIMUM
ADJ	ADJACENT	MDEP	MAINE DEPARTMENT OF ENVIRONMENTAL PROTECTION
AFF	ABOVE FINISH FLOOR	MECH	MECHANICAL
ALUM	ALUMINUM	MFRS	MANUFACTURE'S
ALT	ALTERNATE	MIN	MINIMUM OR MINUTE
APPROX	APPROXIMATE	MTD	MOUNTED
ASTM	AMERICAN SOCIETY FOR TESTING AND MATERIALS	MTL	NATIONAL FIRE PROTECTION ASSOCIATION
BD	BOARD	N	NORTH
BLDG	BUILDING	NFPA	
BOC	BOTTOM OF CURB	NO, #	NUMBER
⊕	CENTERLINE	OC	ON CENTER
CB	CATCH BASIN	OD	OUTSIDE DIAMETER
CJ	CONTROL JOINT	OSHA	OCCUPATIONAL SAFETY AND HEALTH ADMINISTRATION
CLG	CEILING	PLYWD	PLYWOOD
CLR	CLEAR	PPM	PARTS PER MILLION
CMP	CENTRAL MAINE POWER	PREFAB	PREFABRICATED
COOR	COORDINATE	PSI	POUNDS PER SQUARE INCH
CONC	CONCRETE	PT	PRESSURE TREATED
CONT	CONTINUOUS	PTD	PAINT, PAINTED
DIA, Ø	DIAMETER	PVC	POLYVINYL CHLORIDE
DN	DOWN	R	RADIUS
DWG	DRAWING	RCP	REINFORCED CONCRETE PIPE
EA	EACH	REINF	REINFORCED
ELEV, EL	ELEVATION	SCFH	STANDARD CUBIC FOOT PER HOUR
ERD	EXISTING ROOF DRAIN	SF	SQUARE FOOT
ERV	EXISTING ROOF VENT	SIM	SIMILAR
EW	EACH WAY	SQ	SQUARE
EXIST	EXISTING	SS	STAINLESS STEEL
EXT	EXTERIOR	STL	STEEL
EQ	EQUAL	SY	SQUARE YARD
F	FINISH	SYS	SYSTEM
FDN	FOUNDATION	TBM	TEMPORARY BENCH MARK
FE	FIRE EXTINGUISHER	TOC	TOP OF CURB
FF	FINISH FLOOR	TYP	TYPICAL
FFE	FINISH FLOOR ELEVATION	UL	UNDERWRITERS LABORATORY
FO	FIBER OPTIC	UNE	UNIVERSITY OF NEW ENGLAND
FT	FOOT	UON	UNLESS OTHERWISE NOTED
GA	GAGE	VERT	VERTICAL
GAL	GALLON	VIF	VERIFY IN FIELD
HORIZ	HORIZONTAL	W/	WITH
HM	HOLLOW METAL	WWF	WELDED WIRE FABRIC
HP	HIGH POINT		

LIST OF DRAWINGS

1	OF	26	G-001	COVER SHEET
2	OF	26	G-002	LIST OF DRAWINGS, ABBREVIATIONS, MAP & GENERAL NOTES
3	OF	26	G-101	CODE INFORMATION
4	OF	26	CX101	EXISTING CONDITIONS/REMOVALS SITE PLAN
5	OF	26	CS101	SITE PLAN
6	OF	26	S-001	STRUCTURAL NOTES, DESIGN LOADS AND ABBREVIATIONS
7	OF	26	SD101	EXISTING FOUNDATION REMOVALS PLAN AND DETAILS
8	OF	26	SB101	ELEVATOR ADDITION FOUNDATION PLAN AND DETAILS
9	OF	26	SF101	ELEVATOR ADDITION FRAMING PLANS
10	OF	26	SF201	ELEVATOR ADDITION CMU WALL ELEVATIONS
11	OF	26	SF501	STRUCTURAL DETAILS
12	OF	26	AD101	REMOVALS FLOOR PLANS AND REFLECTED CEILING PLAN
13	OF	26	AD201	REMOVALS ELEVATION AND BUILDING SECTION
14	OF	26	AE101	FLOOR PLANS, ROOF PLAN AND REFLECTED CEILING PLAN
15	OF	26	AE201	EXTERIOR ELEVATIONS & BUILDING SECTION
16	OF	26	AE301	WALL SECTIONS AND DETAILS
17	OF	26	AE302	DETAILS
18	OF	26	AE701	FINISHES AND INTERIOR ELEVATIONS
19	OF	26	M-001	MECHANICAL, PLUMBING AND FIRE PROTECTION LEGENDS, SYMBOLS, ABBREVIATIONS, DETAILS AND SCHEDULES
20	OF	26	MD101	MECHANICAL AND PLUMBING REMOVALS PLANS
21	OF	26	M-101	MECHANICAL, PLUMBING AND FIRE PROTECTION PLANS
22	OF	26	E-001	ELECTRICAL SYMBOLS, ABBREVIATIONS, GENERAL NOTES AND SCHEDULES
23	OF	26	E-002	ELECTRICAL SPECIFICATIONS
24	OF	26	ED101	BASEMENT, FIRST, AND SECOND FLOOR ELECTRICAL REMOVALS PLANS
25	OF	26	E-101	ELECTRICAL PLANS
26	OF	26	E-501	PANELBOARD, LIGHTING FIXTURE AND WIRING SCHEDULES, AND DIAGRAMS

GENERAL CONSTRUCTION NOTES

- CONFORM TO STATE, NATIONAL AND OTHER CODES AND ORDINANCES WHICH APPLY TO THIS PROJECT.
- ITEMS AND COMPONENTS SHOWN ON THE DRAWINGS SHALL BE PROVIDED UNLESS NOTED AS EXISTING.
- WORK FROM GIVEN DIMENSIONS AND LARGE SCALE DETAILS. DO NOT SCALE DRAWINGS.
- VERIFY EXISTING CONDITIONS AND DIMENSIONS AND REPORT DISCREPANCIES TO THE OWNER'S REPRESENTATIVE. PROCEED WITH THE WORK AFTER THE DISCREPANCIES HAVE BEEN RESOLVED BY THE OWNER.
- DO NOT PENETRATE JOISTS, BEAMS OR OTHER STRUCTURAL MEMBERS.
- MAINTAIN CONSTRUCTION SITE IN A NEAT, CLEAN AND SAFE MANNER.
- OBTAIN STATE AND LOCAL PERMITS THAT ARE REQUIRED FOR THE SATISFACTORY COMPLETION OF THE WORK. COMPLY WITH PERMIT APPROVAL CONDITIONS. PAY ASSOCIATED FEES.
- DISPOSE OF AND/OR RECYCLE NON-HAZARDOUS CONSTRUCTION DEBRIS FROM THE PROJECT SITE AS REQUIRED BY THE STATE OF MAINE AND AS REQUIRED BY THE CONTRACT. OBTAIN DISPOSAL PERMITS THAT ARE REQUIRED. PAY ASSOCIATED FEES. DO NOT USE OWNER'S DUMPSTERS.
- PROTECT EXISTING SYSTEMS AND SURFACES TO REMAIN. DAMAGE RESULTING FROM THE CONTRACTOR'S OPERATIONS SHALL BE REPAIRED OR REPLACED AS APPROVED BY THE OWNER AT NO ADDITIONAL COST TO THE OWNER.
- OBTAIN APPROVAL FROM THE OWNER FOR THE SEQUENCE AND TIMING OF OPERATIONS PRIOR TO COMMENCING WORK.
- COMPLY WITH THE MORE STRINGENT OF INDICATED REQUIREMENTS, CODE REQUIREMENTS, AND INDUSTRY STANDARDS. WHERE CONFLICTS OCCUR WITHIN THE DOCUMENTS, THE MORE STRINGENT SHALL APPLY.
- COORDINATE WITH THE OWNER FOR EXISTING EQUIPMENT TO BE REMOVED AND RELOCATED BY CONTRACTOR.

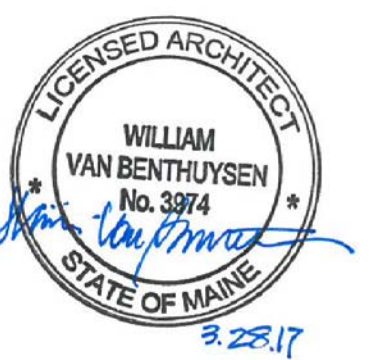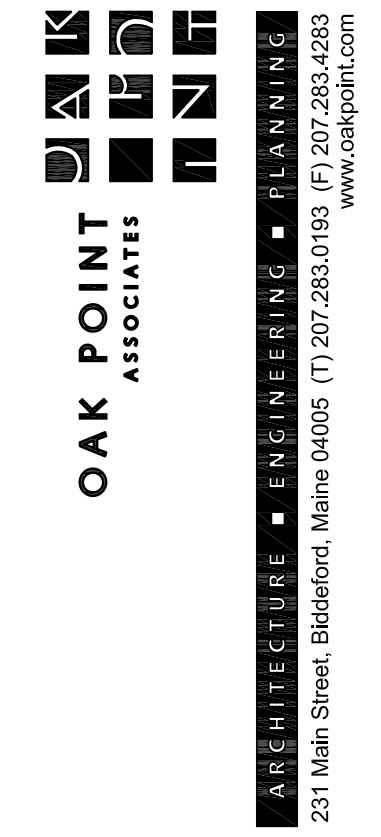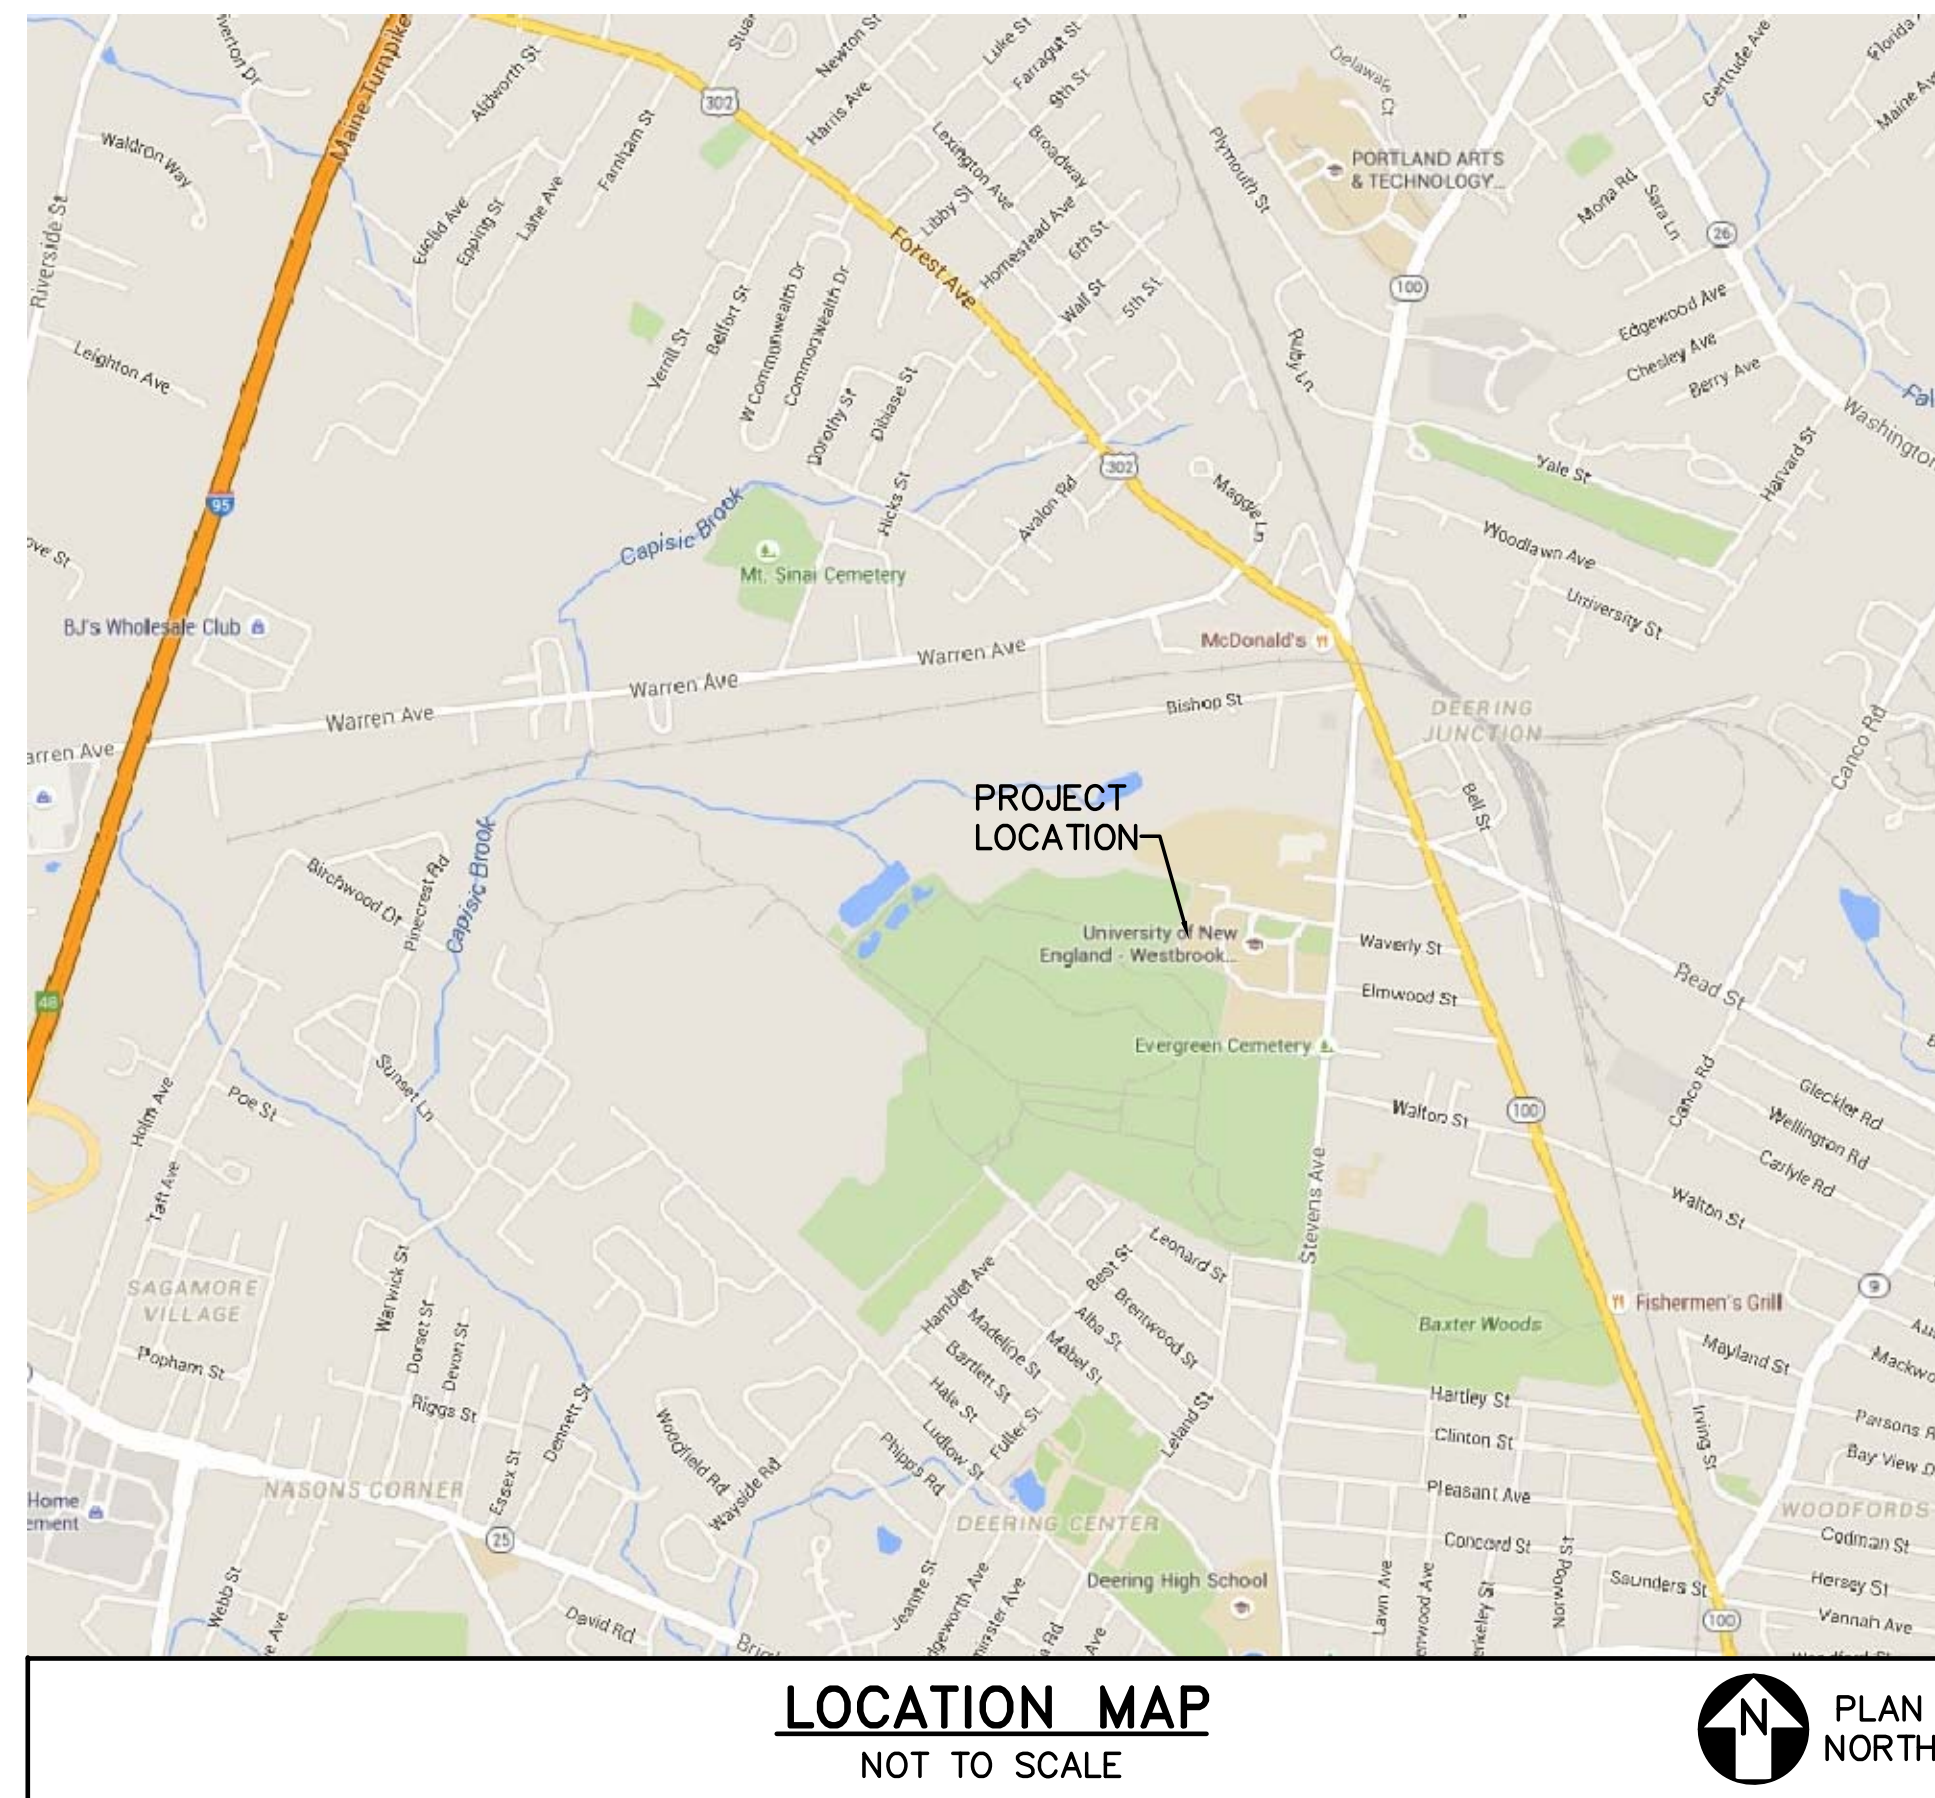

DESIGNED BY: WVB
DRAWN BY: CAM
CHECKED BY: WVB
PROJECT: 21602.16

UNIVERSITY OF NEW ENGLAND
PORTLAND CAMPUS
Fine Arts Gallery
716 Stevens Avenue
Portland, ME 04103-2693

FINE ARTS GALLERY
ELEVATOR ADDITION
FOR PERMITTING ONLY - NOT FOR CONSTRUCTION

LIST OF DRAWINGS,
ABBREVIATIONS
MAP & GENERAL NOTES

SCALE: AS NOTED

DATE: 3-29-17

DWG. **G-002**

SHEET: 2 OF 26