



1 CENTER CIRCLE PREPARED PLANT BED
SCALE: N.T.S.


- NOTES:
1. ALL PAVERS SHALL BE SAW CUT ONLY. NO FRAGMENT SHALL BE SMALLER THAN 2". FINAL SURFACE SHALL PITCH TO DRAIN PER GRADING PLAN.
 2. BRICK PAVER TO BE THE PATHWAY RED BRICK PAVER IN A 4-1/2"x4-1/2" SIZE AS MANUFACTURED BY PINE HALL BRICK AND DISTRIBUTED BY GENEST CONCRETE PRODUCTS OF WINDHAM AND SANFORD, MAINE OR APPROVED EQUIVALENT. BRICK SAMPLES SHALL BE PROVIDED TO THE OWNER FOR APPROVAL PRIOR TO PURCHASING.
 3. POLYMERIC SAND TO BE GATOR XP SAND AS MANUFACTURED BY ALLIANCE DESIGNER PRODUCTS AND DISTRIBUTED BY GENEST CONCRETE PRODUCTS OR APPROVED EQUIVALENT.
 4. COMPACT BASE GRAVELS TO 95% OF THEIR DRY MAXIMUM DENSITY.

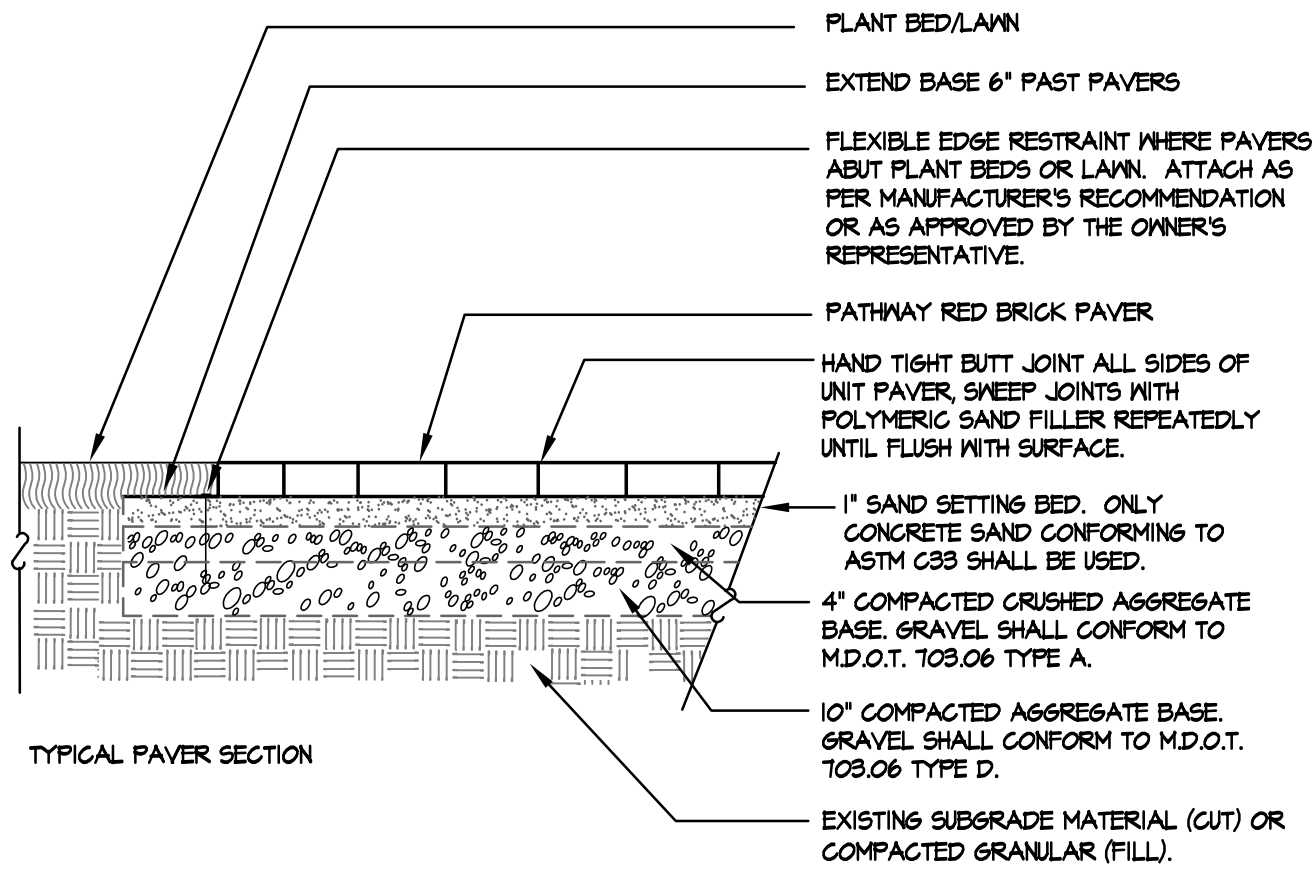

5 BRICK PAVER INSTALLATION
SCALE: N.T.S.

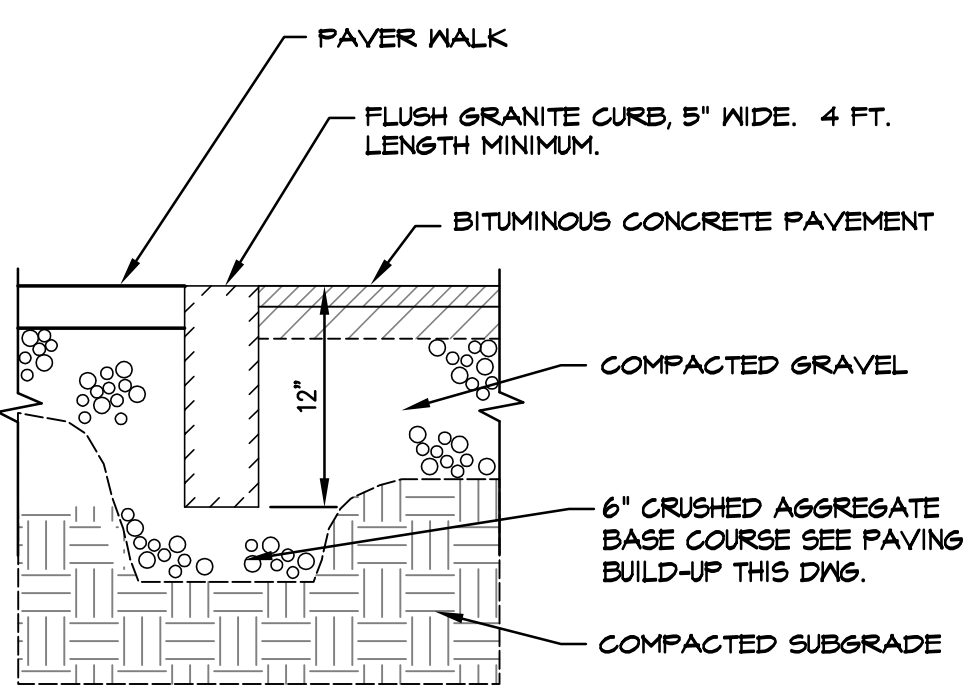


9 FLUSH GRANITE EDGE / CURB
SCALE: N.T.S.

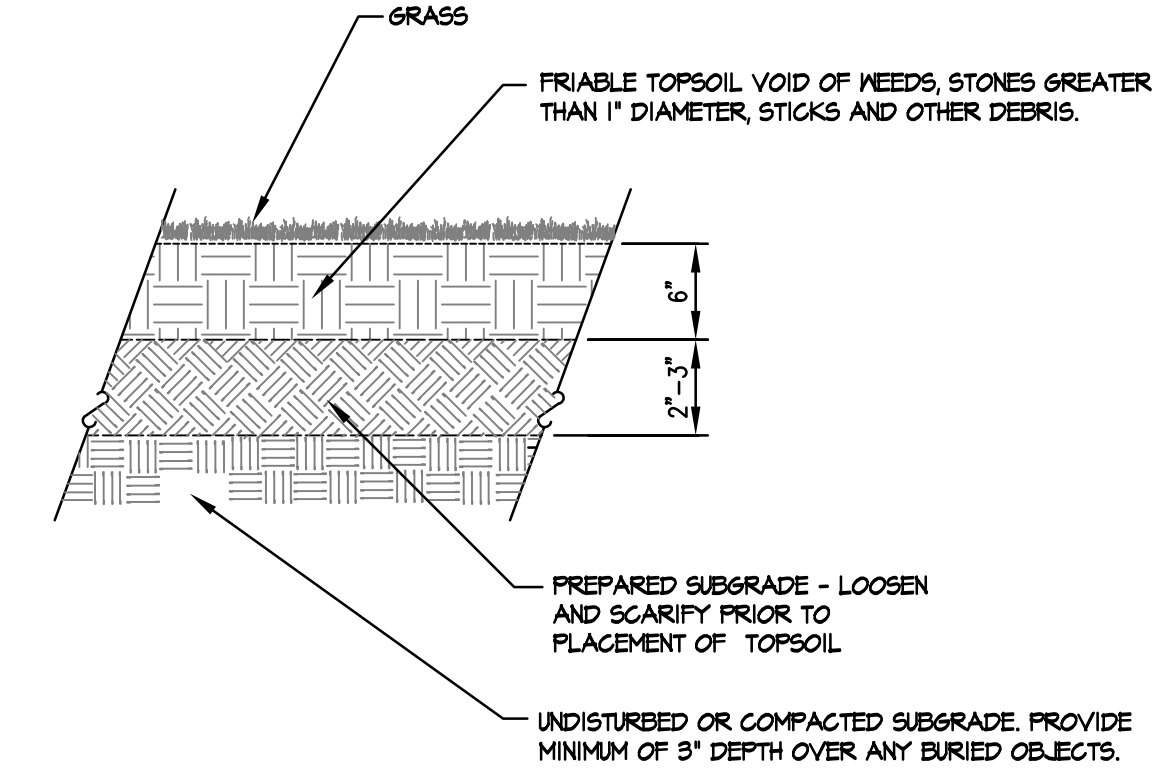


2 LAWN INSTALLATION (SEED OR SOD)
SCALE: N.T.S.


- NOTES:
1. ALL PAVERS SHALL BE SAW CUT ONLY. NO FRAGMENT SHALL BE SMALLER THAN 2". FINAL SURFACE SHALL PITCH TO DRAIN PER GRADING PLAN.
 2. CONCRETE UNIT PAVERS SHALL BE THE TREVIA TUMBLED PAVER IN ASH CHARCOAL COLOR AS MANUFACTURED BY RINOX OF MONTREAL, CANADA (1-888-855-4444) OR DISTRIBUTED BY LANDSCAPERS DEPOT OF KINGSTON, NH (603-642-6677). SAMPLES SHALL BE PROVIDED TO THE OWNER PRIOR TO PURCHASE FOR APPROVAL.
 3. POLYMERIC SAND TO BE GATOR XP SAND AS MANUFACTURED BY ALLIANCE DESIGNER PRODUCTS AND DISTRIBUTED BY GENEST CONCRETE PRODUCTS OR APPROVED EQUIVALENT.
 4. COMPACT BASE GRAVELS TO 95% OF THEIR DRY MAXIMUM DENSITY.
 5. UNIT PAVER PATTERN SHALL MATCH THE CAMPUS'S EXISTING TREVIA PAVER PATTERNS.

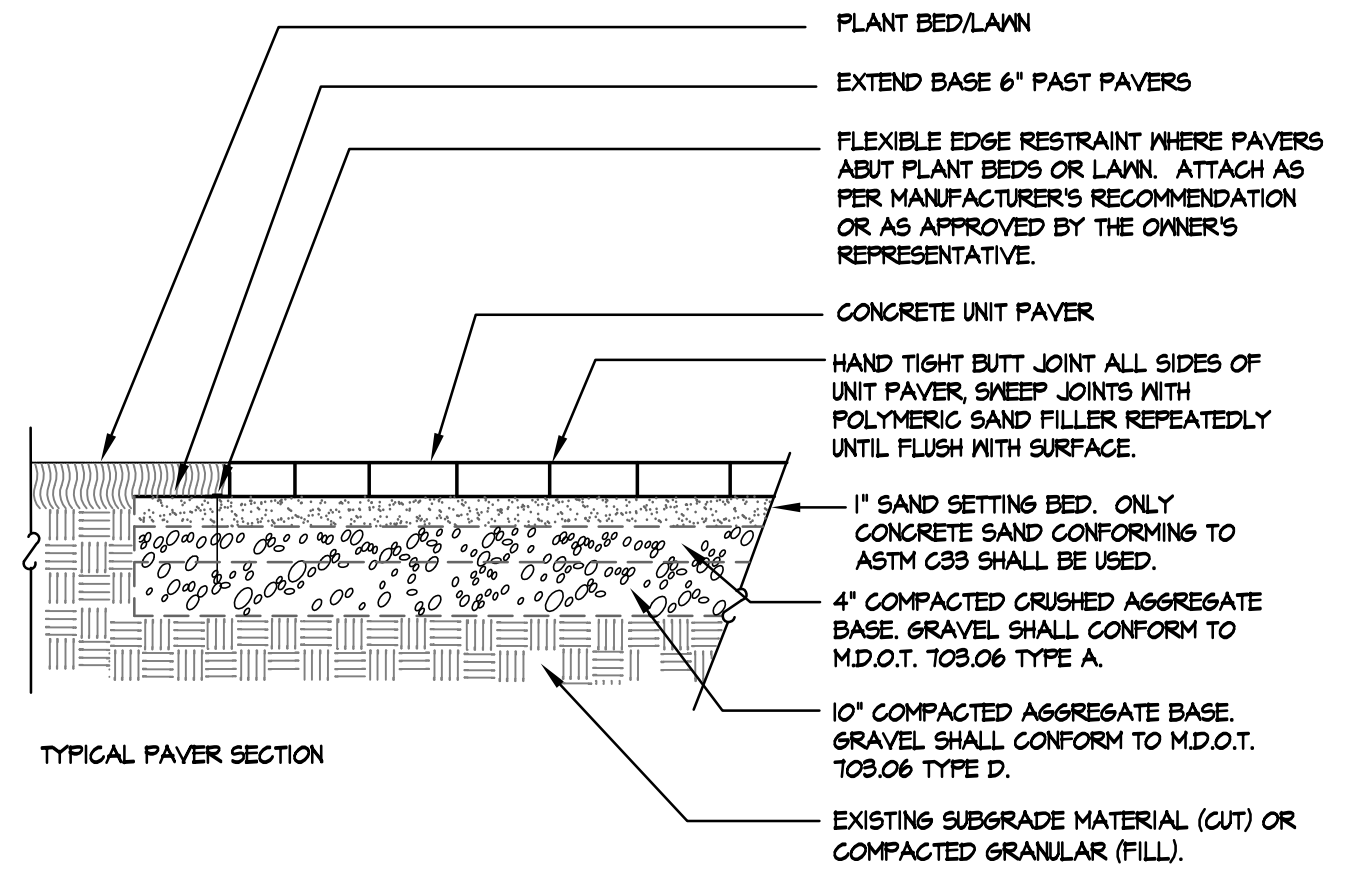


6 CONCRETE UNIT PAVER INSTALLATION
SCALE: N.T.S.

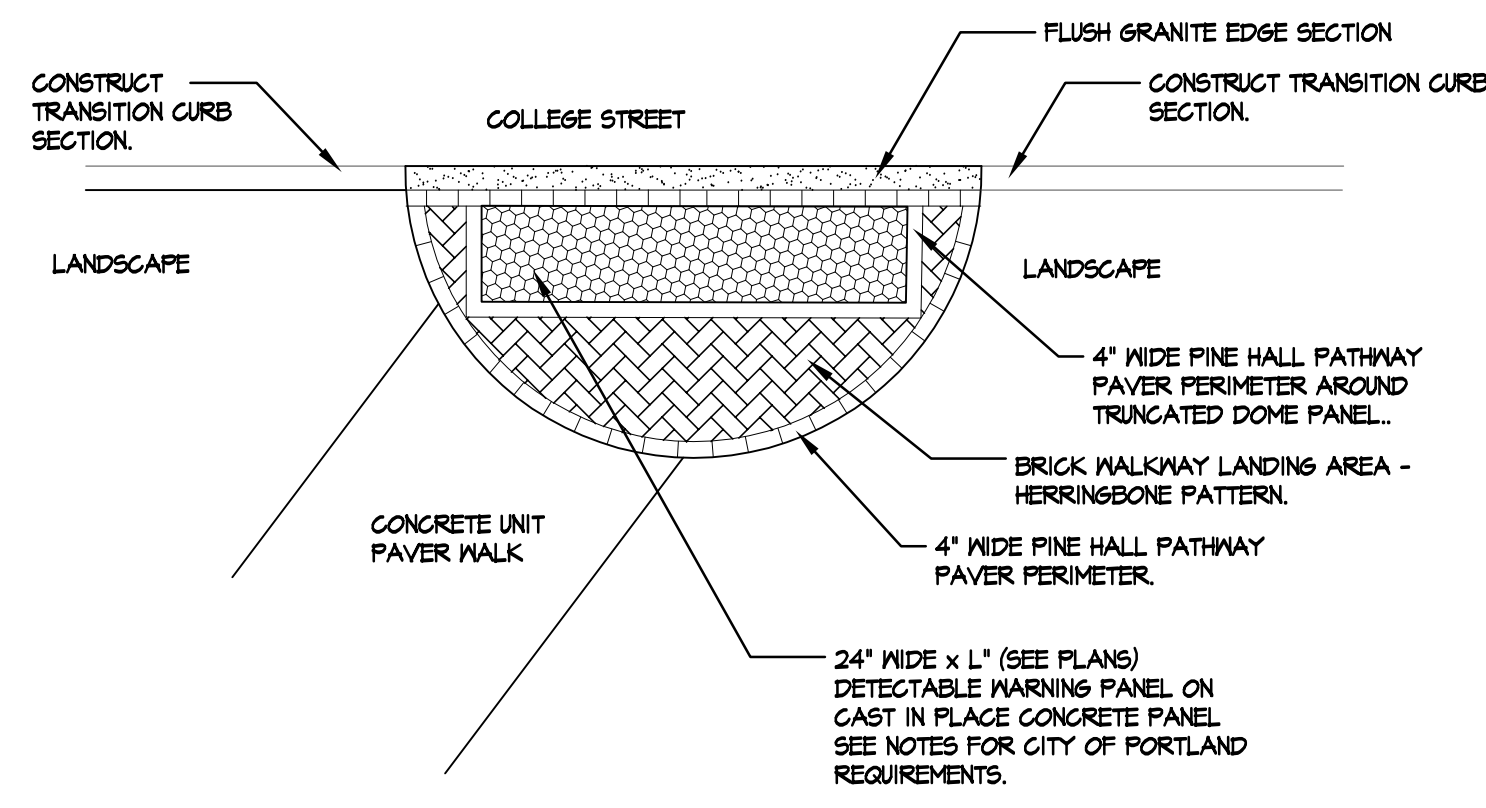

10 COLLEGE STREET CROSSWALK LANDING AREAS WITH DETECTABLE WARNING PANELS
SCALE: N.T.S.

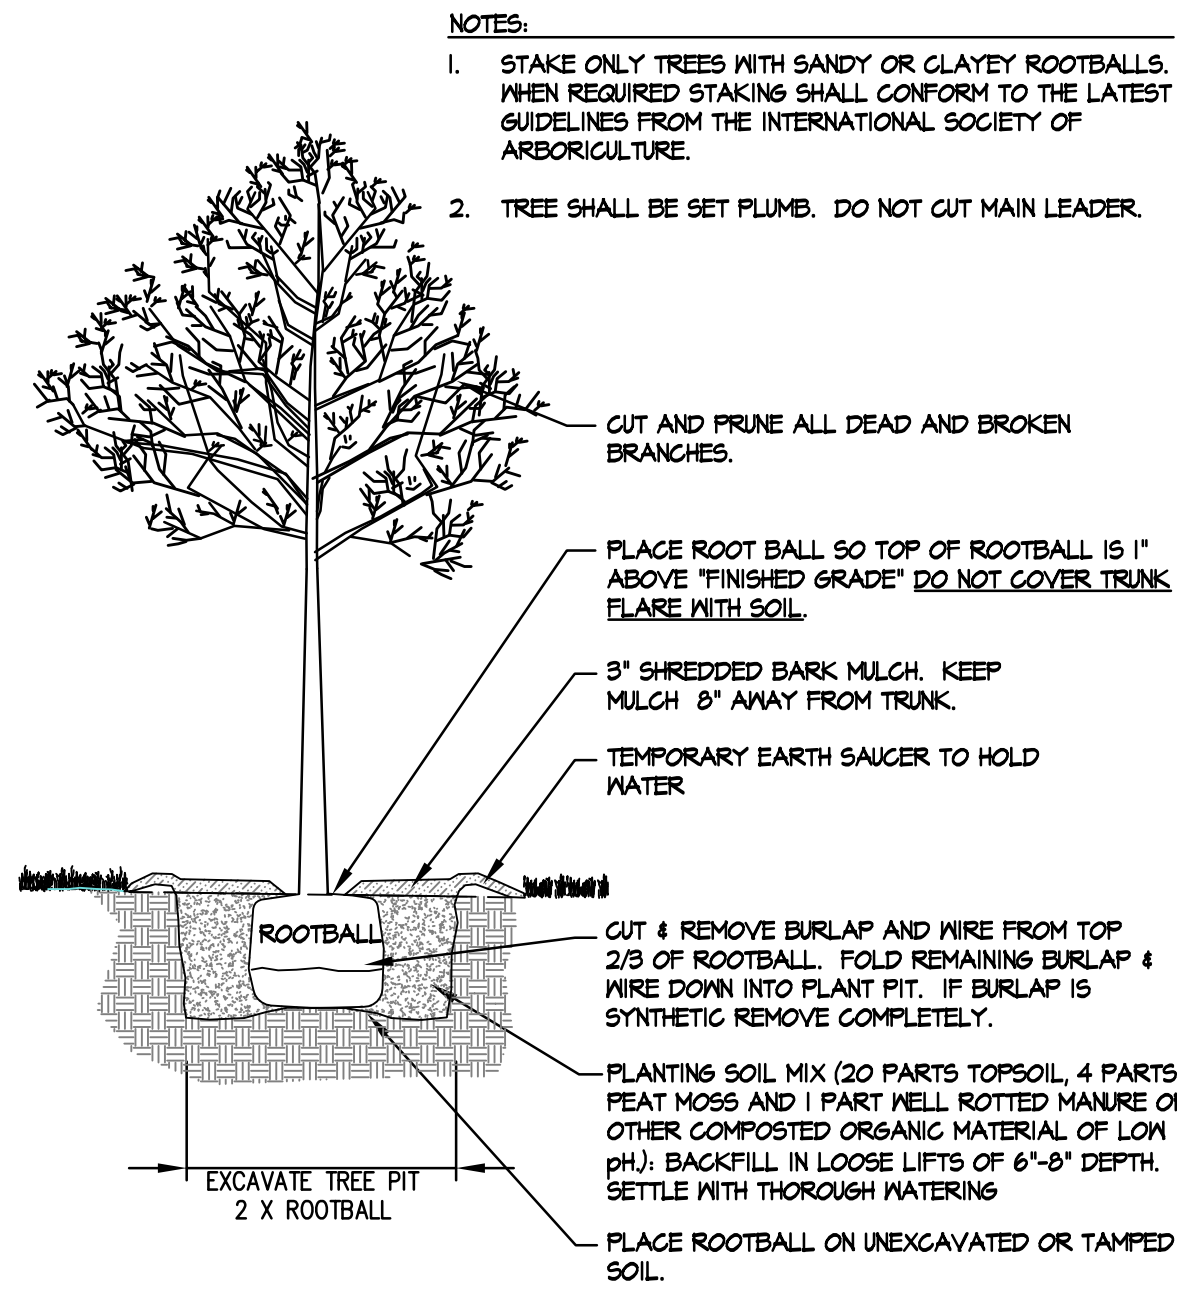


3 DECIDUOUS TREE PLANTING
SCALE: N.T.S.

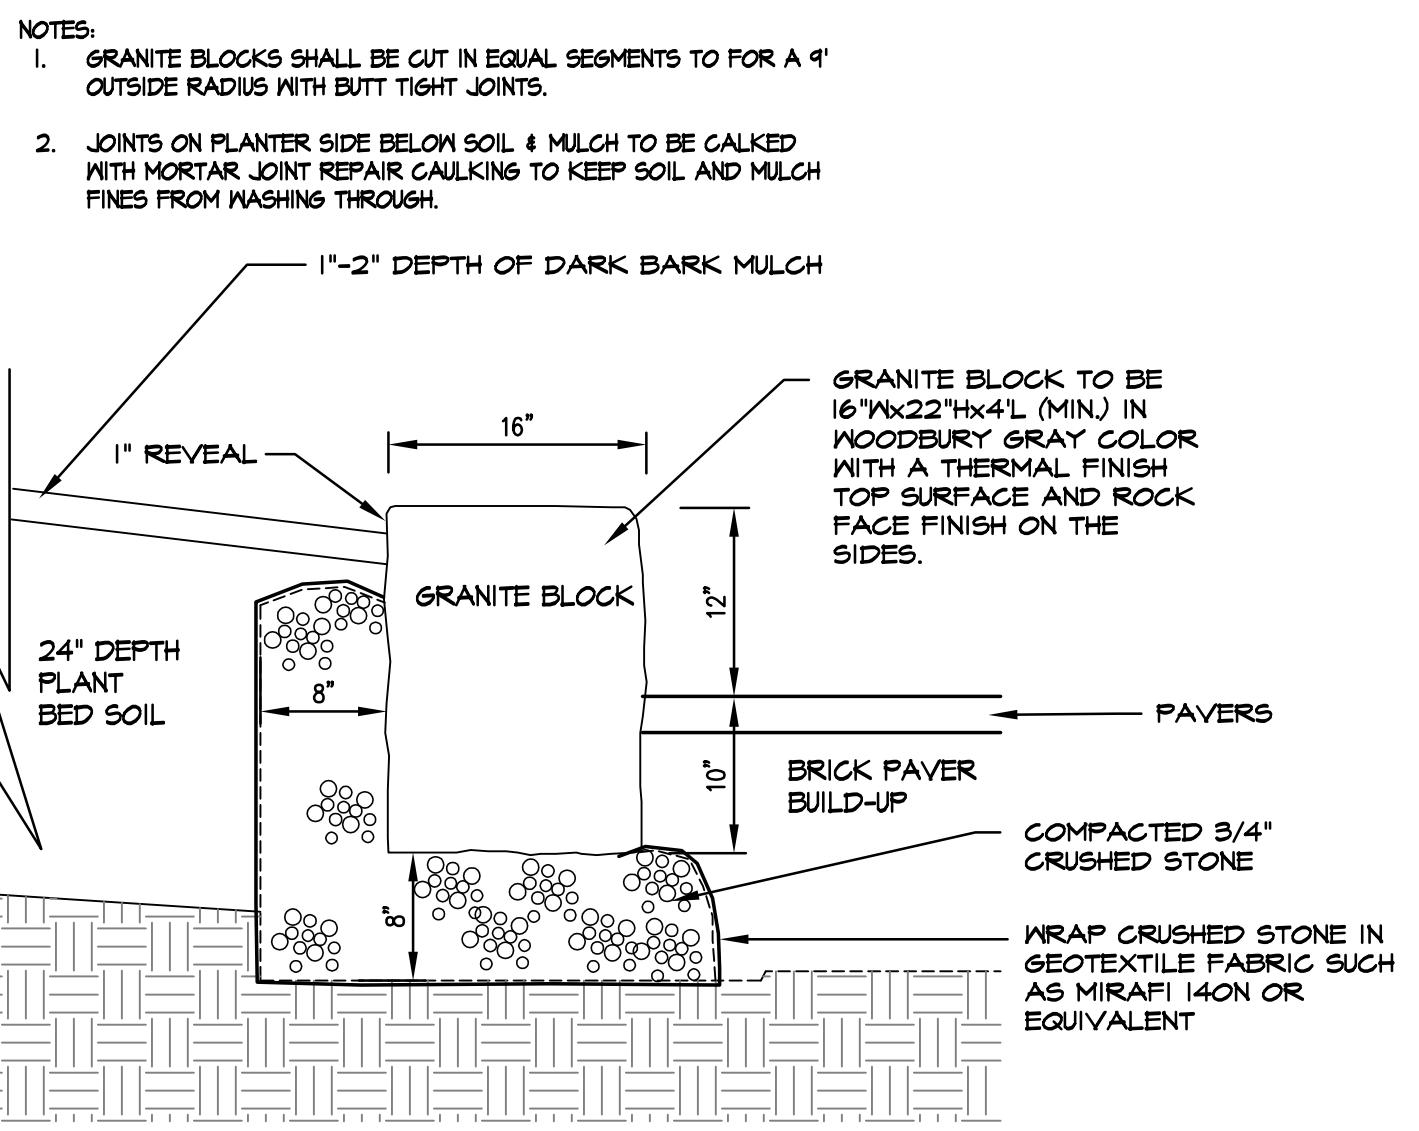


7 CIRCLE GARDEN GRANITE EDGING
SCALE: N.T.S.

- NOTES:
1. DIMENSIONS ARE SUBJECT TO CHANGE IN FIELD. ALL SLOPES AND DIMENSIONS TO COMPLY WITH ADA REQUIREMENTS.
 2. CONTRACTOR TO INSTALL 24" WIDE DETECTABLE WARNING STRIP PER ADA GUIDELINES AND THE CITY OF PORTLAND TECHNICAL STANDARDS FIGURE I-TA. DETECTABLE WARNING PANELS SHALL BE COMPOSITE (NET SET (REPLACEABLE)) IN DARK GRAY COLOR (#8618) AS MANUFACTURED BY ADA SOLUTIONS INC. OR APPROVED EQUIVALENT.
 3. CONCRETE PANELS SHALL BE CAST IN PLACE, 5" THICK AND MEET SPECIFICATIONS FOR MAINE D.O.T. CLASS A STRUCTURAL CONCRETE. MINIMUM COMPRESSIVE STRENGTH 4,000 PSI. CONCRETE SHALL BE SEALED PRIOR TO SETTING PANELS.
 4. CONTRACTOR SHALL PROVIDE THE OWNER'S REPRESENTATIVE WITH SHOP DRAWING SHOWING INSTALLATION AND DIMENSIONS OF ALL CURBING, WALKS AND TACTILE WARNING PANELS FOR REVIEW AND APPROVAL PRIOR TO CONSTRUCTION.
 5. ALL WORK IN THE CITY OF PORTLAND STREET RIGHT OF WAY MUST MEET THE CITY TECHNICAL STANDARDS AND IS SUBJECT TO CITY REVIEW.


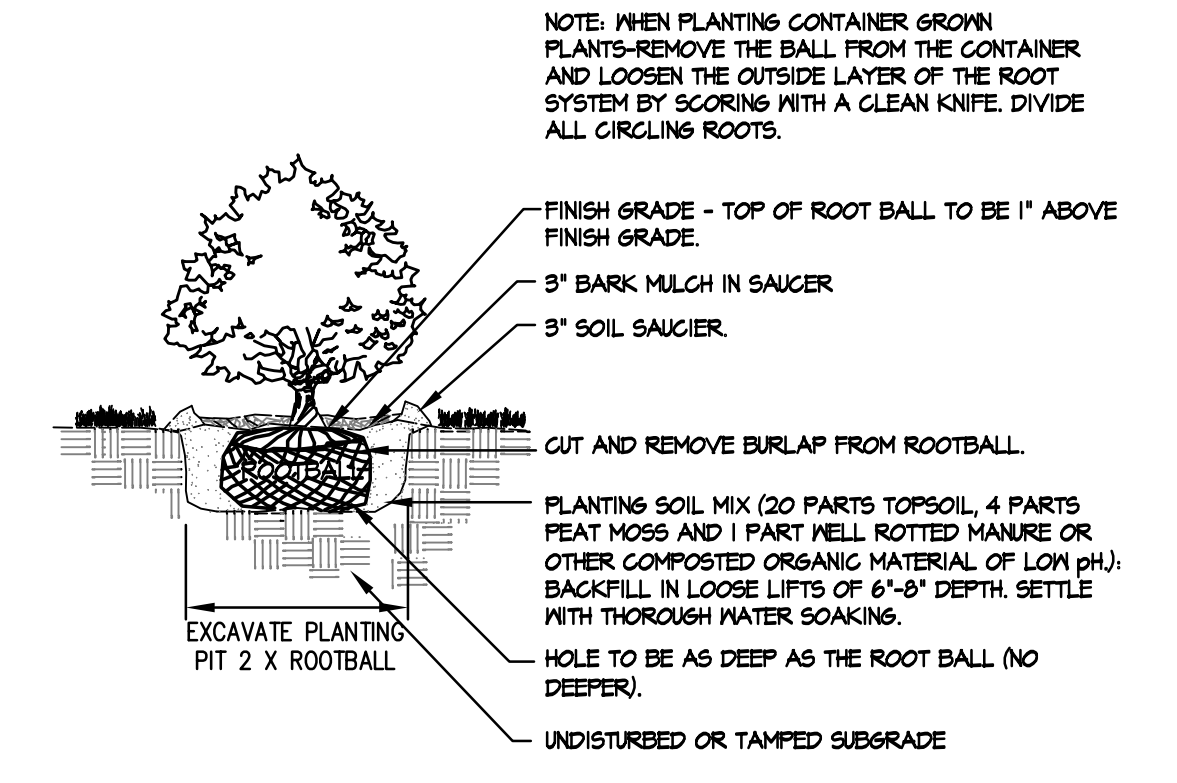


4 SHRUB PLANTING DETAIL
SCALE: N.T.S.

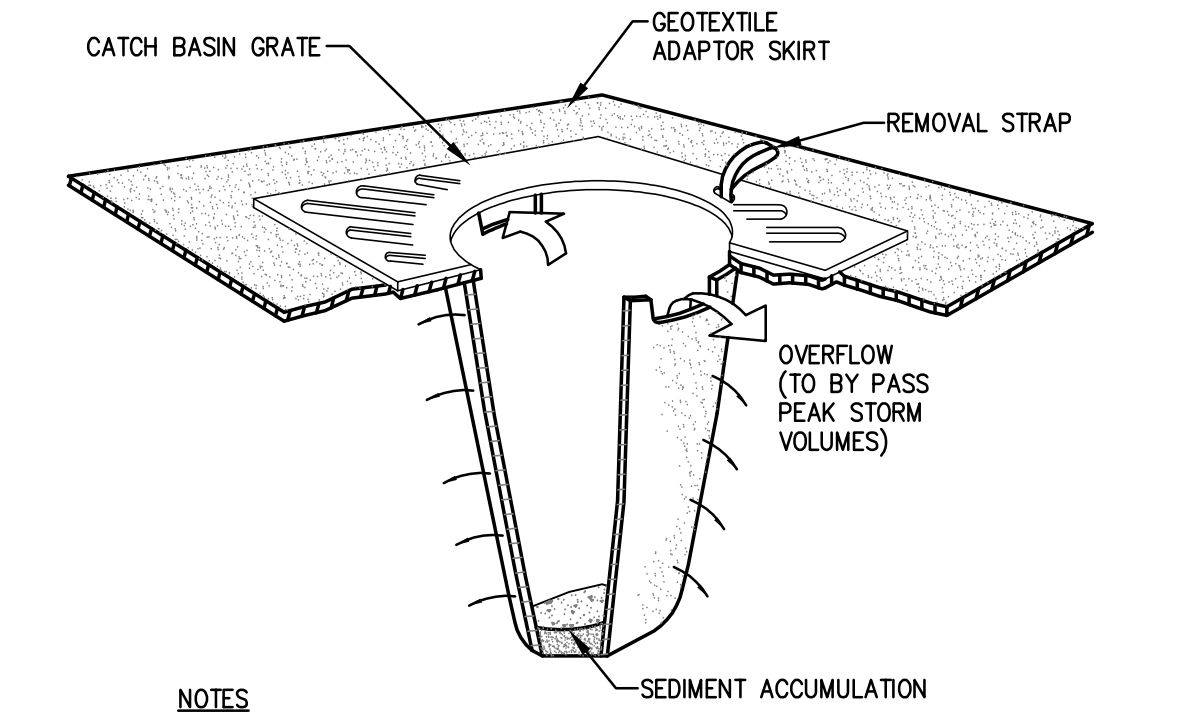


- NOTES:
1. CATCH BASIN PROTECTION TO BE "SILTSTACK" (BY ACF ENVIRONMENTAL) OR "STREAM GUARD" (BY FOSS ENVIRONMENTAL SERVICES). INSERT TO BE EMPTIED IN AN APPROVED MANNER WHEN IT IS 1/2 FULL OF SEDIMENT.
 2. INSPECT INSERT AFTER ALL RAINFALL EVENTS, REPAIR AND MAINTAIN AS REQUIRED.

8 TEMPORARY INLET PROTECTION
SCALE: N.T.S.

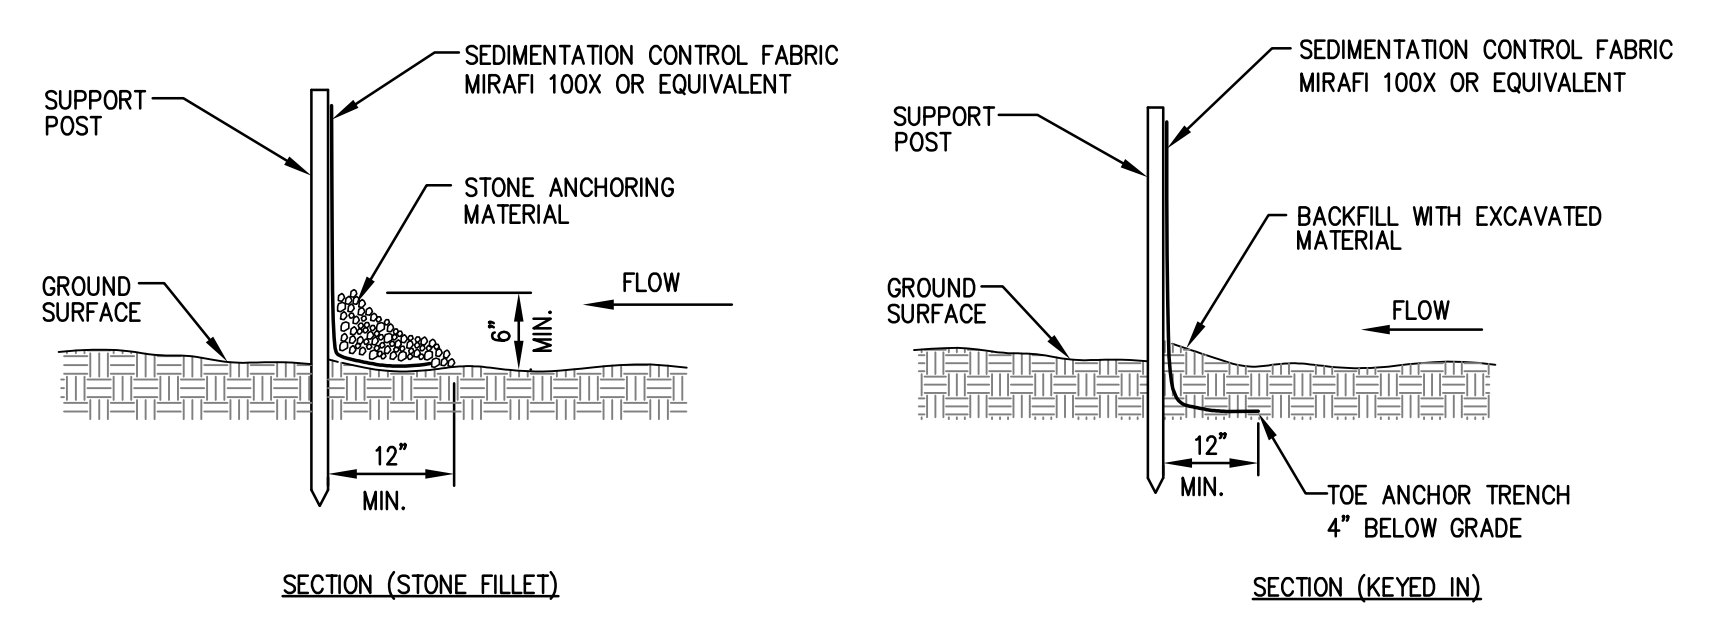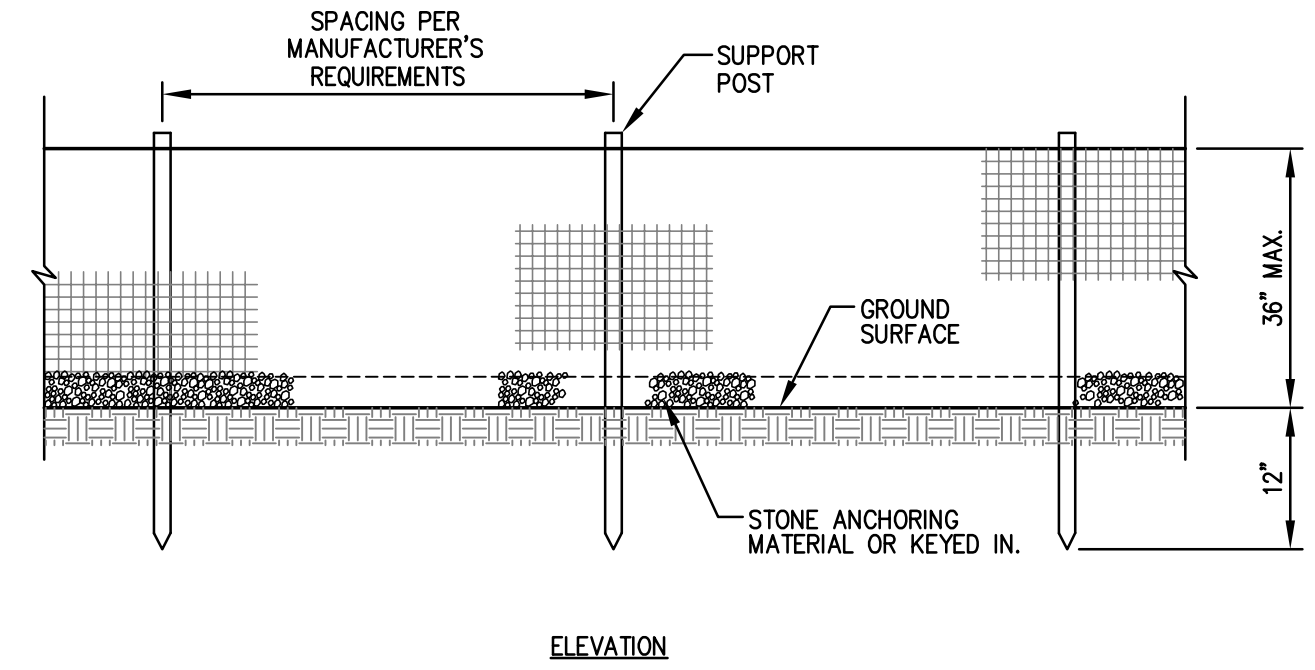

11 SILTATION FENCE
SCALE: N.T.S.

REV.	DATE	STATUS	BY	CHKD.	APPD.	REV.	DATE	STATUS	BY	CHKD.	APPD.
C	7/5/16	REVISED PER CITY OF PORTLAND COMMENTS AND RE-ISSUED									
B	6/8/16	ISSUED FOR CITY OF PORTLAND REVIEW	DEPT.	PBB	PBB						
1	2/25/16	ISSUED TO CLIENT	DEPT.	PBB	PBB						

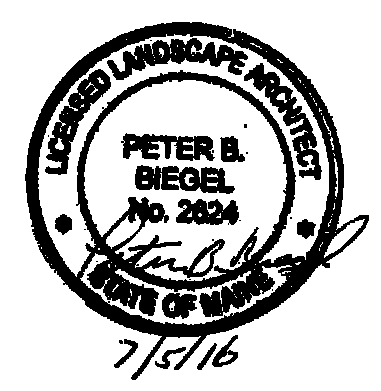

LAND DESIGN SOLUTIONS
LAND PLANNING, SITE PLANNING & LANDSCAPE ARCHITECTURE
P.O. Box 316, 160 Longwoods Road, Cumberland, ME 04021 tel:(207) 494-1117
CLIENT & OWNER:
UNIVERSITY OF NEW ENGLAND
11 HILLS BEACH ROAD, BIDDEFORD, ME 04005

DESIGN: PBB
DRAWN: DEPT.
CHKD: PBB
DATE: FEB. 2016
SCALE: AS NOTED

CAMPUS GREEN LANDSCAPE
STEVENS AVENUE, PORTLAND, MAINE

LANDSCAPE DETAILS

PROJ. NO. **16-401**
DWG. NO. **L-5**