


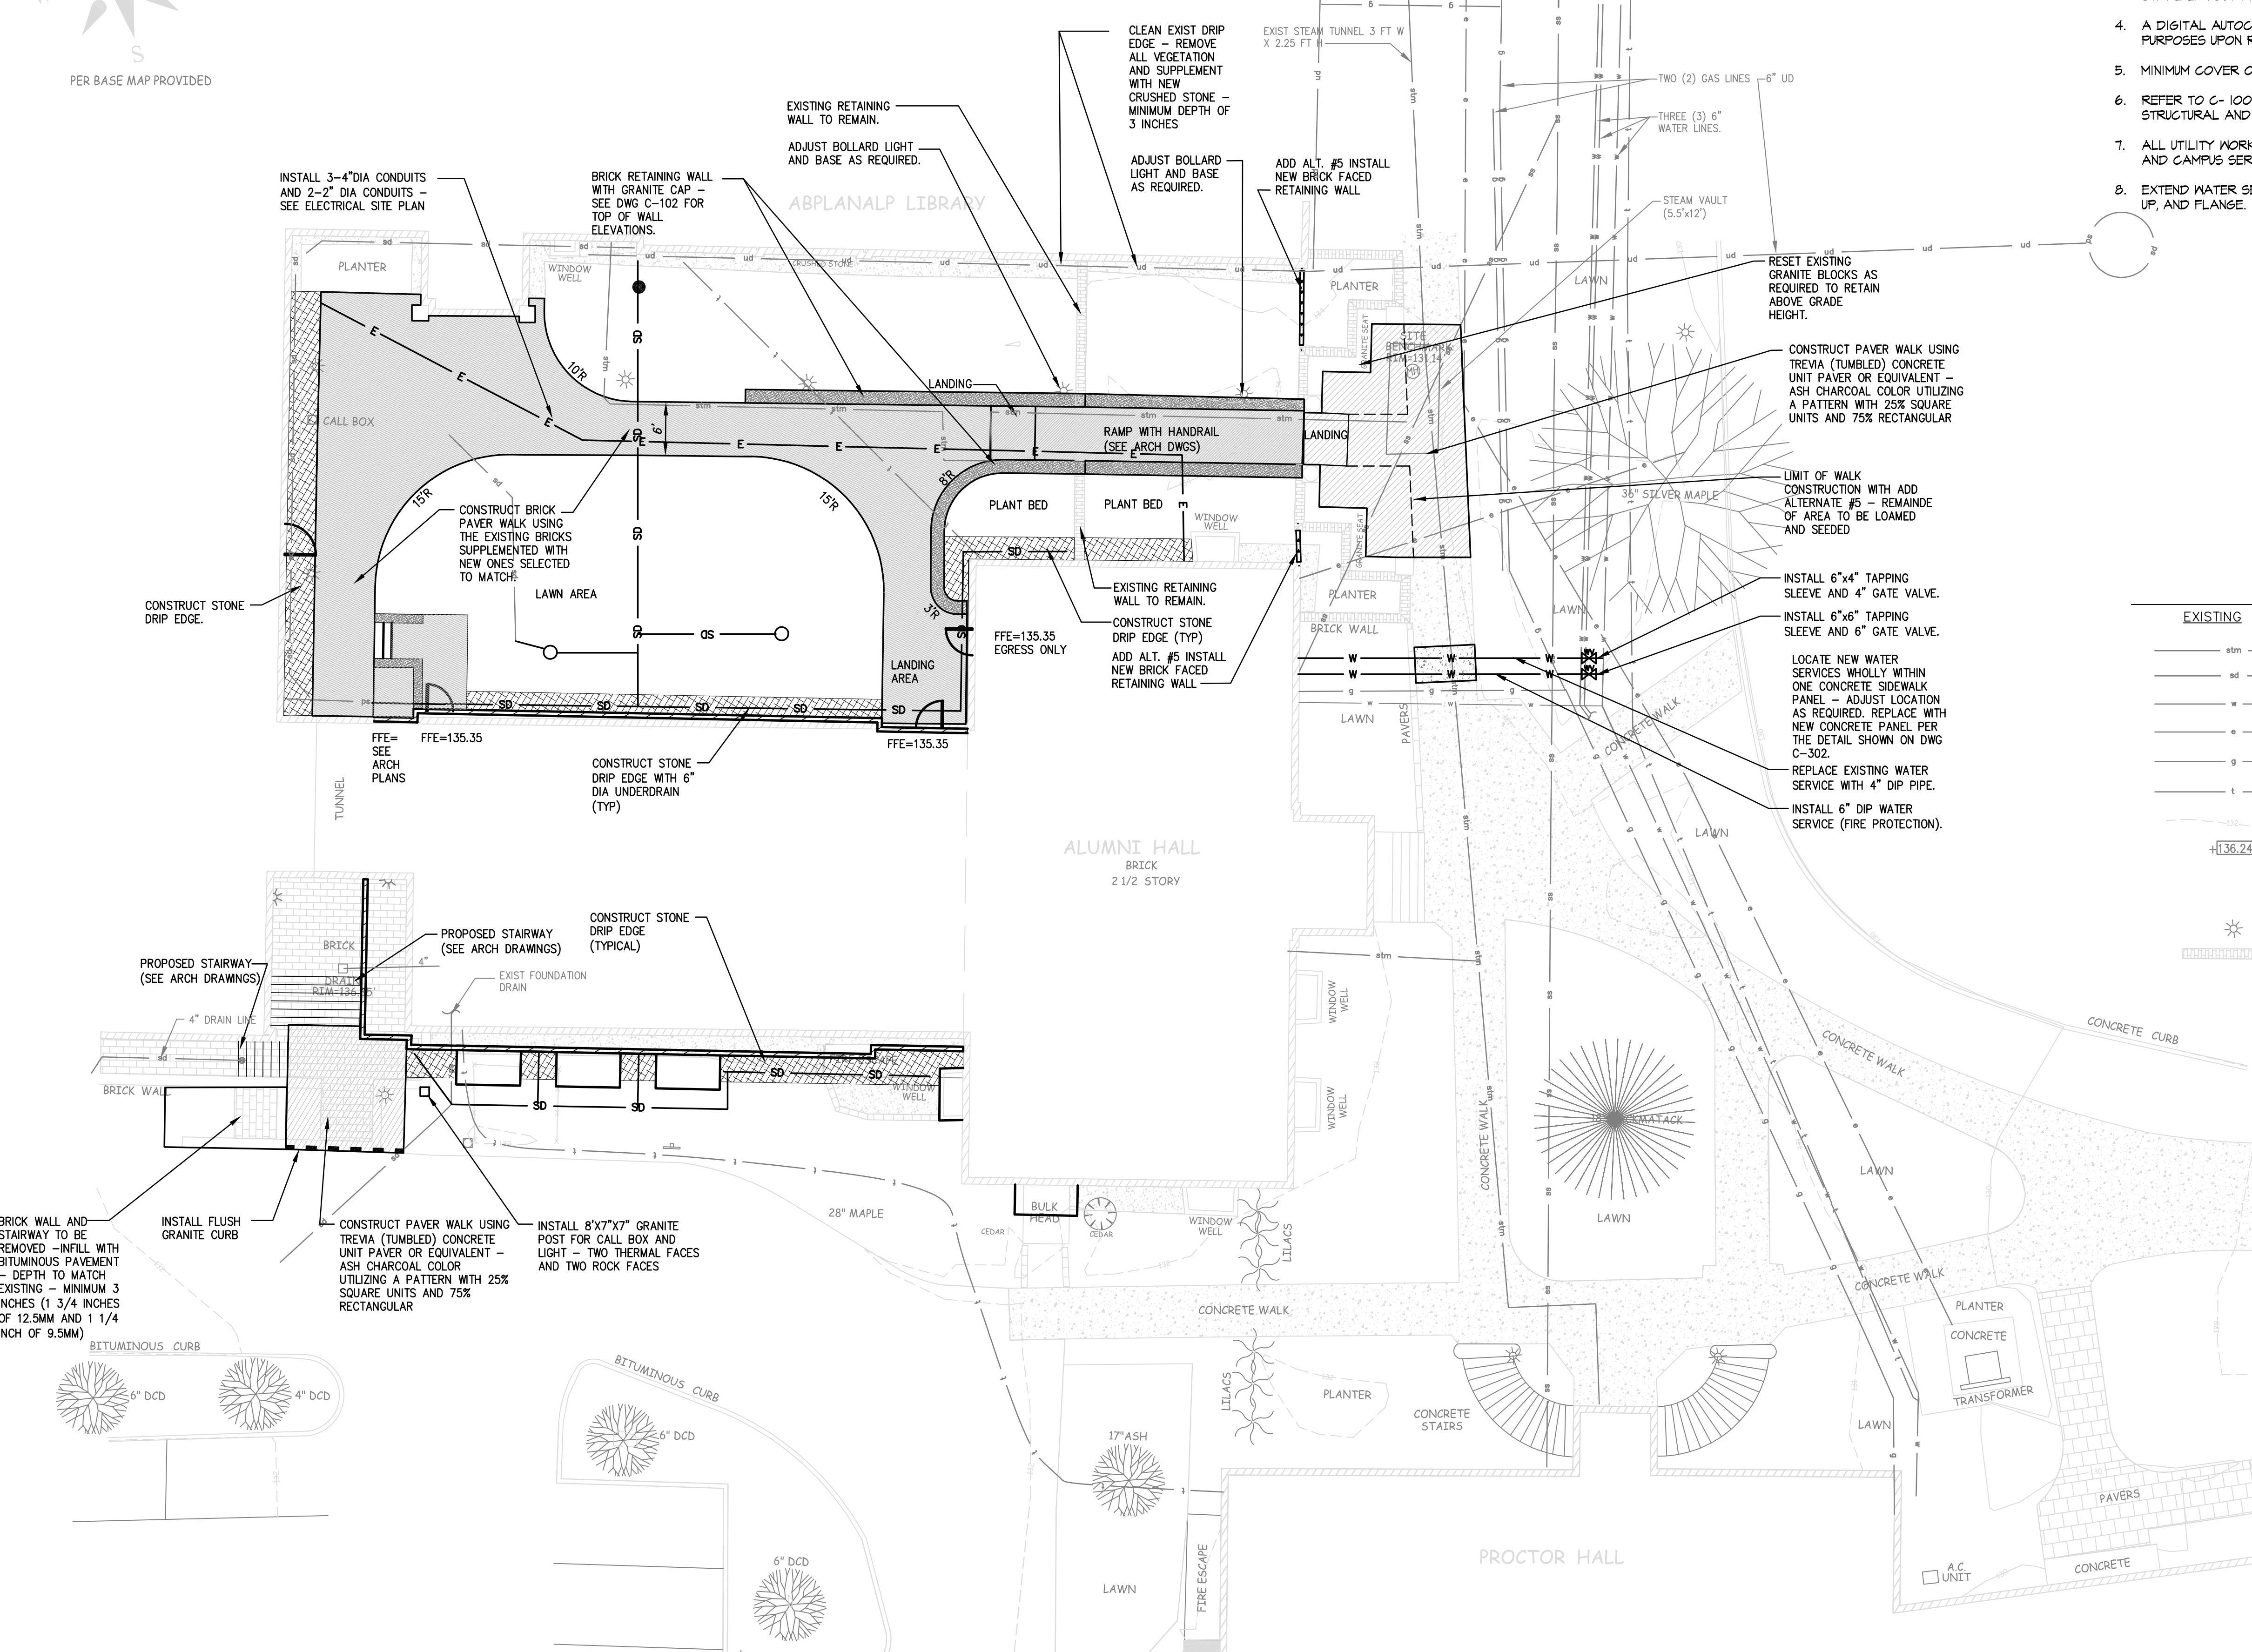


SITE PLAN NOTES:

1. ALL DIMENSIONS ARE PERPENDICULAR UNLESS OTHERWISE NOTED.
2. DO NOT SCALE DRAWINGS. ANY OMISSIONS IN DIMENSIONING SHALL BE REPORTED IMMEDIATELY TO THE OWNER'S REPRESENTATIVE.
3. CONTRACTOR SHALL VERIFY ALL DIMENSIONS IN THE FIELD PRIOR TO CONSTRUCTION. STAKE LAYOUT PRIOR TO CONSTRUCTION FOR APPROVAL BY THE OWNER.
4. A DIGITAL AUTOCAD FILE WILL BE SUPPLIED TO THE CONTRACTOR FOR LAYOUT PURPOSES UPON REQUEST.
5. MINIMUM COVER OVER WATER SERVICE SHALL BE 5'-6".
6. REFER TO C-100 THRU C-102 AND C-300 THRU C-302, ARCHITECTURAL, MECHANICAL, STRUCTURAL AND ELECTRICAL DRAWINGS FOR ADDITIONAL INFORMATION.
7. ALL UTILITY WORK AND SHUTDOWNS TO BE APPROVED BY UNE'S FACILITIES DEPARTMENT AND CAMPUS SERVICES.
8. EXTEND WATER SERVICES INTO BUILDING FOUNDATION AND PROVIDE A 90 DEGREE BEND, UP, AND FLANGE.




EXISTING		PROPOSED	
— stm —	STEAM LINE	— SD —	STORM DRAIN LINE
— ud —	STORM DRAIN LINE	— W —	WATER LINE
— w —	WATER LINE	— P —	POWER LINE
— g —	POWER LINE	— G —	GAS LINE
— t —	GAS LINE	— E —	COMMUNICATION LINE
— 135 —	CONTOUR	— 132.6 —	ELEVATION SPOT GRADE
136.24	ELEVATION SPOT GRADE	5%	DIRECTION & SLOPE OF PITCH
— TW 137.15 —	TOP OF WALL ELEVATION	— TW 137.15 —	BOLLARD LIGHT FIXTURE
— [Symbol] —	BOLLARD LIGHT FIXTURE	— [Symbol] —	BRICK WALL
— [Symbol] —	BRICK WALL	— [Symbol] —	BRICK OR UNIT PAVER
— [Symbol] —	BRICK OR UNIT PAVER	— [Symbol] —	STONE DRIP EDGE
— [Symbol] —	STONE DRIP EDGE		

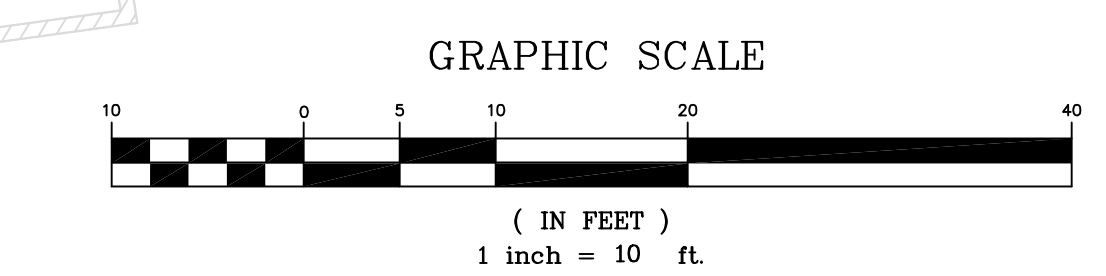

THIS PLAN SHALL NOT BE MODIFIED WITHOUT WRITTEN PERMISSION FROM SITE DESIGN ASSOCIATES, ANY ALTERATIONS, OTHERWISE, SHALL BE AT THE USER'S SOLE RISK AND WITHOUT LIABILITY TO SITE DESIGN ASSOCIATES.

REV.	DATE	STATUS	BY	CHKD.	APPD.	REV.	DATE	STATUS	BY	CHKD.	APPD.
C	03/20/15	STRUCTURAL EARLY RELEASE BID DRAWINGS									
B	3/10/15	ISSUED FOR HP REVIEW	DEPT.	TWS	TWS						
A	2/27/15	ISSUED FOR DESIGN DEVELOPMENT	DEPT.	TWS	TWS						

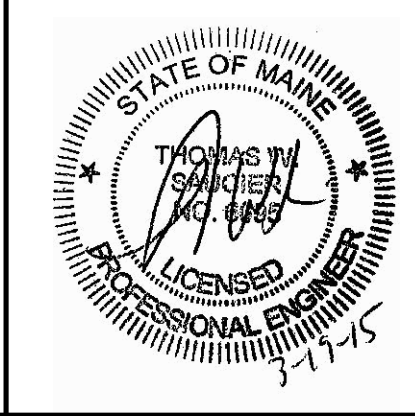

Site Design Associates
 Consulting Engineering & Land Planning
 23 Whitney Way Topsham, Maine 04086 Tel: (207) 449-4275
 CLIENT: **PORT CITY ARCHITECTURE**
 65 NEWBURY STREET, PORTLAND, MAINE 04101

DESIGN: TWS	PROJECT: ALUMNI HALL RENOVATION
DRAWN: DEPT.	UNIVERSITY OF NEW ENGLAND, PORTLAND, MAINE
CHKD: TWS	SITE PLAN
DATE: JAN 2015	PROJ. NO. _____
SCALE: 1"=10'	DWG. NO. _____
	REV. C

Drawing Name: P:\2014 Proj\2014-2015-2016 Alum Hall Renovation.dwg Date: 03/18/15 11:14 AM