

BY CHKD APPD. REV. DATE

STATUS

- LANDSCAFE CONTRACTOR IS DECURAGED TO PROVIDE THE LANDSCAPE ARCHITECT WITH CONCERNS AND/OR SUSSESTIONS WITH RESARDS TO PROPOSED PLANT MATERIAL SELECTION PRIOR TO PLACING A PRECINGE ORDER.
- 2. THE LANDSCAPE CONTRACTOR SHALL SUPPLY ALL PLANT MATERIALS IN QUANTITIES SUPPLIED TO COMPLETE ALL PLANTINGS SHOPN ON THIS DRAWING, CLARIFY ANY DISCREPANCES PITH THE LANDSCAPE ARCHITECT PRIOR TO PRICING ANY PLANT MATERIAL.
- 9. ALL PLANT MATERIALS SHALL CONFORM TO THE GUIDELINES ESTABLISHED BY THE LATEST EDITION OF THE AMERICAN ASSOCIATION OF NURSERVINENS "AMERICAN STANDARD OF NURSERY STOCK"
- 4. ALL PLANT NATERIALS ARE SUBJECT TO THE APPROVAL OF THE OWNER'S REPRESENTATIVE AT THE SITE, PLANTS INNO MATERIALS ARE REJECTED SHALL BE REMOVED FROM THE SITE IMPEDIATELY AND REPLACED AT NO ADDITIONAL COST TO THE OWNER.
- 5. ALL TREES AND SHRUBS TO BE BALLED IN BURLAP OR CONTAINERIZED
- MULCH FOR PLANTED AREAS TO BE AGED SPRICE AND FIR BARK, PARTIALLY DECOMPOSED, DARK BROWN IN COLOR AND FREE OF MOOD CHIPS THICKER THAN 1/4 THICK
- 1. CONTRACTOR SHALL MAINTAIN POSITIVE DRAINAGE AWAY FROM ALL BUILDING FOUNDATIONS, STRUCTURES AND PLANTING BEDS
- NO PLANTS SHALL BE PLANTED BEFORE ACCEPTANCE OF ROUSH GRADING AND DEFORE CONSTRUCTION HAS BEEN CONFLETED IN THE IMPEDIATE ANDA.
- ALL SHOUG GROUPINGS SHALL BE INCORPORATED INTO BEDS, WHERE MILCHED PLANT BED ABUTS LAWN CONTRACTOR SHALL PROVIDE A TURF CUT EDGE.
- IO. ALL TREES ALONS WALK AND PARKING AREAS SHALL BEGIN BRANCHING AT 5' HT. MIN.
- II. ALL PLANT MATERIAL OR REPRESENTATIVE SAMPLES SHALL BE LEGIBLY TAGGED WITH PROPER COMPON AND BOTANICAL NAMES, TAGG SHALL REMAIN ON THE PLANTS UNTIL PINAL ACCEPTANCE.
- 12. CORRECTOR SHALL LOAN DISTURBED AREAS CALLED OUT AS LANK WITH AN 6 INCH MINIM DEPTH OF TOPSOIL. SEED MIXTURES FOR LANK AREAS SHALL BE SEEDED WITH SEED TYPE & BY MEIGHT CREEPING RED FESCUE (HIN. 2 VARIETIES) 30% KENTUCKY BLEGRASS (MIN. 2 VARIETIES) 90% PERSONAL RYE GRASS UM SEEDING RATE FER 1000 SQLFT. 9 LBS. MIN.
- 19. CONTRACTOR SHALL INSTALL LOAM TO A DEPTH OF IS INCHES IN THE LANDSCAPE AREA SURROUNDING THE UTILITY ENCLOSURE.
- CONTRACTOR SHALL BESIN MANIBUNGS IMMEDIATELY AFTER PLANTING AND HILL CONTINE UNTIL FINAL ACCEPTANCE. CONTRACTOR SHALL BE RESPONSIBLE FOR ALL HEAVIS AND METHODS OF MATERING AND MANIBUNGS.
- B. THE LANDSCAPE CONTRACTOR SHALL SUARANTEE ALL PLANT MATERIALS FOR ONE (1) FULL YEAR PROMIDATE OF FINAL ACCEPTANCE.
- 16. BENCHES (6) ARE NOT PART OF THIS CONTRACT THEY WILL BE RURCHASED AND NISTALLED BY THE OWNER, BENCHES TO BE FLAT BENCH WITH NO BACK.
- IT. BICYCLE RACK TO BE PIRCHASED, ASSEMBLED AND INSTALLED BY THE CONTRACTOR. BICYCLE RACK TO BE THE 95 CAMPUS BICYLE RACK, WITH HOT DIFFED SALVANIZED FRIEN AND IN-SROUND MOUNTING (BID POSTS BURRIED IN CONCRETE) AS MANUFACTURED BY DERO BIKE RACK COMPANY OR APPROVED EQUAL.
- 18. SXIS AAB PLANT BED IS TO HAVE A 2 FT. DEPTH OF PLANTING SOIL TO HELP SUPPORT TREE GROWTH.
- M. SEE DRAWINGS CHOO THRU CHOT, C-200 THRU C-202, C-300 THRU C-305 AND THE ARCHTECTURAL, STELCTURAL, AND MECHANICAL PLANS FOR ADDITIONAL INFORMATION.

PLANT LIST:

SYMBOL	BOTANICAL NAME	COMPON NAME	ary	SIZE	COMPENTS
DECIDUOL	is TREES				
66	GINKO BILOBA 'AUTUMN GOLD'	AUTUMN GOLD GINCO	5	3 CAL	SINGLE LEADER, BIT 9
6T	GLEDITSIA T. I. SUNBURST	SUMBURST HONEYLOCUST	Э	5" CAL.	SINGLE LEADER, BAD
ORNAMEN	TAL TREES		anaent un	VI-1/00-1002-1-1-1	
AAB	AMELANCHIER A. 'AUTUMN BRILLIANCE'	AITIMN BRILLANCE AMELANCHIER	0	B'-10' HT.	MULTISTEM, BILB
CV	CRATABBUS VIRIDIS WINTER KING"	MINTER KING HAMTHORN	2	2 GAL	SINGLE LEADER, BUB
SHRUBS, &	ROUNDCOVERS & HERBACEOUS MATERIALS				
ВТ	BERBERIS T. A. "CRIMSON PYGMY"	CRIMBON PYGMY BARBERRY	10	IB" HT,	FULL # BUSHY
JCS.	JINIPEROIS CHINENSIS SARGENTI	SARGENT JAIPER	5 .	16	FULL & BUSHY
40	SYRINGA PATULA 'MISS KIM'	MISS KIM LILAG	9	5' HT	FULL # BUSHY
RB	RHODODENDRON BOULE DE NEIGE	BOLLE DE NEIGE RHODODENDRON	15	30° HT.	FULL # BUSHY
70	THULA OCCIDENTALIS "HOLMSTRUP"	HOLMSTRUP ARBORVITAE	15	4'-5' HT.	FULL II BUSHY
VM	VINCA MINOR	VINCA	100 S.F.	I YR PLANTS	PLANT 6" O.C. STAGGARED SPACING
			0		
				370	
		32 24 2			
		100			

- N	LEGEND	
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	STORM DRAIN MANHOLE STORM DRAIN CATCH BASIN STORM DRAIN LINE	
© 0+0 Ga	SANITARY SEWER MANHOLE SANITARY SEWER LINE ELECTRIC LINE ELECTRIC MANHOLE LIGHT POLE FIXTURE TELEPHONE LINE TELEPHONE MANHOLE	
(3)	TREE	₩ ⊙





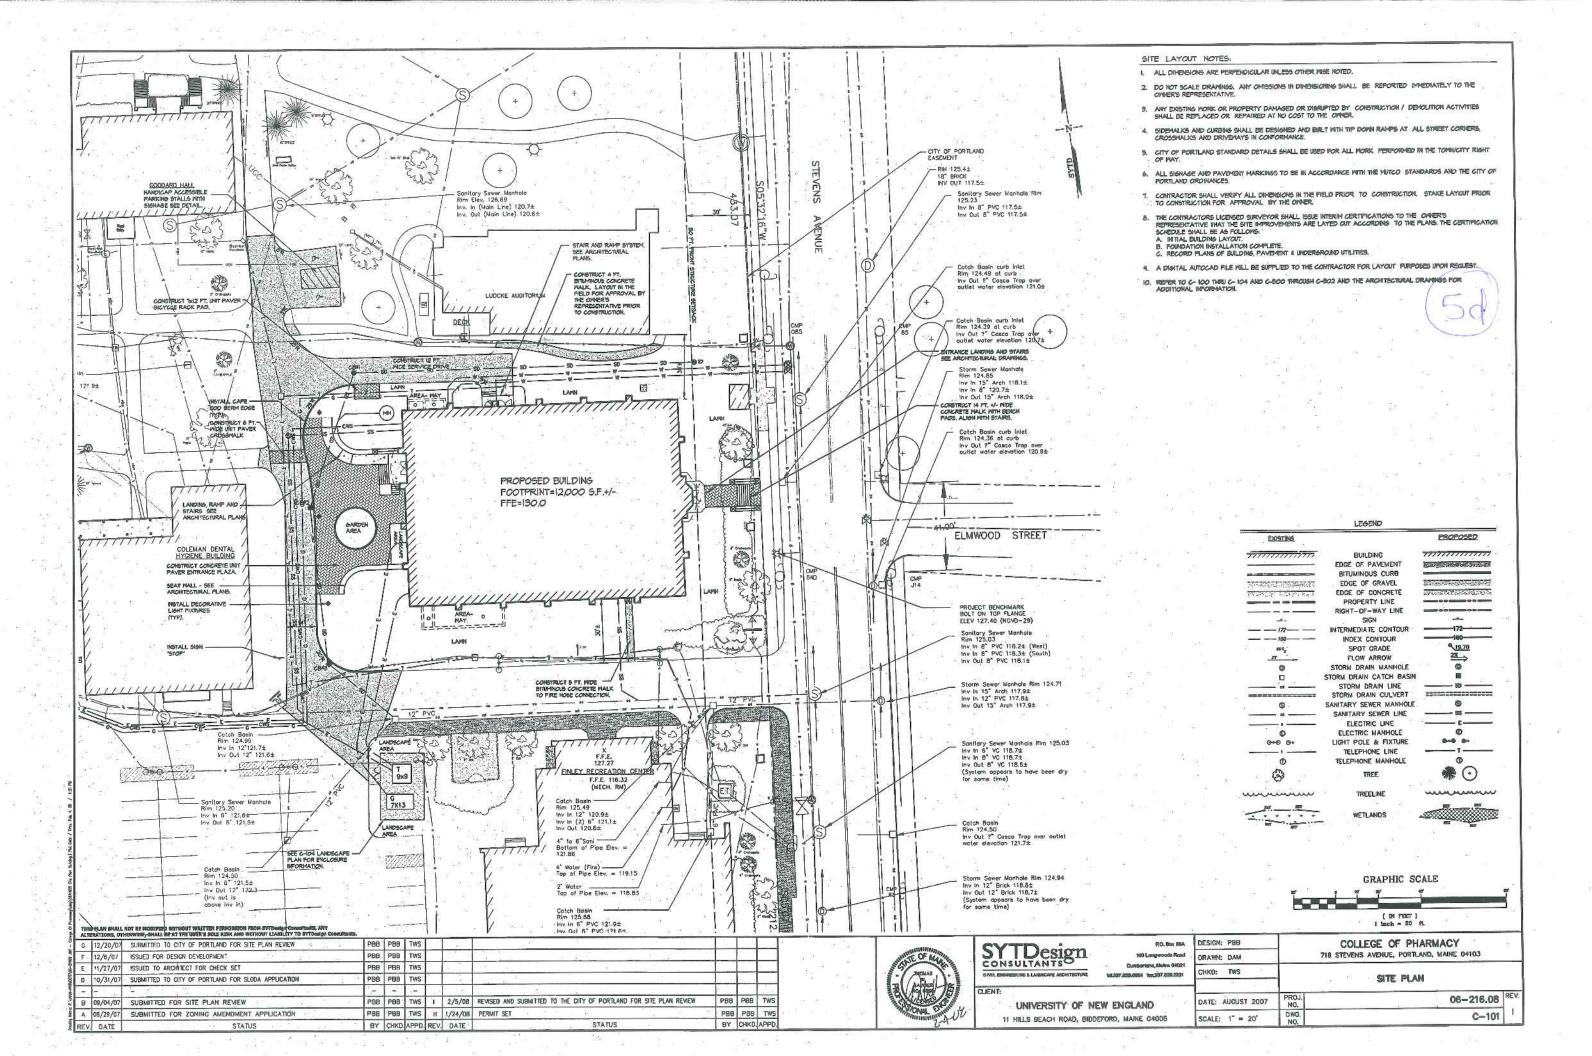
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. 80. Box 884	DESIGN:	PBB
100 Langwoods Road	DRAWN:	DAM
Oursboriend, Meline 04021 tol.207.028.0884 tor.207.029.2291	CHKD:	TWS

DESIGN:	P88	COLLEGE OF PHARMACY
DRAWN:	DAM	716 STEVENS AVENUE, PORTLAND, MAINE 04103
CHKD:	TWS	LANDONAPIO BIAM

LANDSCAPE PLAN

06-216.08 DATE: AUGUST 2007 UNIVERSITY OF NEW ENGLAND C-104 11 HILLS BEACH ROAD, BIDDEFORD, MAINE 04005 SCALE: 1" = 20"



144-A-5

7-16 Stevens
AVE

College of
Pharmacy
UNE

EROSION AND SEDIMENTATION CONTROL NOTES & DETAILS

TEMPORARY EROSION AND SEDIMENTATION CONTROL MEASURES INCLUDE THE USE OF SEDIMENT BARRIER, EROSION CONTROL MIX, STONE CHECK DAMS, HAY BALE BARRIERS, CATCH BASIN INLET BARRIERS, CATCH BASIN INLET BARRIERS, CATCH BASIN INLET SHORT SHORT

A. GENERAL

- 1. IT IS ANTICIPATED THAT CONSTRUCTION WILL BEGIN AS SOON AS POSSIBLE FOLLOWING RECEIPT OF NECESSARY PERMITS.
- 2. THE PROJECT SHALL CONFORM TO THE STANDARDS OF THE MAINE CONSTRUCTION GENERAL PERMIT.
- 3. ALL SOIL EROSION AND SEDIMENT CONTROL MEASURES SHALL BE CONSTRUCTED AND MAINTAINED IN ACCORDANCE WITH THE MANNE EROSION AND SEDIMENT CONTROL HANDBOOK FOR CONSTRUCTION:
 BEST MANAGEMENT PRACTICES PUBLISHED BY THE CUMBERLAND COUNTY SOIL AND WATER
 CONSERVATION DISTRICT AND THE DEPARTMENT OF ENVIRONMENTAL PROTECTION, MAY 2003, OR
 AS CURRENTLY REVISED.
- ANY ADDITIONAL FROSION AND SEDIMENTATION CONTROL DEEMED NECESSARY BY THE OWNER'S REPRESENTATIVE, DEPARTMENT OF ENVIRONMENTAL PROTECTION (DEP) PERSONNEL AND/OR MUNICIPAL OFFICIALS SHALL BE INSTALLED BY THE CONTRACTOR.
- 6 THE CONTRACTOR SHALL BE RESPONSIBLE FOR THE REPAIR (REPLACEMENT MAINTENANCE OF ALL THE CONTRACTION SHALL BE RESPONSIBLE FOR THE REPAIR PREVIOUS THE ADDRESS OF SALE BROSION CONTROL MEASURES UNIT, ALL DISTURBED AREAS ARE STABILIZED TO THE SAFFACTION OF THE ABOVE PERSONNEL DESCRIPTIONS OF ACCEPTABLE PERMANENT STABILIZATION FOR VARIOUS COVER TYPES FOLLOWS:
- A. FOR SEEDED AREAS, PERMANENT STABILIZATION MEANS THAT 90% OF DISTURBED ARE REVEGETATED WITH MATURE, HEALTHY PLANTS WITH NO EVIDENCE OF WASHING OR RILLING OF THE TOPSOIL.
- FOR MULCHED AREAS, PERMANENT MULCHING MEANS TOTAL COVERAGE OF THE EXPOSED AREA WITH AN APPROVED MULCH MATERIAL EROSION CONTROL MIX MAY BE USED AS MULCH FOR PERMANENT STABILIZATION ACCORDING TO THE APPROVED APPLICATION RATES
- FOR AREAS STABILIZED WITH RIP RAP, PERMANENT STABILIZATION MEANS THAT SLOPES STABILIZED WITH RIPRAP HAVE AN APPROPRIATE BACKING OF A WELL-GRADED GRAVEL OR ED GEOTEXTILE TO PREVENT SOIL MOVEMENT FROM BEHIND THE RIPRAP. STONE MUST BE SIZED APPROPRIATELY.
- FOR PAVED AREAS, PERMANENT STABILIZATION MEANS THE PLACEMENT OF THE COMPACTED GRAVEL SUBBASE IS COMPLETED.
- FOR OPEN CHANNELS, PERMANENT STABILIZATION MEANS THE CHANNEL IS STABILIZED WITH MATURE VECETATION AT LEAST THREE INCHES IN HEIGHT, PROTECTED WITH WELL-GRADED RIPPRAP, OR WITH ANOTHER NON-EROSIVE UNING CAPABLE OF WITHSTANDING THE ANTICIPATED FLOW VELOCITIES AND FLOW DEPTHS WITHOUT RELIANCE ON CHECK DAWS TO SLOW FLOW, THERE MUST BE NO EVIDENCE OF SLUMPING OF THE LINING, UNDERCUTTING OF THE GHANNEL.

B. EROSION AND SEDIMENTATION CONTROL MEASURES

- 1. PRIOR TO THE REGINNING OF CONSTRUCTION, TEMPORARY SILT FENCE SHALL BE INSTALLED AS: SHOWN ON THE PLANS OR AS DIRECTED BY THE OWNER'S REPRESENTATIVE. IT IS THE INTENT
 THAT SEDIMENT BARRIERS BE INSTALLED DOWN GRADIENT OF ALL DISTURBED AREAS OF THE SECONDATION BARRIERS SHALL BE INSPECTED INMEDIATELY FOR EACH RAINFALL AND AT THE ST SEDIMENT BARRIERS SHALL BE INSPECTED IMMEDIATELY AFTER EACH RAINFALL AND AT LEAST DALLY DURING PROLONGED RAINFALL ANY REQUIRED REPAIRS WILL BE MADE IMMEDIATELY, SEDIMENT DEPOSITS SHALL BE PERIODICALLY REMOVED FROM THE UPSTREAM SIDE OF THE STEE MOT SUBJECT TO EROSION, SEDIMENT BARRIERS, THIS SEDIMENT WALL BE STREAD AND STEADLED IN AREAS OF THE SITE MOT SUBJECT TO EROSION, SEDIMENT BARRIERS SHALL BE REPLACED AS NECESSARY TO PROVIDE PROVIDE PROPER FILEMEND ACTION, IF THERE ARE SIGNS OF JUDICATURING AT THE CENTER OR THE EDGES, OR IMPOUNDING OF LARGE VOLUMES OF WATER BEHIND THEM, THEY SHALL BE REPLACED WITH A TEMPORARY COURSED STONC DEECE OF MAIR BEHIND THEM, THEY SHALL BE REPLACED.
- ALL CATCH BASINS, NEW OR EXISTING, THAT MAY RECEIVE RUNOFF FROM DISTURBED AREAS MUST BE PROTECTED DURING CONSTRUCTION. INSPECT & CLEAN DUT AS NECESSARY, LEAGALLY DISPOSE OF SEDIMENT & REMOVE FLOATABLES WITH DIL ABSORBANT PAD AS APPLICABLE.
- REMOVAL OF SOD, TREES, BUSHES AND OTHER VEGETATION AND SOIL DISTURBANCE WILL BE KEPT TO A MINIMUM WHILE ALLOWING PROPER SITE DEVELOPMENT.
- GRUBBINGS AND ANY UNUSABLE TOPSOIL SHALL BE STRIPPED AND REMOVED FROM THE PROJECT SITE AND DISPOSED OF IN AN APPROVED MANNER.
- ANY SUITABLE TOPSOIL WILL BE STRIPPED AND STOCKPILED FOR REUSE IN FINAL GRADING. TOPSOIL WILL BE STOCKPILED IN A MANNER SUCH THAT NATURAL DRAINAGE IS NOT OBSTRUCTED AND NO OFF-SITE SEDIMENT DAMAGE WILL RESULT. IF A STOCKPILE IS NECESSARY, THE SIDE SLOPES OF THE TOPSOIL STOCKPILE WILL NOT EXCEED 2:1. TOPSOIL STOCKPILES WILL BE SLOPES OF THE IDPOSALL STOCKTEE MILL NOT ACCEPT.

 TEMPORARILY SEEDED WITH AROCSTOOK RYE, ANNUAL OR PERSONAL RYE GRASS (DEPENDING ON DATE SEEDED) WITHIN 7 DAYS OF FORMATION, OR TEMPORARILY MULCHED IF SEEDING CANNOT BE DONE WITHIN THE RECOMMENDED SEEDING DATES.
- 6. TEMPORARY DIVERSION BERMS AND DRAINAGE SWALES SHALL BE CONSTRUCTED AS NECESSARY
- 7. TEMPORARY STABILIZATION SHALL BE CONDUCTED WITHIN 7 DAYS OF INITIAL DISTURBANCE OF SOILS, PRIOR TO ANY RAIN EVENT, AND PRIOR TO ANY WORK SHUT DOWN LASTING MORE THAN ONE WEEK, TEMPORARY STABILIZATION INCLUSES MULCH, OR OTHER NON-ERODABLE COVER, AREAS WITHIN 75 FEET OF WETLANDS SHALL BE TEMPORARILY STABILIZED WITHIN 48 HOURS OR PRIOR TO ANALYSIS
- B. APPLY HAY OR STRAW MULCH AT A RATE OF 2 TONS PER ACRE, AND ANCHOR AS NECESSARY.
- 9. TEMPORARY SEEDING SPECIFICATIONS. WHERE THE SEEDBED HAS BEEN COMPACTED BY CONSTRUCTION OPERATIONS, LOOSEN SOIL TO A DEPTH OF 4 INCHES BEFORE APPLYING FERTILIZER, LIME, AND SEED. APPLY LIMESTONE AT A RATE OF 3 TONS PER ACRE (138 LB. PER 1,000 SOUARE FEET) AND 10-10-10 FERTILIZER AT A RATE OF 600 LBS. PER ACRE (13.8 LB. PER 1,000 SQUARE FEET). UNIFORMLY APPLY SEED AT THE RECOMMENDED SEEDING RATES AND DATES, APPLY HAY OR STRAW MULCH AT A RATE OF 2 TONS PER ACRE, AND ANCHOR AS NECESSARY.
- RECOMMENDED TEMPORARY SEEDING DATES AND APPLICATION RATES ARE AS FOLLOWS:
- AROOSTOOK RYE: RECOMMENDED SEEDING DATES: 8/15 10/1 APPLICATION RATE: 112 LBS./ACRE
- ANNUAL RYE GRASS: RECOMMENDED SEEDING DATES: 4/1 7/1
 APPLICATION RATE: 40 LBS./ACRE

G 12/20/07 SUBMITTED TO THE CITY OF PORTLAND FOR SITE PLAN REVIEW

F 12/06/07 ISSUED FOR DESIGN DEVELOPMENT

C 10/19/07 ISSUED FOR SCHEMATIC DESIGN

REV. DATE

F 11/27/07 ISSUED TO ARCHITECT FOR CHECK SET

A 09/04/07 SUBMITTED FOR SITE PLAN REVIEW

10. IF THE AREA WILL REMAIN UNWORKED FOR MORE THAN ONE YEAR OR HAS BEEN BROUGHT TO FINAL GRADE, AND WILL NOT BE BUILT ON, THEN IMMEDIATELY PROVIDE PERMANENT STABILIZATION USING VEGETATION THROUGH PLANTING, SEEDING, SOO, OR THROUGH THE USE OF PERMANENT MULCH OR RIPRAP, IF USING VEGETATION FOR STABILIZATION, SELECT THE

NOT BE MODIFIED WITHOUT WILLTEN PERHIDOLUM FROM STORMS.
MERWISE, SHALL BE AT THE USER'S SOLE RISK AND WITHOUT LIABILITY TO SYTDO

B 10/12/07 REVISED AND SUBMITTED TO THE CITY OF PORTLAND FOR SITE PLAN REVIEW

STATUS

- PROPER VEGETATION FOR THE LIGHT, MOISTURE, AND SOIL CONDITIONS. AMEND AREAS OF DISTURBED SUBSOIL WITH TOP SOIL OR OTHER ORGANIC AMENDMENTS, PROTECT SEEDED AREAS WITH MULCH OR, IF NECESSARY VEROSION CONTROL BLANKETS, AND SCHEDULE SODDING, PLANTING, AND SEEDING SO TO AVOID DIE—OFF FROM SUMMER DROUGHT AND FALL FROSTS. NEWLY SEEDED OR SODDED AREAS MUST BE PROTECTED FROM VEHICLE TRAFFIC, EXCESSIVE PEDESTRIAN TRAFFIC, AND CONCENTRATED RUNOFF UNTIL THE VEGETATION IS WELL ESTABLISHED. AREAS MUST BE REWORKED AND RESTABLISHED. FOR GRAINATION IS SPARSE, PLANT COVERAGE IS SPOTTY, OR TOPSOIL EROSION IS EVIDENT.
- 11. PERMANENT SEEDING SPECIFICATION, IF A LANDSCAPE PLAN HAS BEEN PREPARED FOR THE PROJECT, SOIL PREPARATION AND SEEDING OF THAT PLAN SHALL SUPERSEDE THESE CHERAL PERMANENT SEEDING SPECIFICATIONS, IT IS RECOMMENDED THAT PERMANENT SEEDING GREDING THE COMPLETED BETWEEN APRIL 1 AND AUGUST 15 OF EACH YEAR. LATE SEASON SEEDING MAY BE DONE BETWEEN AUGUST 15 AND SEPTEMBER 15, AREAS NOT SEEDIO OR WHICH DO NOT OBTAIN A SATISFACTORY GROWTH BY OCTOBER 1 SHALL BE SEEDED WITH AROOSTOOK RYE OR MULCHED AT RATES PREVIOUSLY SPECIFIED. SEE WINTER CONDITIONS NOTES FOR SEEDING
 - A. APPLY TOPSOIL TO A MINIMUM DEPTH OF 6 INCHES. MIX TOPSOIL WITH THE SUBSOIL TO A MINIMUM DEPTH OF 6 INCHES.
 - B. APPLY LIMESTONE AND FERTILIZER ACCORDING TO SOIL TESTS. IN LIEU OF SOIL TESTS, APPLY GROUND LIMESTONE AT A RATE OF 3 TONS PER ACRE (138 LB. PER 1,000 SQUARE FEET) AND GRANULAR, COMMERCAL-GRADE, 10-10-10 FERTILIZER AT A RATE OF 800 LBS. PER ACRE (18.4 LBS. PER 1,000 SQUARE FEET).
- C. UNIFORMLY APPLY SEED MIXTURE AT THE RECOMMENDED SEEDING RATES AND DATES, APPLY HAY OR STRAW MULCH AT A RATE OF 2 TONS PER ACRE, AND ANCHOR AS NECESSARY.
- D. THE SEED MIXTURE FOR LAWN AREAS SHALL BE AS SHOWN ON THE LANDSCAPE PLAN.
- E. THE SEED MIXTURE FOR WET AREAS SHALL CONSIST OF SEEDS PROPORTIONED BY WEIGHT
 - 50 % REED CANARY GRASS 25 % RED TOP 15 % CREEPING RED FECUE 10 % PERENNIAL RYE GRASS
- 12. MULCH ALL AREAS SEEDED SO THAT SOIL IS NOT VISIBLE THROUGH THE MULCH REGARDLESS OF THE APPLICATION RATE.
- DITCH LININGS, STONE CHECK DAMS, AND RIP RAP INLET AND OUTLET PROTECTION SHALL BE INSTALLED WITHIN 48 HOURS OF COMPLETING THE GRADING OF THAT SECTION OF DITCH OR INSTALLATION OF CULVERT.
- 14. RIP RAP REQUIRED AT CULVERTS AND STORM DRAIN INLETS AND DUTLETS SHALL CONSIST OF FIELD STONE OR ROUGH UNHEWN QUARRY STONE OF APPROXIMATELY RECTANGULAR SHAPE. STONES SHALL WEIGH FROM 10 LBS. TO 200 LBS. AND 50% OF THE STONES BY VOLUME SHALL EXCEED A UNIT WEIGHT OF APPROXIMATELY 50 LBS.
- 15. EROSION CONTROL BLANKET SHALL BE INSTALLED ON ALL PERMANENT SLOPES STEEPER THAN 3:1, IN THE BASE OF DITCHES NOT OTHERWISE PROTECTED, AND ANY DISTURBED AREAS WITHIN 100 FEET OF A PROTECTED NATURAL RESOURCE (E.G. WELLANDS AND WATER BOOLSE). EROSION CONTROL BLANKET SHALL BE INSTALLED IN ACCORDANCE WITH MANUFACTURER'S RECOMMENDATIONS.
- TEMPORARY CONTROL MEASURES, SUCH AS SILT FENCE, SHALL BE REMOVED WITHIN 30 DAYS
 AFTER PERMANENT STABILIZATION IS ATTAINED.

- "WINTER CONSTRUCTION" IS CONSTRUCTION ACTIVITY PERFORMED DURING THE PERIOD FROM NOVUMBER 1 THROUGH APRIL 15. IF AREAS WITHIN THE CONSTRUCTION ACTIVITY ARE NOT STABILIZED WITH TEMPORARY OR PERMANENT MEASURES OUTLINED ABOVE BY NOVEMBER 15, THEN THE SITE MUST BE PROTECTED WITH ADDITIONAL STABILIZATION MEASURES THAT ARE SPECIFIC TO WINTER CONDITIONS. NO MORE THAN ONE ACRE OF THE SITE MAY BE WITHOUT STABILIZATION AT ONE TIME.
- AREAS WITHIN 100 FEET OF A PROTECTED NATURAL RESOURCE MUST BE PROTECTED WITH A DOUBLE ROW OF SEDIMENT BARRIERS.
- HAY MULCH SHALL BE APPLIED AT TWICE THE STANDARD TEMPORARY STABILIZATION RATE. AT THE END OF EACH CONSTRUCTION DAY, AREAS THAT HAVE BEEN BROUGHT TO FINAL GRADE MUST BE STABILIZED. MULCH MAY NOT BE SPREAD ON TOP OF SNOW.
- 4. AFTER NOVEMBER 1 OR THE FIRST KILLING FROST FOR THE REGION AND BEFORE SNOW FALL, ALL EXPOSED AND DISTURBED AREAS NOT TO UNDEFREO FURTHER DISTURBANCE ARE TO HAVE DORMANT SEEDING. THE DORMANT SEEDING METHOD: REPORAT THE SEEDED, LIME AND FERTILIZE, APPLY THE SELECTED PERMANENT SEED MIXTURE AT DOUBLE THE REGULAR SEEDING RATE, AND MULCH AND ANOHOR. DORMANT SEEDINGS NEED TO BE ANCHORDE EXTREMELY WELL ON SLOPES, DITCH BASES AND AREAS OF CONCENTRATED FLOWS. DORMANT SEEDING REQUIRES INSPECTION AND RESEDEND AS NEEDED IN THE SPRING, ALL AREAS WHERE COVER IS INADEQUATE MUST BE IMMEDIATELY RESEDED AND MULCHED AS SOON AS POSSIBLE.
- 5. ALL VEGETATED DITCH LINES THAT HAVE NOT BEEN STABILIZED BY NOVEMBER 1, OR WILL BE WORKED DURING THE WINTER CONSTRUCTION PERIOD, MUST BE STABILIZED WITH AN APPROPRIATE STONE LINING BACKED BY AN APPROPRIATE GRAVEL BED OR GEOTECHILE UNLESS SPECIFICALLY RELEASED FROM THIS STANDARD BY THE MAINE DEPARTMENT OF ENVIRONMENTAL DEPARTMENT.
- MULCH NETTING MUST BE USED TO ANCHOR MULCH ON ALL SLOPES GREATER THAN 8% UNLESS EROSION CONTROL BLANKETS OR EROSION CONTROL MIX IS BEING USED ON THESE SLOPES.

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BY CHKD APPD REV. DATE

- SPILL PREVENTION.CONTROLS MUST BE USED TO PREVENT POLLUTANTS FROM BEING DISCHARGED FROM MATERIALS ON STE, INCLUDING STORAGE PRACTICES TO MINIMIZE EXPOSURE OF THE MATERIALS TO STORMWATER, AND APPROPRIATE SPILL PREVENTION, CONTAINMENT, AND RESPONSE PLANNING AND IMPLEMENTATION.
- 2. GROUNDWATER PROTECTION, DURING CONSTRUCTION, LIQUID PETROLEUM PRODUCTS AND OTHER HAZARDOUS MATERIALS WITH THE POTENTIAL TO CONTAMINATE ROUNDWATER MAY NOT BE STORED OR HANDLED IN AREAS OF THE SITE DRAINING TO AN INFILTRATION AREA. IN MY AREA OF THE SITE THAT BY DESIGN OR AS A RESULT OF SOILS, TOPOGRAPHY AND OTHER RELEVANT FACTORS, ACCUMULATE MURDET THAT INFILTRATES THE SOIL DIKES, BETHIS, SUMPS, AND OTHER FORMS OF SECONDARY CONTANNENT THAT PREVENT DIGHARGE. TO GROUNDWATER MAY BE USED TO ISOLATE PORTIONS OF THE SITE FOR THE PURPOSES OF STORAGE AND HANDLING OF THESE MATERIALS.
- 3. FUGITIVE SEDIMENT AND DUST. ACTIONS MUST BE TAKEN TO ENSURE THAT ACTIVITIES DO NOT RESULT IN NOTICEABLE EROSIGN OF SOLES OR FUGITIVE DUST EMISSIONS DURING OR AFTER CONSTRUCTION, OIL MAY NOT BE USED FOR DUST CONTROLLO
- 4. DEBRIS AND OTHER MATERIAL LITTER, CONSTRUCTION DEBRIS, AND CONSTRUCTION CHEMICALS EXPOSED TO STORM WATER, MUST BE PREVENTED FROM BECOMING A POLLUTANT SOURCE.
- 5. TRENCH OR FOUNDATION DE-WATERING, TRENCH DE-WATERING IS THE REMOVAL OF WATER FROM TRENCHES, FOUNDATIONS, COFFER DAMS, PONDS AND OTHER AREAS WITHIN THE CONSTRUCTION AREA THAT RETAIN WATER AFTER EXCAVATION. IN MOST CASES THE COLLECTED WATER IS HEAVILY SLIED AND HINDERS CORRECT AND SAFE CONSTRUCTION PRACTICES. THE COLLECTED WATER REMOVED FROM THE PONDED AREA,

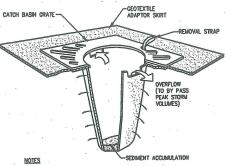
PBB PBB TWS 1 2/5/08 REVISED AND RESUBMITTED FOR PLANNING BOARD FINAL APPROVAL

STATUS

EITHER THROUGH GRAVITY OR PUMPING, MUST BE SPREAD THROUGH NATURAL WOODED BUFFERS OR RENOTE AREAS THAT ARE SPECIFICALLY DESIGNATED TO COLLECT THE MAXBUUM AMOUNT OF SEDIMENT POSSIBLE, LIKE A COFFER DAM SEDIMENTATION BASIN. AVOID ALLOWING THE WATER TO FLOW OVER DISTURBED AREAS OF THE SITE.

- INSPECT DISTURBED AND IMPERVIOUS AREAS, EROSION AND STORM WATER CONTROL
 MEASURES, AREAS USED FOR STORAGE THAT ARE EXPOSED TO PRECIPITATION, AND LOCATIONS MEASURES, AREAS USED FOR STORAGE THAT ARE EXPOSED TO PRECIPITATION, AND LOCATIONS WHERE VEHICLES ENTER OR EATT THE SITE AT ILEAST ONCE A WEEK AS WELL AS BEFORE AND AFTER STORM EVENTS, PRIOR TO COMPLETION OF PERMANENT STABILIZATION. A PERSON WITH KNOWLEDGE OF EPOSION AND STORM WATER CONTROLS, INCLUDING THE STANDARDS IN THE MAINE CONSTRUCTION GENERAL PERMIT AND ANY DEP OR MUNICIPAL, COMPANION DOCUMENTS, MUST CONQUET THE INSPECTION. THIS PERSON MUST BE DENTIFIED IN THE INSPECTION LOC. IF BEST MANAGEMENT PRACTICES BUMPS NEED TO BE MODIFIED OF ADDITIONAL BURPS ARE NECESSARY, IMPLEMENTATION MUST BE COMPLETED WITHIN 7 CALENDAR DAYS AND PRIOR TO ANY STORM EVENT (RAMPFALL). ALL MEASURES MUST BE MAINTAINED IN EFFECTIVE OPERATING CONDITION UNTIL AREAS ARE PERMANENTLY STABILIZED.
- 2. AN INSPECTION AND MAINTENANCE LOG MUST BE KEPT SUMMARIZING THE SCOPE OF THE INSPECTION, NAME AND QUALIFICATIONS OF THE PERSON PERFORMING THE INSPECTION, DATE, AND MAJOR GESEVATIONS RELATING TO OPERATION OF ENOSIGN AND SEDMENTATION CONTROLS AND POLLUTION PREVENTION MEASURES. MAJOR OSESTIVATIONS MUST INCLUDE: BMPB THAT NEED TO BE MAINTAINED, LOCATION(S) OF BMPB THAT FALLED TO OPERATE AS DESIGNED OR PROVIDED INADEQUATE FOR A PARTICULAR LOCATION, AND LOCATION(S) MERCE ADDITIONAL BMPS ARE NEEDED THAT DID NOT EXIST AT THE TIME OF THE INSPECTION. FOLLOW-UP TO CORRECT DEFIGIENCES OR ENHANCE CONTROLS MUST ALSO BE INDICATED IN THE LOG AND DATED; INCLUDING WHAT ACTION WAS TAKEN AND WHEN.





- CATCH BASIN PROTECTION TO BE "SILTSTACK" (BY ACF ENVIRONMENTAL) OR "STREAM GUARD" (BY FOSS ENVIRONMENTAL SERVICES).
- INSERT TO BE EMPTIED IN AN APPROVED MANNER WHEN IT IS 1/2 FULL OF 2. INSPECT INSERT AFTER ALL RAINFALL EVENTS, REPAIR AND MAINTAIN AS REQUIRED.
- CATCH BASIN INLET PROTECTION SCALE: NTS



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PBB PBB TWS

BY CHKD APPI

CLIEN1



P.O. Box 86A

DESIGN: JAV

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716 STEVENS AVENUE, PORTLAND, MAINE 04103 RAWN: JAV EROSION & SEDIMENTATION CONTROL HKD: ADJ


UNIVERSITY OF NEW ENGLAND 11 HILLS BEACH ROAD, BIDDEFORD, MAINE 04005


	DETAILS & SPECIFICATIONS	
PROJ. NO.	06-21608	REV.
DWG. NO.	C-300	-1
	NO. DWG.	PROJ. NO. 06-21608 DWG. C-300

COLLEGE OF PHARMACY



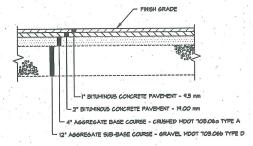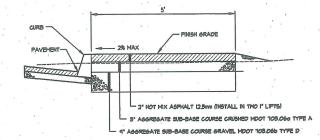- I. ADDITIONAL SUBBASE GRAVEL AND/OR GEOTEXTILES MAY BE REQUIRED DURING CONSTRUCTION IF SOIL CONDITIONS MARRANT
- BUILD-UP RECOMENDATION IS PRELIMINARY REFER TO GEOTECHNICAL REPORT.







PARKING AREAS AND DRIVE BUILD-UP SCALE: NTS



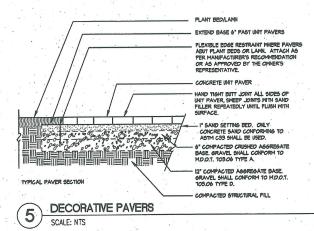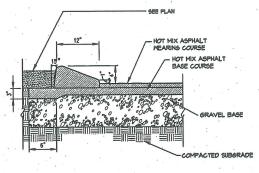
- I. ALL PAYERS SHALL BE SAM CUT ONLY. NO FRASHENT SHALL BE SHALLER THAN 2". FINAL SURFACE SHALL PITCH TO DRAIN PER GRADING PLAN.
- UNLESS CALLED OUT OTHERWISE ON THE DRAWINGS UNIT PAVERS SHALL BE THE TREVIA TUMBLED PAVER AS MANUFACTURED AND DISTRIBUTED BY GENEST CONCRETE OF SAMPORD, MANE (800) 644-4113. UNIT PAVERS SHALL BE THE ASH CHARCOAL COLOR.






CAPE COD ASPHALT BERM (6) SCALE: N.T.S

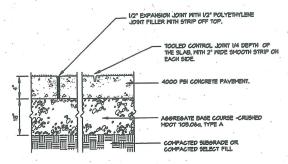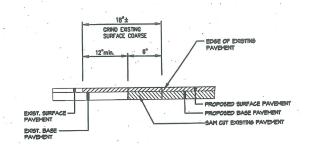
- I. PROVIDE FIBRILATED POLYPROPYLENE FIBER REINFORCING
- 2. PROVIDE A BROOM FINISH PERPENDICULAR TO TRAFFIC FLOW
- PHEN NOT SHOWN ON THE DRAWINGS PROVIDE TOOLED SCORE JOINTS EGUALLY SPACED ALONG MALK, AT INTERVALS APPROXIMATELY EQUAL TO THE SLAB MIDTH. PANELS SHOULD BE AS NEARLY SQUARE AS POSSIBLE.
- 4. PROVIDE FULL DEPTH JOINTS WHERE PAVEMENT ABUTS STRUCTURES AND VERTICAL SURFACES. SEAL ALL EXPANSION JOINTS WITH MATERPROOF SEALANT.








PAVEMENT BUTT JOINT SCALE: N.T.S.

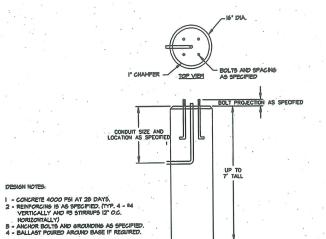

PRECAST CONCRETE LIGHT POLE BASE (16 INCH ROUND) SCALE: N.T.S.

FRONT VIEW

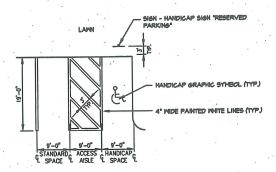- I. SYMBOLS AND PARKING STALLS SHALL CONFORM TO THE REGURDMENTS OF THE AMERICANS WITH DISABILITIES ACT. ALL PAINT SHALL BE FAST DRYING TRAFFIC PAINT WITH SILICA SAND
- FOR SKID RESISTANCE, MEETING THE REQUIREMENTS OF ASHTO M240-TYPE N. PAINT SHALL BE APPLIED AS SPECIFIED BY THE MANUFACTURER.



HANDICAP PARKING SPACE LAYOUT (2) 8 SCALE: N.T.S.

THIS DLAW SHALL NOT BE MODIFIED WITHO	UT WRITTEN PERNISSION FROM SYTDENIEN CONSUMEROS, ANY
ALTERATIONS OTHERWISE SHALL BE AT TH	IE USER'S SOLE RISK AND WITHOUT LIABILITY TO SYTDesign Consults

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06-216	Ε	11/27/07	ISSUED TO ARCHITECT FOR CHECK SET	PBB	PBB ·	TWS						\vdash	
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- H.C.	C	10/19/07	ISSUED FOR SCHEMATIC DESIGN	PBB	PBB	TWS	IJ	2/5/08	REVISED AND SUBMITTED TO THE CITY OF PORTLAND FOR SITE PLAN REVIEW	-	PBB	_	
P:\20	В	10/12/07	REVISED AND SUBMITTED TO THE CITY OF PORTLAND FOR SITE PLAN REVIEW	PBB	PBB	TWS	1	1/24/08	PERMIT SET	PBB	PBB	TWS	Ė
Name	A	09/04/07	SUBMITTED FOR SITE PLAN REVIEW	DAM	PBB	TWS	Н	1/15/08	REVISED PER CITY OF PORTLAND PEER REVIEW COMMENTS	PBB	PBB	TWS	
buan.	REV	DATE	STATUS	BY	CHKD.	APPD.	REV.	DATE	STATUS	BY	CHKD.	APPD.	




SYTDesign
GIVIL ENGINEERING & LANDSCAPE ARCHITECTU
CLIENT:

P.O. Box 86A	D
160 Longwoods Road	С
Cumberland, Maine 04021	
07.829.6004 fm.207.829.2231	C

COLLEGE OF PHARMACY DESIGN: JAV 716 STEVENS AVENUE, PORTLAND, MAINE 04103 DRAWN: JAV CHKD: ADJ

UNIVERSITY OF NEW ENGLAND 11 HILLS BEACH ROAD, BIDDEFORD, MAINE 04005

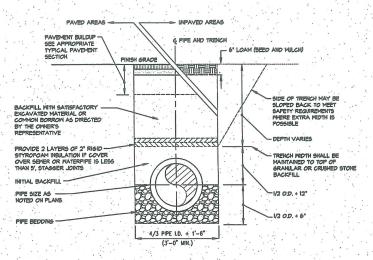SITE DETAILS 06-21608 PROJ. DATE: OCTOBER 2007 C-301 SCALE: N.T.S.



TRENCH BACKFILL SCHEDULE

PIPE MATERIAL	PIPE BEDDING	INITIAL BACKFILL	BACKFILL
HOPE	9/4" CRUSHED STONE	5/4" CRUSHED STONE	OF GRANLAR BORROW
PVC	3/4" CRUSHED STONE	3/4" CRUSHED STONE	OR GRANILAR BORROW
CMP	OR GRANLAR BORROW	OR GRANLAR BORROW	OF GRANLAR BORROW
DUCTILE IRON	GRANULAR MATERIAL	GRANULAR MATERIAL	OR GRANILAR BORROW

** EXCAVATED MATERIAL MUST BE REVIEWED AND APPROVED BY THE OWNER'S REPRESENTATIVE PRIOR TO INSTALLATION.

GRANULAR MATERIAL TO BE SAND OR GRAVEL.

TYPICAL PIPE TRENCH SECTION
SCALE: NTS

CATCH BASH FRAME AND

ORATED COVER

B

AD LIST TO GRADE PUBRICK
(I CRS. MIN, 3 CRS. MAX.)

CONCENTRIC COVE SECTION
SHOWN-ECCENTRIC COVE SECTION
SHOWN-ECCENTRIC COVE SECTION
SHOWN-ECCENTRIC COVE OR
SHAD MAY BE USED IF
APPROVED BY THE COVER'S
REFRESCHIATIVE

PRECAST BARREL
SECTION AS REGIRED

CASCO TRAP

IN STAINLESS STEEL BAND

TO TAIN TO THE SEE

OF THE STUD

CASCO TRAP

PRECAST BASE SECTION

IN STAINLESS STEEL BAND

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CONCENTRIC COVER SECTION

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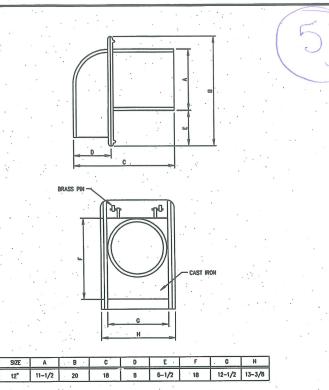
CONCENTRIC COVER SECTION

THE CONCENTRIC COVER SECTION


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TO THE STU

2 CATCH BASIN
SCALE: N.T.S.



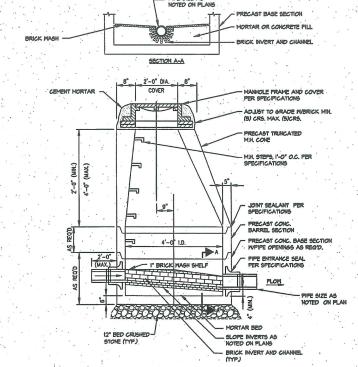3 CASCO TRAP
SCALE: N.T.S.



NOTES.

I. PROVIDE SHOP DRAWINGS OF ALL SIGNS TO THE OWNER PRIOR TO PURCHASING.

2. OWNER TO APPROVE ALL SIGN LOCATIONS IN THE FIELD PRIOR TO INSTALLATION.

				and the second second
	POST HEIGHT	STOP SIGN	RESERVED PARKING	
	Α	· 7'	4'-6"	
2	STOP	PRESSURE GRAPHICS COPY TO STATE OF	SIGN PANEL FLUSH TO SUPPORT POST. -SEPOSITIVE VITY LAND NEET APPLICASE MARE D.O.T. CODES REGUIREMENTS.	STOP 96'x 96'
A BOVE				
ASS SEE		BURY POS WELL CON LEDGE OF	ST IN MELL DRAINING MPACTED GRAVEL. IF SSTRUCTS DRILL AND SST MIN. 2" DEPTH.	12°X 18°
6 SIGNA	(GE			VAN ACCESSIBLE 12"X 6"
SCALE: I	N. 1. 3.	E	and the second	4.

24" INLINE DRAIN AND GRATE

INLINE DRAIN TO BE THE 2724AGIZN, 24" DIAMETER PVC AS MANUFACTURED BY ADS 1-800-821-6110 OR APPROVED EQUAL.

2. THE CONTRACTOR SHALL INSTALL THE INLINE DRAIN AS PER THE MANUFACTURERS RECOMMENDATIONS AND AS SHOWN IN THE

SCALE; NTS

5 TYPICAL SANITARY MANHOLE SCALE: N.T.S.

THES PLAN SMALL NOT BE MODIFIED WITHOUT WRITTEN PERMISSION FROM SYTDOSING CONSUMERS, ANY
ALTERATIONS, OTHERWISE, SHALL BE AT THE USER'S SOLE RISK AND WITHOUT LIABILITY TO SYTDOSION CONSUMER.

24" INLINE DRAIN

G·.	12/20/07	SUBMITTED TO THE CITY OF PORTLAND FOR SITE PLAN REVIEW	PBB	PBB	. TWS	14	1. 177			
F.	12/06/07	ISSUED FOR DESIGN DEVELOPMENT	WIE	PBB.	TWS		1 1 1			
Ė	11/27/07	ISSUED TO ARCHITECT FOR CHECK SET	PBB	PBB	TWS		1 1 .			
_	-, 1			4	÷ .		1 1			
Ċ	10/19/07	ISSUED FOR SCHEMATIC DESIGN,	PBB	PBB	TWS	·J·	2/5/08	REVISED AND SUBMITTED TO THE CITY OF PORTLAND FOR SITE PLAN REVIEW	PBB	PBB
В.	10/12/07	REVISED AND SUBMITTED TO THE CITY OF PORTLAND FOR SITE PLAN REVIEW	DEPT	PBB -	TWS	1	1/24/08	PERMIT SET	PBB	PBB:
A	09/04/07	SUBMITTED FOR SITE PLAN REVIEW	DAM	PBB	TWS	:H	1/15/08	REVISED PER CITY OF PORTLAND PEER REVIEW COMMENTS	PBB	PBB
REV	DATE	STATUS	BY	CHKD.	APPD.	REV.	:DATE	STATUS	BY	CHKD

24" INLINE GRATE



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PO. Box 1 PO. Bo	DRAWN: JAV				F PHARM , PORTLAND,	MAINE 04103	
CONSOLIANIS Cumberland, Malno 04 CIVIL ENGINEERING & LANDOCAPE ARCHITECTURE 61207.829.0804 (80.207.829.22 LIENT:	CLIND, AD I			SITE	DETAILS	e * e	
UNIVERSITY OF NEW ENGLAND	DATE: OCTOBER 2007	PROJ. NO.	. 1			06-21608	REV.
11 HILLS BEACH ROAD, BIDDEFORD, MAINE 04005	SCALE: N.T.S.	DWG.				C-302	J



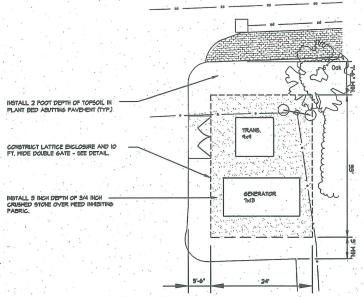
- Place Root Ball so top of Rootball is i' above "Finished Grade" <u>Do Not Cover Trunk Flare Mith</u> <u>SOIL</u>.

9' SHREDDED BARK MULCH IN SAICER, KEEP MULCH 8' AWAY FROM TRANK, 9' MICH EARTH SAICER BEYOND EDGE OF ROOT BALL.

- CUT & REMOVE BURLAP AND WIRE FROM TOP 2/3 OF ROOTBALL. FOLD REMAINING BURLAP & WIRE DOWN INTO PLANT PIT. IF BURLAP IS SYNTHETIC REMOVE COMPLETELY.

PLANTING SOIL MIX (20 PARTS TOPSOIL, 4 PARTS PEAT MOSS AND I PART WELL ROTTED MANURE OR OTHER COMPOSITED DRISHAR MATERIAL OF LOUP JULY BACKFILL IN LOOSE LIFTS OF 6"4-8" DEPTH. SETTLE WITH THOROUSH


- PLACE ROOTBALL ON UNEXCAVATED OR TAMPED SOIL.



FENCE TO BE NORTHERN WHITE CEDAR, CONTRACTOR SHALL APPLY 2 COATS HIGH QUALITY EXTERIOR SOLID WHITE STAIN.

CONTRACTOR TO PROVIDE SHOP DRAWINGS OF PROPOSED FENCE ENCLOSURE AND GATE.

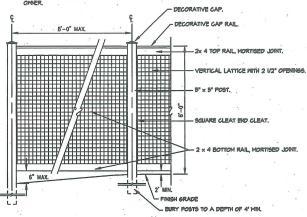ALL GATE HARMARE TO BE HEAVY DUTY AND HOT DIPPED GALVANIZED. GATE TO HAVE LOCKING DEVICE. COORDINATE LOCKING DEVICE NITH THE OWNER.



B' BARK MULCH IN SAUCER - Flant Saucer, 4° Continuous No Saucer Where Shrubs Occur in Beds

FINSH GRADE - TOP OF ROOT BALL TO BE EGUAL TO OR 1-2" ABOVE FINISH GRADE.

- PLANTING SOIL MIX (20 PARTS TOPSOIL, 4 PARTS PEAT MOSS AND I PART MELL ROTTED MAURE OR OTHER COMPOSIED ORGANIC MATERIAL OF LOW JOU BACKFELL IN LOOSE LET'S OF "8" DEPTH, SETTLE NITH THOROUSH MATER SOAKING.

- Hole to be as deep as the root Ball (No deeper). TYPICAL SHRUB PLANTING

SCALE: NTS

DECIDUOUS TREE PLANTING

UTILITY ENCLOSURE AND GATE

SCALE: N.T.S.

SCALE: 1"=10"

NOTES:

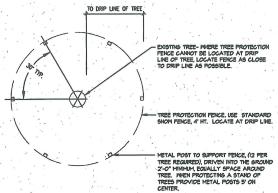
1. ALL DEAD AND DISEASED LIMBS SHALL BE PRIMED PRIOR TO BEGINNING
CONSTRUCTION. ALL PRIMING AND TREE PROTECTION SHALL BE DONE BY A
MAINE LICENSED ARBORIST SICH AS BARTLETT TREE (888-9940).

2. A DEEP SOIL INLECTION OF FERTILIZER AND MYCORRHIZA SHALL BE GIVEN UNDER THE TREE CANOPY TO PROMOTE ROOT GROWTH, INLECTION AMOUNTS AND TIMING SHALL BE APPROVED BY THE LANDSCAPE ARCHITECT.

UTILITY ENCLOSURE ENLARGEMENT PLAN

5. NO EQUIPMENT SHALL BE PARKED OR STORED UNDER THE EXISTING TREE CANOPY.

4. In areas phere the proposed excavation will impact the existing tree roots the roots shall be primed by a licensed arborist.



EXISTING TREE PROTECTION PLAN SCALE: N.T.S.

- METAL POST TO SUPPORT FENCE, (12 PER TREE REQUIRED), DRIVEN INTO THE GROUND 2-0" MINIMAM, EGUALLY SPACE AROUND TREEL, NIEW PROTECTING A STAND OF TREES PROVIDE METAL POSTS 5" ON CENTER.

RE RE	V. DATE	STATUS				-	DATE	STATUS			APPD.
A	09/04/07	SUBMITTED FOR SITE PLAN REVIEW	DAM	PBB	TWS	Н	1/24/08	PERMIT SET	PBB	PBB	TWS
B	10/12/07	REVISED AND SUBMITTED TO THE CITY OF PORTLAND FOR SITE PLAN REVIEW	DEPT	PBB	TWS	1	2/5/08	REVISED AND SUBMITTED TO THE CITY OF PORTLAND FOR SITE PLAN REVIEW	PBB	PBB	TWS
C	10/19/07	ISSUED FOR SCHEMATIC DESIGN	PBB	PBB	TWS			. the state of the			
D	10/31/07	SUBMITTED TO CITY OF PORTLAND FOR SLODA APPLICATION	PBB	PBB	TWS						
E 6	11/27/07	ISSUED TO ARCHITECT FOR CHECK SET	PBB	PBB	TWS						
8 F	12/06/07	ISSUED FOR DESIGN DEVELOPMENT	WTE	PBB	TWS			and the second of the second o			
ů G	1/15/08	REVISED PER CITY OF PORTLAND PEER REVIEW COMMENTS	PBB	PBB	TWS		1.				





P.O. Box 86A


tol.207.829.6994 fbrt.207.829.2231

DATE: OCTOBER 2007 UNIVERSITY OF NEW ENGLAND 11 HILLS BEACH ROAD, BIDDEFORD, MAINE 04005 SCALE: N.T.S.

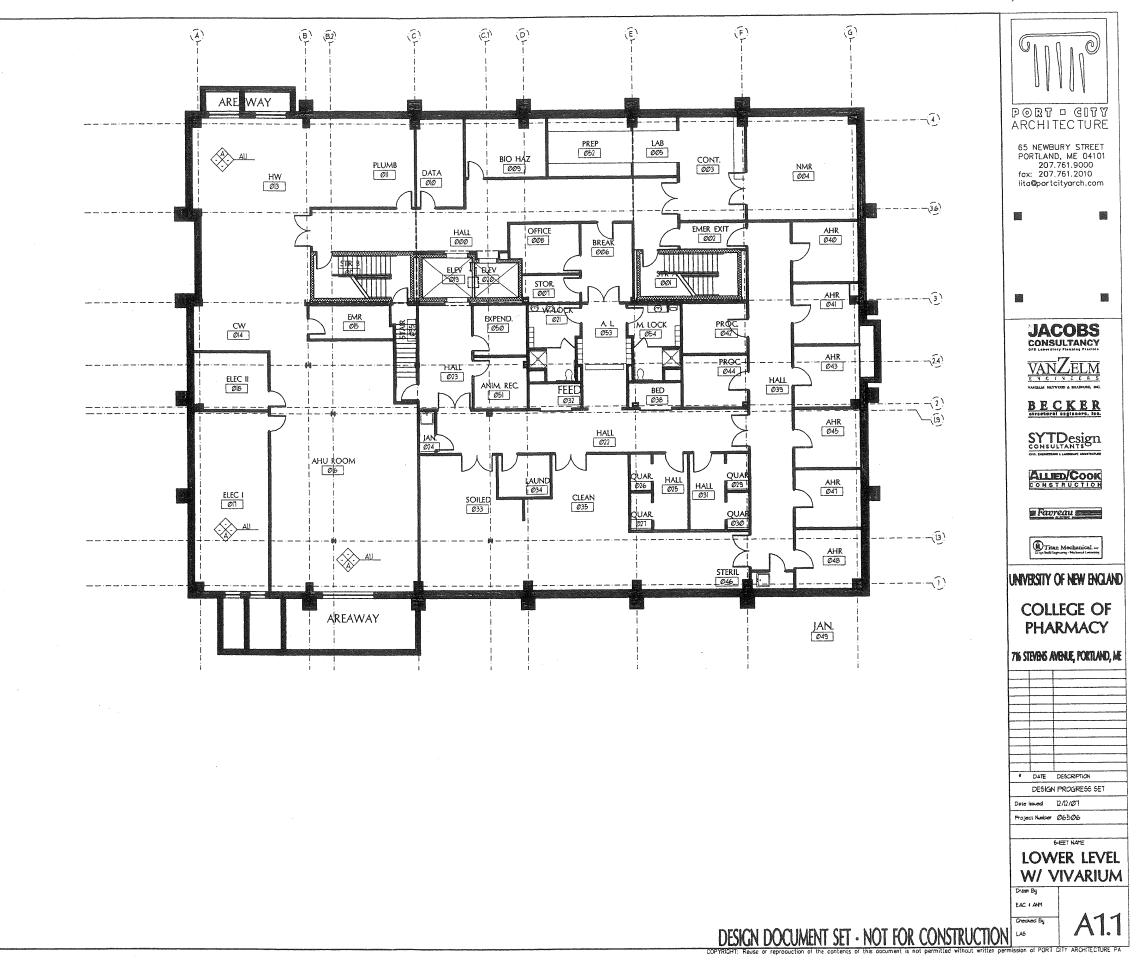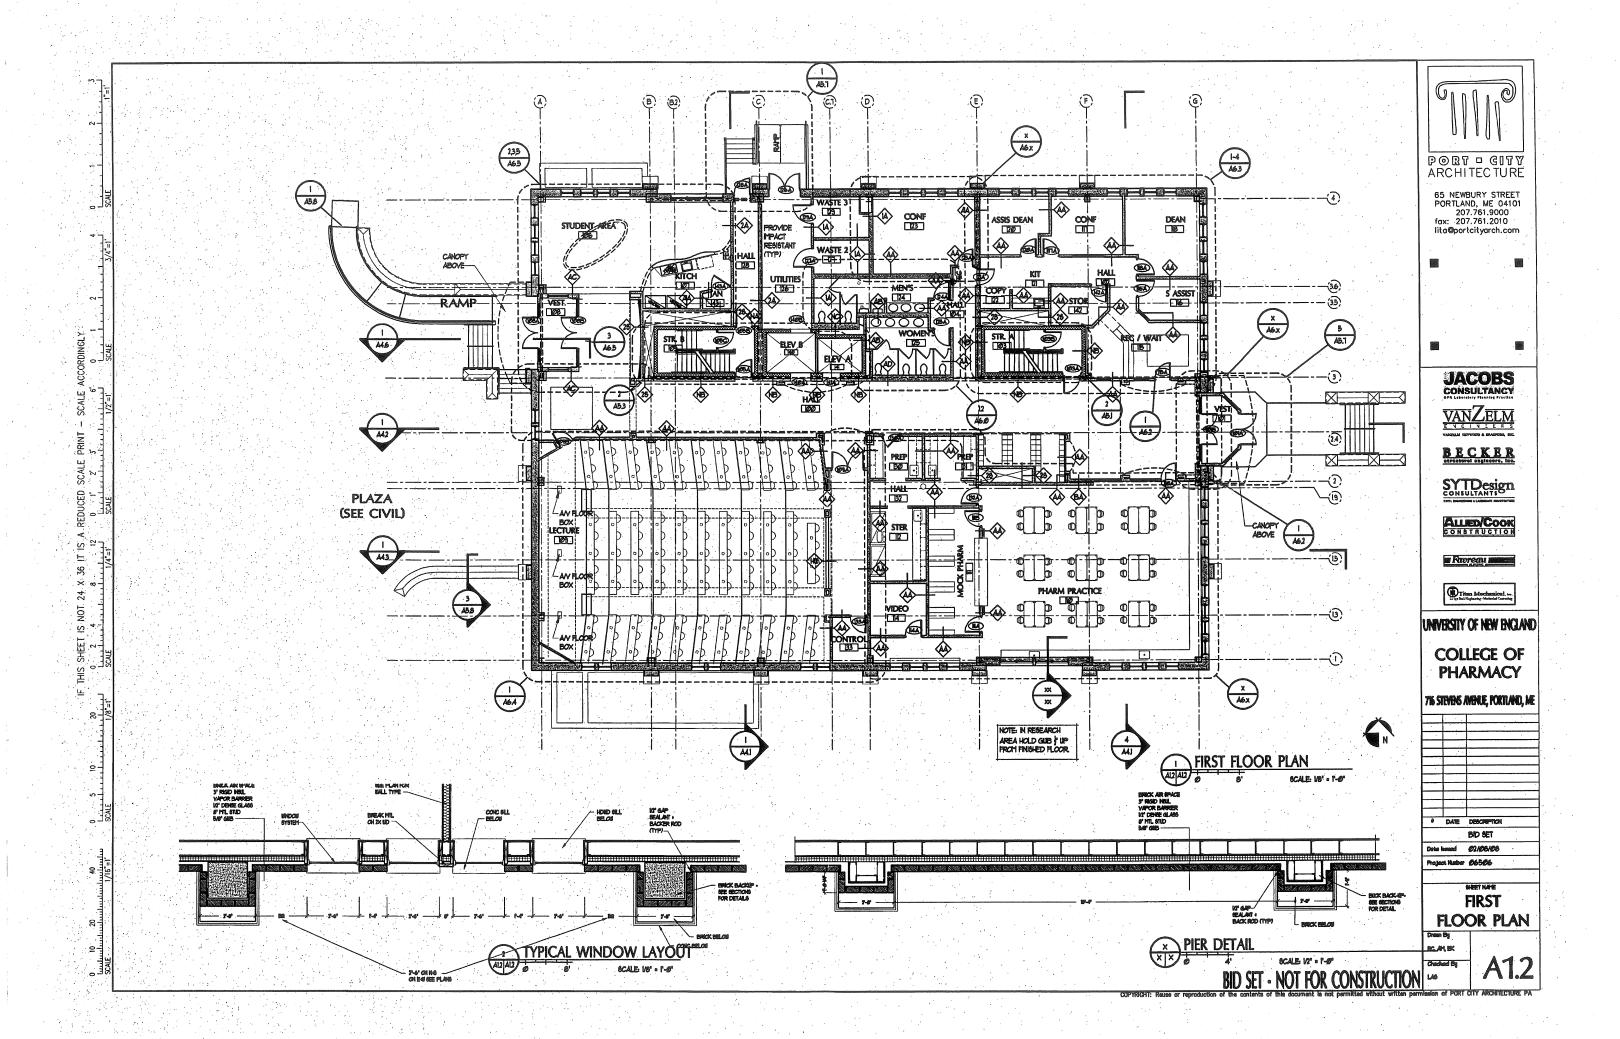
DESIGN: JAV COLLEGE OF PHARMACY 716 STEVENS AVENUE, PORTLAND, MAINE 04103 DRAWN: JAV CHKD: ADJ SITE DETAILS 06-21608

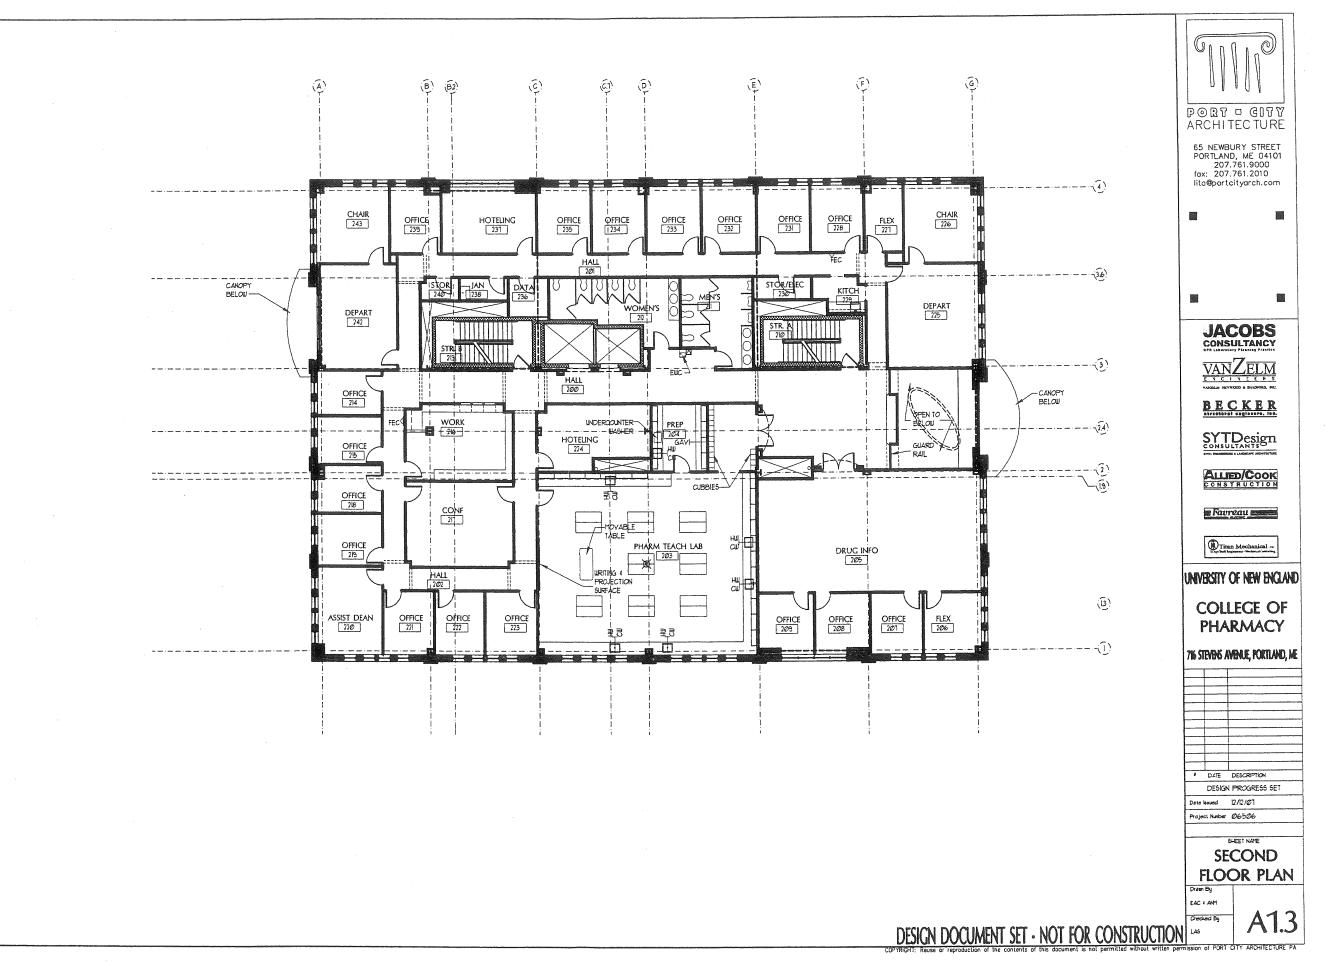
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