

<u>PLOT PLAN</u> Scale: 1/8" = 1'-0"



ewed for Code Compliance

Reviewed for Code Compliance Permitting and Inspections Departmer Approved with Conditions 07/26/2018

ISSUED 5/09/18

 These drawings are the property of MacLeod Structural Engineers, PA and are for the exclusive use of:

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 MACLEOD

 STRUCTURAL ENGINEERS, PA

 90 Bridge Street Suite 252

 Westbrook, Maine 04092

 207.839.0980

 Rebuilt Deck

 30-32 Elmwood Street

 Portland, Maine

 BRUCE W.

 MACLEOD

 No. 5422


 ITTLE:

 PLOT PLAN

 DATE:
 04.23.18

 DRAWN BY: BWM
 DRAWING NUMBER:

 C-1

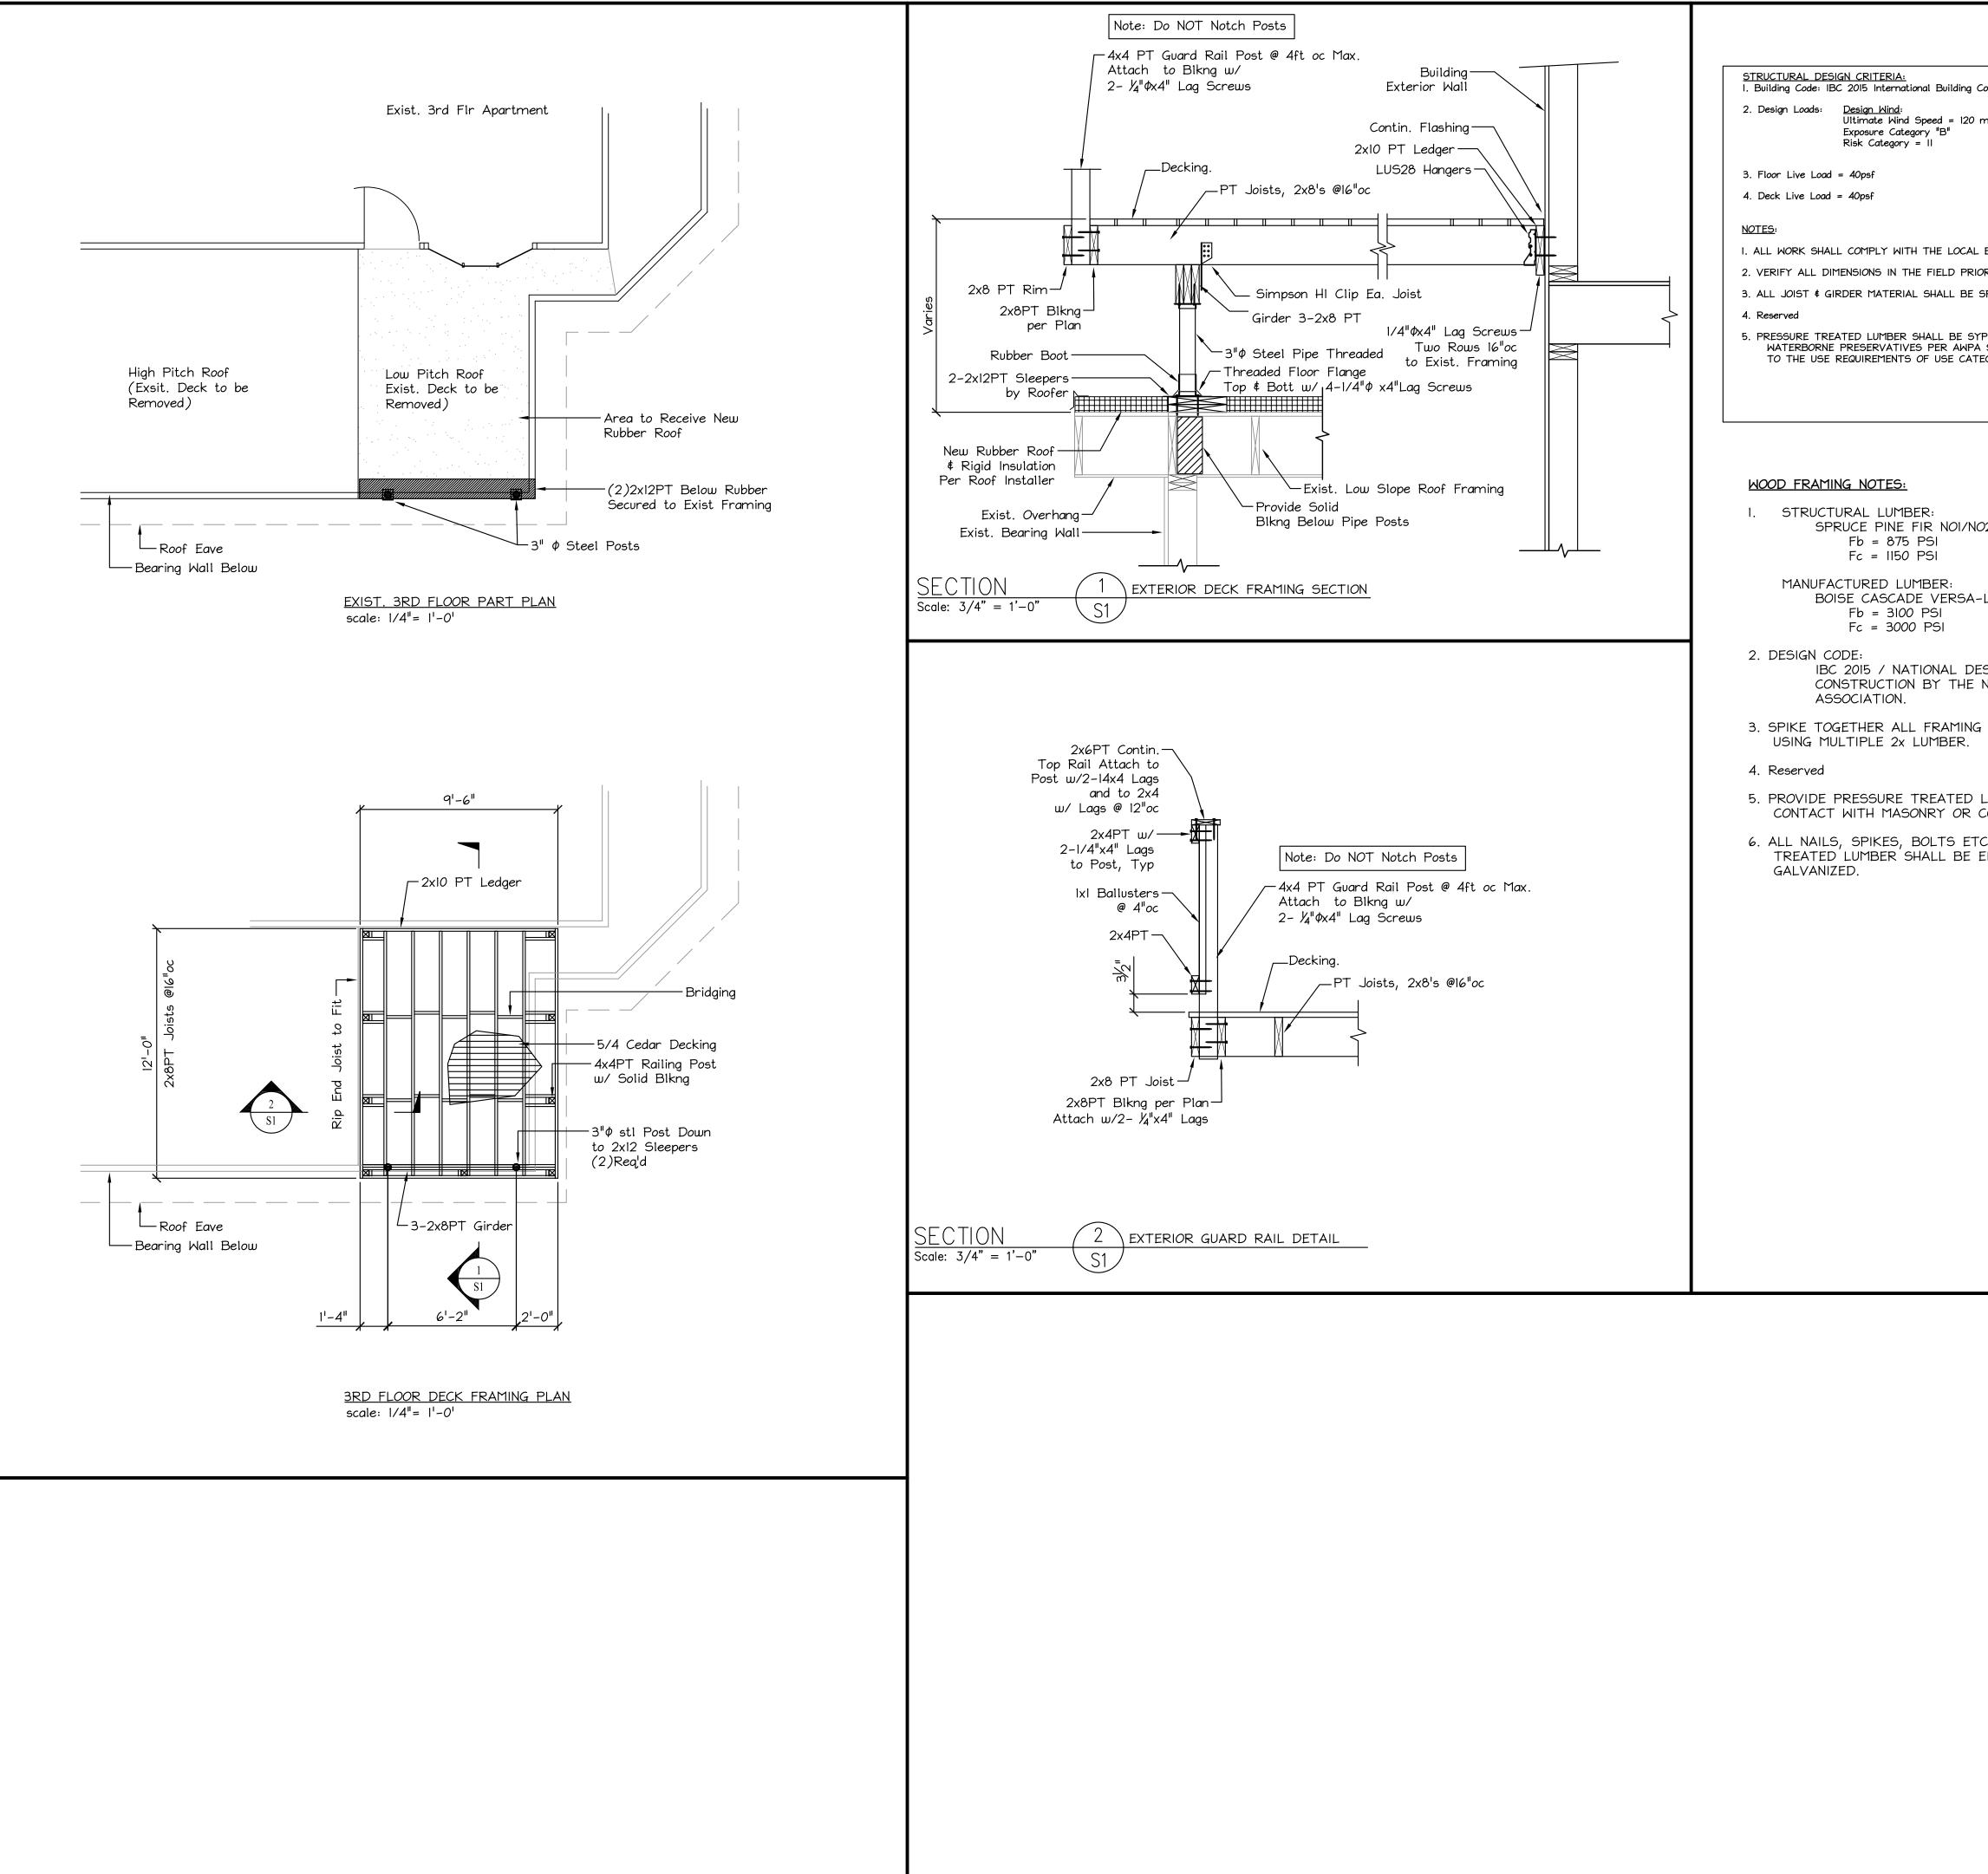

	30-32 Elmwood St
Code (Maine Building and Energy Code) Design Snow: mph Ground Snow = 60 Thermal Factor =1.0 Import. Factor =1.0 Exposure Factor =1.0	Portland, Maine <u>CBL:</u> 143 A002001
	PROJECT DIRECTORY Reviewed for Code Compliance
L BUILDING CODE. (MUBEC) IOR COMMENCING WORK. SPF#2 OR BETTER	Permitting and Inspections Department Approved with Conditions OWNER: 07/26/2018 KAREN MCKINNEY
YP NO.2 OR BETTER TREATED WITH A STANDARD UI, COMMODITY SPEC. A, TEGORY 2 (UC2)	MCKINNEY PROPERTY MANAGEMENT 45 PARK STREET UNIT #5 PORTLAND, MAINE 04101 1-860-338-4027
	DESIGN PROFESSIONAL: MACLEOD STRUCTURAL ENGINEERS, PA 90 BRIDGE STREET WESTBROOK, MAINE 04092 TEL. 207-839-0980
102 OR BETTER Fv = 125 PSI E = 1400000 PSI -LAM 2.0 3100	<u>GENERAL CONTRACTOR:</u> TBD
Fv = 285 PSI E = 2000000 PSI ESIGN SPECIFICATIONS FOR WOOD	PROJECT DESCRIPTION:
G MEMBERS WHICH ARE BUILT-UP	THIS PROJECT CONSISTS OF REMOVING AND REBUILDING AN EXISTING DECK ON THE THIRD FLOOR OF THE BUILDING WITH A REDUCED FOOTPRINT
LUMBER FOR ALL LUMBER IN CONCRETE.	GENERAL NOTES:
TC. FASTENING MEMBERS TO PRESSURE EITHER STAINLESS STEEL OR HEAVY	I. STRUCTURAL DRAWINGS SHALL BE USED IN CONJUNCTION WITH JOB SPECIFICATIONS AND ARCHITECTURAL, MECHANICAL, ELECTRICAL, PLUMBING, AND SITE DRAWINGS. CONSULT THESE DRAWINGS FOR LOCATIONS AND DIMENSIONS OF OPENINGS, CHASES, INSERTS, REGLETS, SLEEVES, DEPRESSIONS, AND OTHER DETAILS NOT SHOWN ON THE STRUCTURAL DRAWINGS.
	2. ALL DIMENSIONS AND CONDITIONS MUST BE VERIFIED IN THE FIELD. ANY DISCREPANCIES SHALL BE BROUGHT TO THE ATTENTION OF THE ENGINEER BEFORE PROCEEDING WITH THE AFFECTED PART OF THE WORK.
	3. THE STRUCTURE IS DESIGNED TO BE SELF SUPPORTING AND STABLE AFTER THE BUILDING IS COMPLETE. IT IS THE CONTRACTOR'S SOLE RESPONSIBILITY TO DETERMINE ERECTION PROCEDURES AND SEQUENCE TO ENSURE SAFETY OF THE STRUCTURE AND PERSONNEL DURING ERECTION. THIS INCLUDES THE ADDITION OF THE NECESSARY SHORING, SHEETING, TEMPORARY BRACING, GUYS OR TIEDOWNS. SUCH MATERIAL SHALL REMAIN THE PROPERTY OF THE CONTRACTOR AFTER COMPLETION OF THE PROJECT.
	4. ALL APPLICABLE FEDERAL, STATE, AND MUNICIPAL REGULATIONS SHALL BE FOLLOWED, INCLUDING THE FEDERAL DEPARTMENT OF LABOR OCCUPATIONAL SAFETY AND HEALTH ACT.
	5. IT IS THE OWNER'S SOLE RESPONSIBILITY TO EMPLOY ONE OR MORE SPECIAL INSPECTORS (IF REQUIRED) TO PROVIDE INSPECTIONS IN COMPLIANCE WITH ALL APPLICABLE REQUIREMENTS OF IBC 2006.
	ISSUED 5/09/18
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	MACLEOD STRUCTURAL ENGINEERS, PA 90 Bridge Street Suite 252 Westbrook, Maine 04092 207.839.0980
	Rebuilt Deck 30-32 Elmwood Street Portland, Maine
	BRUCE W. MACLEOD No. 5422 TITLE: Framing Plan
	DATE: 04.23.18 DRAWN BY: BWM DRAWING NUMBER: SCALE: as noted PROJ NO: 2018-018 S-1