#### ADDENDUM NO. 3, APRIL 30, 2009

RE: Ocean Avenue Elementary School City of Portland RFP No. 7109

Portland, Maine BGS project No. 723

A/E Comm. No. 3316.10

FROM: WBRC Architects Engineers City of Portland, Purchasing Department

 141 Preble Street
 389 Congress Street

 Portland, Maine 04101
 Portland, Maine 04101

 Tel: (207) 828-4511
 Tel: (207) 874-8654

#### TO: Prospective Bidders

This Addendum forms a part of the Contract Documents and modifies the original Bidding Documents dated April 02, 2009, as noted below. Acknowledge receipt of the Addendum in the space provided on the Bid Form. Failure to do so may subject the Bidder to disqualification.

This Addendum consists of the following:

- Clarifications

- Document Changes
- Specification Changes
- Drawing Changes
- Section 2B-1
- Section 2B-2
- ADD3-AE102-C-1
- ADD3-AE103-B-1
- ADD3-AE201-1
- ADD3-AE304-1
- ADD3-AE306-1
- ADD3-AE504-1 & ADD3-AE504-2
- ADD3-AE508-1
- ADD3-PL601-1
- ADD3-E-001-1
- ADD3-ES101-1
- ADD3-ES501-1

#### **CLARIFICATIONS:**

1. *Is temporary light and power to be included in Div. 26?* The cost for temporary utilities shall be carried by the General Contractor as per Section 015000, Temporary Facilities and Controls.

#### **DOCUMENT CHANGES:**

- 2. Section 2B-1, Proposal Form for General Contractors, DELETE in its entirety and REPLACE with the attached Section 2B-1.
- 3. Section 2B-2, Proposal Form for Subcontractors, DELETE in its entirety and REPLACE with the attached Section 2B-2.

#### **SPECIFICATION CHANGES:**

4. Section 011000, Summary, Par. 1.6.b.2, ADD the following:

"Contractor to provide 1 1/2-inch painted steel pipe drop with threaded connection. Anchor pipe to 4x4x3/8 angle strut spanning between adjacent beams/joists as required to support pipe (Supplied under section 05 50 00). Provide escutcheon ring where pipe passes through APC, Typical. Confirm final location of drop and pipe size with Owner."

- 5. Section 012300, Alternates:
  - 1. Par. 3.1.A.2, DELETE in its entirety and REPLACE with the following: "2. Alternate: If the City of Portland does not construct the proposed sewer separation project on the south side of the Ocean Avenue Elementary School site during the school construction period, then the following alternate will replace the base bid item for the school's sanitary service connection. Connect building sewer to existing City line on south side of the parcel to meet City design standards. This connection will not be at a manhole."
- 6. Section 054000, Cold Formed Metal Framing, Par. 3.5.H, DELETE in its entirety.
- 7. Section 055000, Metal Fabrications:
  - Par. 1.2.A.10, DELETE in its entirety. Bollards to be provided and installed as detailed on C501 as a part of the Sitework sub-proposal.
  - Par. 3.4, DELETE in its entirety
- 8. Section 066400, Plastic Paneling:
  - Par. 2.1.A, DELETE in its entirety and REPLACE with the following:
    - "A. Homogenous panel manufactured using mixture of calcium carbonate, fiberglass and resin (FRP). Meet USDA requirements.
      - 1. Manufacturers: Subject to compliance with requirements, provide products by the following:
        - a. Marlite Standard FRP.
      - 2. Nominal thickness: Not less than 3/32 inch.
      - 3. Surface finish: Pebbled surface.
      - 4. Color: to be selected by Architect from Manufacturer's full range.
  - Par. 2.2.A, DELETE in its entirety and REPLACE with the following:
    - "A. Trim accessories: Provide Manufacturer's standard PVC trim moldings to match adjacent wall panels. Provide edge moldings at top and bottom of panels, division moldings between panels and preformed inside and outside corners at all corner locations."
  - Par. 2.2.B, DELETE in its entirety.
  - Par. 2.2.C. DELETE in its entirety.
- 9. Section 072100, Thermal Insulation, Par. 3.4.A.1, DELETE in its entirety and REVISE to read: "Extend insulation down to top of footing."

- 10. Section 072700, Air Barriers, Par. 3.2, ADD paragraph B. "B. Seal sheathing joints according to Air Barrier manufacturer's recommendations and as compatible with Exterior Gypsum Sheathing system."
- 11. Section 076200, Sheet Metal Flashing and Trim, Par. 3.5.B.1, CHANGE "8 inches" to "12 inches."
- 12. Section 092900, Gypsum Board:
  - Par. 2.3.A.1, ADD Subpar. b as follows: "b. Lafarge Gypsum, Buchanan, NY plant."
  - Par. 2.4.A.2, CHANGE Thickness: 5/8 inch.
  - Par. 2.7, DELETE in its entirety.
  - Par. 3.4, DELETE in its entirety.
  - Par. 3.6.A, DELETE in its entirety and REPLACE with the following: "A. Cementitious Backer Units: ANSI A 108.11, at locker rooms and toilet rooms."
- 13. Section 093000, Tiling:
  - Par. 2.3, DELETE in its entirety
  - Par. 3.3, DELETE in its entirety.
  - Par. 3.8.B.1.a, AFTER the word "corridor", ADD ", lobby, and vestibule".
  - Par. 3.8.B.2.a, AFTER the word "tile", ADD "at toilet and locker room locations"
- 14. Section 105126, Plastic Lockers:
  - Par. 3.4.A.11.c, ADD Subpar. 1. As follows: "1. Install filler panels, to match adjacent lockers, as needed so final installation of lockers and fillers is a monolithic flush wall to wall condition, full height of lockers."
  - Par. 3.4.C.11.c, ADD Subpar. 1. As follows: "1. Install filler panels, to match adjacent lockers, as needed so final installation of lockers and fillers is a monolithic flush wall to wall condition, full height of lockers."
- 15. Section 122413, Roller Shades:
  - Par. 2.3.B.1, ADD Subpar. a. as follows: "a. Horizontal seams may be necessary to fabricate shades to cover glazing. Locate such horizontal seams so when shades are drawn in closed position, they align with horizontal window mullions."
  - Par. 2.3.D, DELETE in its entirety and REPLACE with the following:
    - "D. Direction of roll:
      - 1. Windows with a single shade: Regular, from back of roller.
      - 2. Windows with both a light filtering and room darkening shade: Room darkening shade direction of roll to be regular, from back of roller. Light filtering direction of roll to be reverse, from front of roller."

• Par. 3.5.A. DELETE in its entirety and REPLACE with the following:

#### "A. Provide roller shades as indicated below:

- 1. Exterior windows at South Facing Rooms with interior light shelves: Install both a light filtering and room darkening roller shade at each window. Light filtering shades to be installed so top of shade aligns with the top of interior light shelf. Blackout shades to be installed at top (head) of window opening. Both shades to extend to sill.
- 2. Exterior windows at East, West and North Facing Rooms: Install light filtering shades only. Install light filtering shades at top (head) of window opening and extend to sill.
- 3. Interior Window treatments are only required in Social Work #127 and Resource #152B. Install blackout shades on observation window within Soc Work #127. Install blackout shades over door glazing, on both leafs, of door #152B (Resource #152 side).
- 4. Cafeteria #103: Install light filtering shades only at seven lowest exterior windows on East face and at two North face exterior windows.
- 5. Library #149: Install light filtering shades only at five lowest exterior windows and at each exterior door glazing panel.
- 6. Exclusions: Do not provide roller shades in Vestibules, Lobby, Stairs, Gym or interior windows or storefront except as noted in #3 above."
- 16. Section 220553, Identification for Plumbing Piping and Equipment:
  - ADD Par. 2.4 as follows:
    - "2.4 CEILING DOTS
      - A. Self-adhesive labels, color-coded removable paper dots, 3/4" diameter, Seton Blank Inventory Labels. Coordinate color scheme with Owner."
  - ADD Par. 3.5 as follows:

#### "3.5 CEILING DOT INSTALLATION

- A. Provide ceiling dots on ceiling grid locating concealed plumbing equipment above finished ceilings. Coordinate color scheme with Owner."
- 17. Section 223500, Domestic Water Heat Exchangers, Par. 2.2, DELETE in its entirety.
- 18. Section 230553, Identification for HVAC Piping and Equipment:
  - ADD Par. 2.6 as follows:
    - "2.6 CEILING DOTS
      - A. Self-adhesive labels, color-coded removable paper dots, <sup>3</sup>/<sub>4</sub>" diameter, Seton Blank Inventory Labels. Coordinate color scheme with Owner."
  - ADD Par. 3.6 as follows:

#### "3.6 CEILING DOT INSTALLATION

- A. Provide ceiling dots on ceiling grid locating concealed mechanical equipment above finished ceilings. Coordinate color scheme with Owner."
- 19. Section 265600, Exterior Lighting:
  - ADD Par. 1.6, ADD Subpar C as follows: "C. Package aluminum poles for shipping according to ASTM B 660."

- Par. 2.6 DELETE in its entirety and REPLACE with the following:
  - "2.6 ALUMINUM POLES
    - A. Poles: Seamless, extruded structural tube complying with ASTM B 429/B 429M, Alloy 6063-T6 with access handhole in pole wall.
      - 1. Shape: Round, straight or Square, straight, as indicated.
      - 2. Mounting Provisions: Butt flange for bolted mounting on foundation.
    - B. Grounding and Bonding Lugs: Welded 1/2-inch threaded lug, complying with requirements in Division 26 Section "Grounding and Bonding for Electrical Systems," listed for attaching grounding and bonding conductors of type and size listed in that Section, and accessible through handhole.
    - C. Brackets for Luminaires: Detachable, with pole and adapter fittings of cast aluminum. Adapter fitting welded to pole and bracket, then bolted together with stainless-steel bolts.
      - 1. Tapered oval cross section, with straight tubular end section to accommodate luminaire.
      - 2. Finish: Same as pole and luminaire.
    - D. Aluminum Finish: Thermoset polyester powder coat paint applied over a titanated zirconium conversion coating.
      - 1. Color: As selected by Architect from manufacturer's standard range."
- 20. Section 270500, Common Work Results for Communications, Par. 1.2, ADD Subpar. B as follows:
  - "B. Related Sections include the following:
    - 1. Division 1 Section 019113 "General Commissioning Requirements"."
- 21. Section 312000, Earth Moving:
  - Par. 1.2.A.9, ADD the following: "including all underslab utility piping within the building."
  - Par. 3.8 Excavation for Elevator Cylinder This section describes the responsibility of the site contractor for this work.
  - Par. 3.8.B, DELETE in its entirety and REPLACE with the following: "B. Coordinate with elevator contractor the excavation and backfill of elevator appurtenances."

#### **DRAWING CHANGES:**

- 22. Sheet CD101, Site Demolition and Preparation Plan, change note 13 and L-1 change note 22 "When this project begins the Katsura and two oak trees will have already been transplanted to a holding area on the southwest side of the existing building. Site contractor shall be responsible for protecting the holding area as per the tree protection specifications outlined on drawing L-2, replanting the trees during planting operations in the locations indicated on drawing L-1, and providing water to the City arborist who will care for the trees during the construction period."
- 23. Drawing C501, Flag Pole Base Detail, ADD the note: "Site contractor shall provide, excavate, install, and backfill six flagpole base structures. Final location of these structures will be determined by the designer. One base is for the flagpole. Five of the bases are for proposed Owner provided artwork that will be located in the area of the entrance plaza."
- 24. Sheet AE101-A, First Floor Plan Seg. A, Music #114, ADD Light Shelves at all exterior windows in Music 114 as per Detail E11-AE508.
- 25. Sheet AE102-C, Second Floor Plan Seg. C, REVISE portions as indicated on Sketch ADD3-AE102-C-1.

- 26. Sheet AE103-B, First Floor Reflected Ceiling Plan Seg. B, REVISE portions as indicated on Sketch ADD3-AE103-B-1.
- 27. Sheet AE201, Exterior Elevations, REVISE portions as indicated on Sketch ADD3-AE201-1.
- 28. Sheet AE202, Exterior Elevations, Key Plan, CHANGE elevation reference "N7" to "N6".
- 29. Sheet AE304, Wall Sections, REVISE portions as indicated on Sketch ADD3-AE304-1.
- 30. Sheet AE306, Wall Sections, REVISE portions as indicated on Sketch ADD3-AE306-1.
- 31. Sheet AE504, Wall Details, REVISE portions as indicated on Sketches ADD3-AE504-1 and ADD3-AE504-2.
- 32. Sheet AE508, Window Details, REVISE portions as indicated on Sketch ADD3-AE508-1.
- 33. Sheet PL601, Plumbing Legend & Schedules, REVISE portions as indicated on Sketch ADD3-PL601-1.
- 34. Sheet E-001, Electrical Legend & Light Fixture Schedule, REVISE portions as indicated on Sketch ADD3-E-001-1.
- 35. Sheet ES101, Site Electrical Plan, REVISE portions as indicated on Sketch ADD3-ES101-1.
- 36. Sheet ES501, Site Electrical Details, REVISE portions as indicated on Sketch ADD3-ES501-1.

#### END OF ADDENDUM

#### SECTION 2-B-1 PROPOSAL FORM FOR GENERAL CONTRACTORS (PUBLIC SCHOOL PROJECTS)

BIDDE	ER:			_
				_
				_
TO:				
10.				_
				_
				_
A. specific For		carefully examined the form of contract, general cated, Prepared by		
as well equipm	ent, and	remises and conditions affecting the work, we the materials necessary for and reasonably incidental amount of:	undersigned propos to the construction	e to furnish all labor, and completion of this
		\$		
	The abo	ove amount includes the following allowances: Ro	efer to Section 0121	100
		nce Item No. 1: Interior Signs nnce Item No. 2: Excess Electrical Utility Allowan	\$ <u>15,0</u> \$ <u>25,0</u>	
B.	Alterna	ate prices as follows: Refer to Section 012300		
		ate No. 1: City Sewer Connection	Add	\$
		ate No. 2: Bleachers ate No. 3: Stage Curtains	Add Add	\$
		tte No. 4: Anti Graffiti Protection	Add	\$ \$
		ate No. 5: Upgraded State Lighting	Add	\$
		te No. 6: Not Used	Add	\$
		ate No. 7: Sun Shades	Add	\$
	Alterna	ate No. 8: Stainless Steel Door Frames	Add	\$
C.		ice Items: The undersigned agrees to perform add		
		l omitted, at the following prices which shall not very at least 90% of the add unit price: Refer to Section		0% and Deduct unit price
			Unit Price ItemU	Init Price Cost
			Additional	Omitted
			Per Cu. Yd.	Per Cu. Yd.
	1)	Excavation and Removal	\$	\$
	2)	Excavation and Backfill (open)	\$	\$
	3)	Excavation and Backfill (trench)	\$	\$
	4)	Rock Excavation and Removal (open)	\$	\$

	5)	Rock Excavation	and Removal (tre	ench)	\$		\$
	6)	Granular Borrow	Fill		\$		\$
	7)	Gravel Base			\$		\$
	8)	Gravel Subbase			\$		\$
	9)	Bio-Retention Be	d Underdrain Ma	terial	\$		\$
	10)	Bituminous Paver	ment HMA 12.5 r	nm (per ton)	\$		\$
	11)	Bituminous Paver	ment HMA 19.0 r	nm (per ton)	\$		\$
	12)	4" perforated Typ	oe B Underdrain (	Lin. Ft.)	\$		\$
	13)	12" corrugated Po	olyethylene pipe (	Lin. Ft.)	\$		\$
	14)	Impervious Pond	Liner (Sq. Ft.)		\$		\$
C.	This pr	oposal includes the	e following adden	da to the plans	and specific	eations:	
	Adden	lum No	_, Dated	_Addendum N	lo	_, Dated	
	Adden	lum No	_, Dated	_Addendum N	Vo	_, Dated	
	Adden	dum No	_, Dated	_Addendum N	lo	_, Dated	
D. as calle		ubcontract proposa	ls as follows: (Lis	t those trades i	required, but	t do not comb	ine trades except
	Trade	_	Name of	Subcontractor			Amount
						\$	
						\$	
						\$	
						\$	
						\$	

The undersigned agrees that each of the above named subcontractors represents a bonafied SUBPROPOSAL based on the plans and specifications and will be used for the work indicated at the amount stated, unless a substitution is made by mutual agreement as provided for in section 1, paragraph 6, "Instructions to Bidders". In the event alternate prices are requested and various trades are involved, the general contractor may use properly filed subproposals even though a change in subcontractors from those carried in his base proposal may occur. If he does use different subcontractors because of alternates, he shall use supplemental sheets attached to the proposal form (2-B1) to indicate such changes.

bonds ar such acc fulfilled Monday	The undersigned agrees, if this proposal is accepted, to sign a contract and deliver it, along with the ad affidavits of all insurance specified within twelve (12) calendar days after the date of notification of septance, except if the 12th day falls on a holiday, a Saturday or Sunday, then the conditions will be if the required documents are received before 12 o'clock noon on the day following the holiday, or the following the Saturday or Sunday, and as a guarantee thereof, herewith submits a certified or cashier's bid bond as required.
The und	ersigned agrees, if awarded the contract, to complete the work on or before
	This proposal includes the cost of a 100% performance bond and a 100% payment bond.
	Signed
	Ву
	Address
NOTE: partners	If bidder is a corporation, write State of incorporation, and if a partnership, give full names of all

#### 2-B2


# MAINE CONSTRUCTION BID DEPOSITORY (PUBLIC SCHOOL PROJECTS) PROPOSAL FORM FOR SUBCONTRACTORS LONG FORM

To:					
For gr	een envelope copy, list any genera	l contractor(s) excluded from y	our bid.		
PROJ	ECT:				
SECT	ION(S) QUOTED:				
- DD I GI	A CANODINA DE CENTON A	ar ar		Φ.	
PRICE	E QUOTED: SECTION\$ ION\$	SECTION ¢	ION	\$	
SECT	ION\$ ION\$	SECTION \$			_
	AL COMBINED PRICE (if applica				
A.	The undersigned propose to furraccordance with the hereinafter all the work specified in the about dated Prepared by	nish all labor and materials required described plans, specifications we stated section(s) of the specification.	nired for general of fications	completing i conditions and s and contrac	n d addenda, t drawings
В.	Alternate prices are submitted as Alternate No. 1: City Sewer Co Alternate No. 2: Bleachers Alternate No. 3: Stage Curtains Alternate No. 4: Anti Graffiti C Alternate No. 5: Upgraded State Alternate No. 6: Not Used Alternate No. 7: Sun Shades Alternate No. 8: Stainless Steel	Add Add oatings e Lighting	\$ Add	\$ \$	
C.	The subcontract proposal includ (List addenda and issue date of e				ications:
D.	The undersigned agrees that, if h selected general contractor a subfurnish the general contract with portion of the work.	ocontract in accordance with the	e terms o	of this subpro	posal, and
E.		License # (if app	licable)		
	(Firm Name of Sub-bide		/-		
	Signed by:		Da	te	
	Address			Ctat	77.
	Street	City		State	Zip


13A M.R.S.A., Chapter 12 and shall contact the Secretary of State for compliance.

F.

All foreign corporations intending to do business in Maine must comply with the provisions of

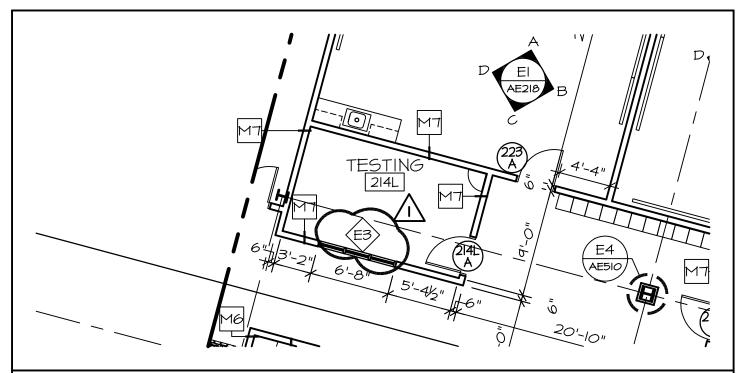

## PARTIAL PLAN

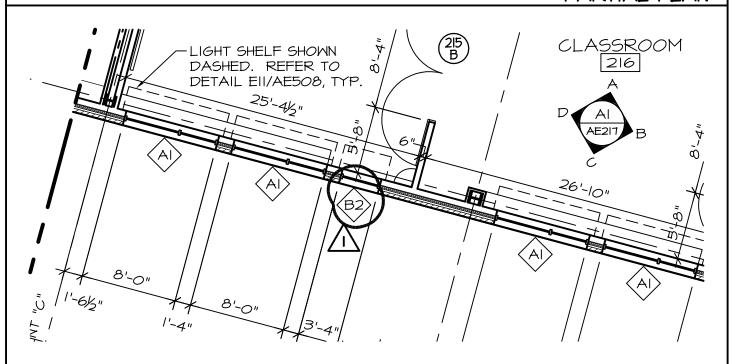

Al

# SECOND FLOOR PLAN SEG. C

1/8"=1'-0"

### PARTIAL PLAN



BANGOR, MAINE 207-947-4511 PORTLAND, MAINE 207-628-451 SARASOTA, FLORIDA 941-556-0757 WWW.WBRCAE.COM

SCALE: 1/8" = 1'-0"WBRC CAD FILE: 331610
PROJECT No. 331610
JOB CAP/DRAW: TRJ

OCEAN AVENUE ELEMENTARY SCHOOL

PM:


MEJ SHEET No.


PROJECT:


ADDENDUM #3 ADDED WINDOW TAGS CHECKED BY: MEJADD3-AE102-C-


SHEET TITLE:


DATE: 04-30-2009 © COPYRIGHT 2009 WBRC

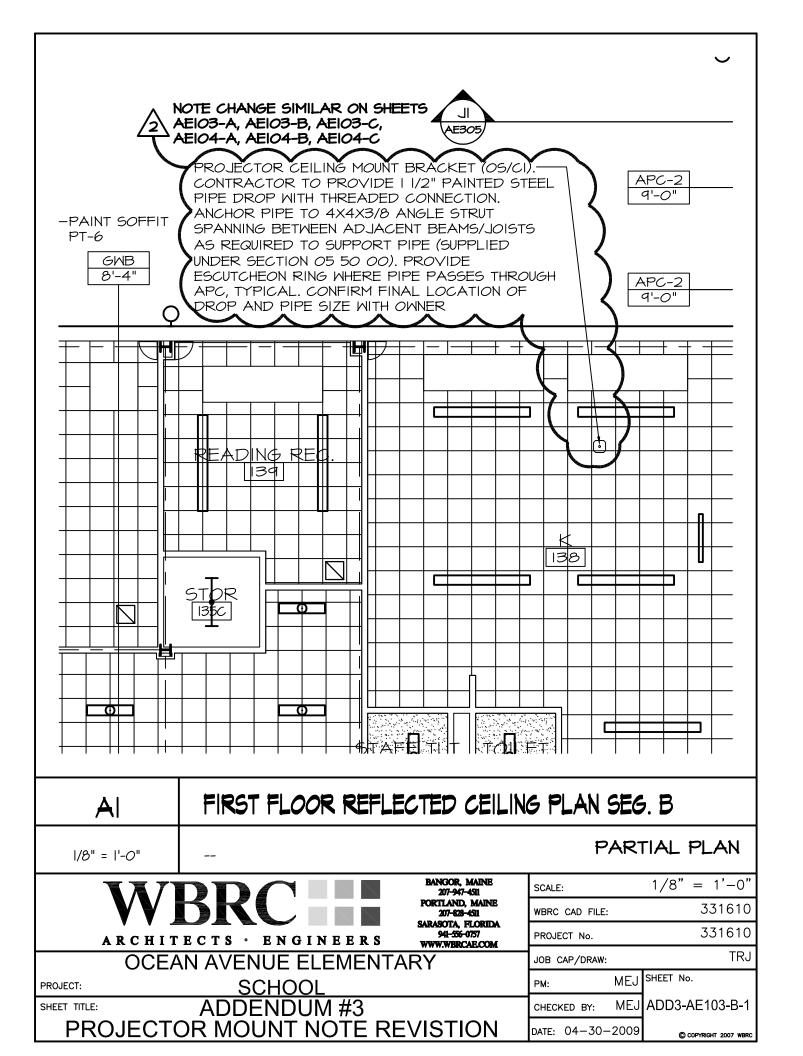


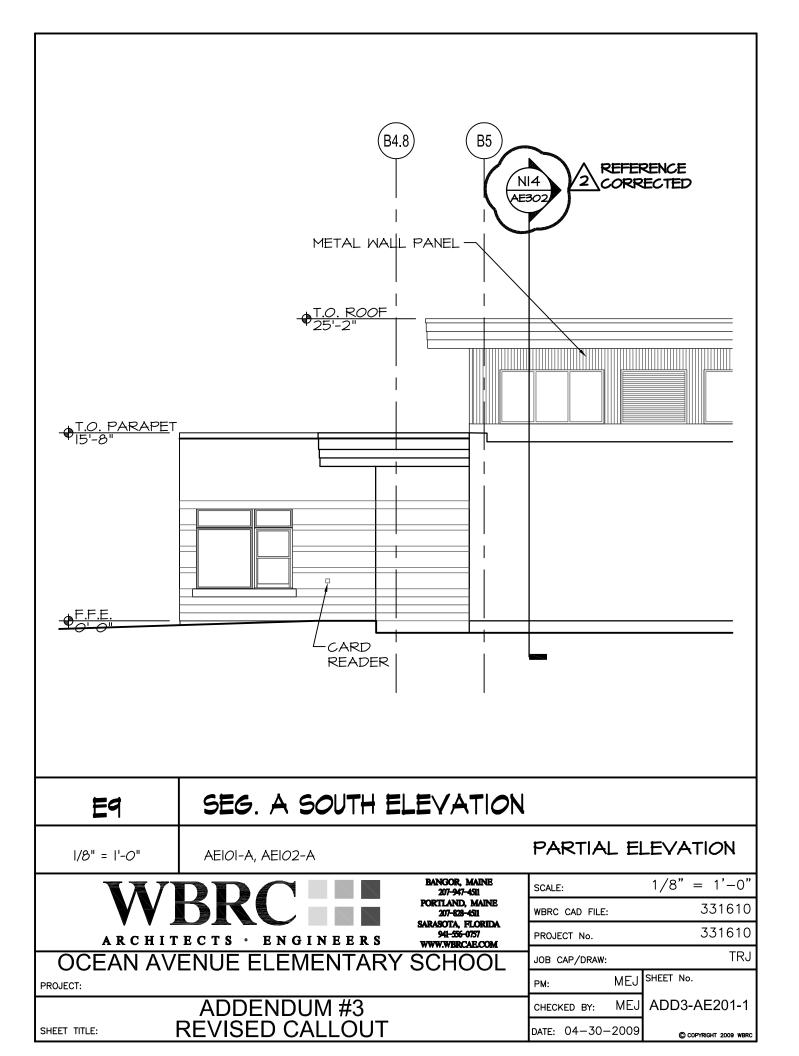


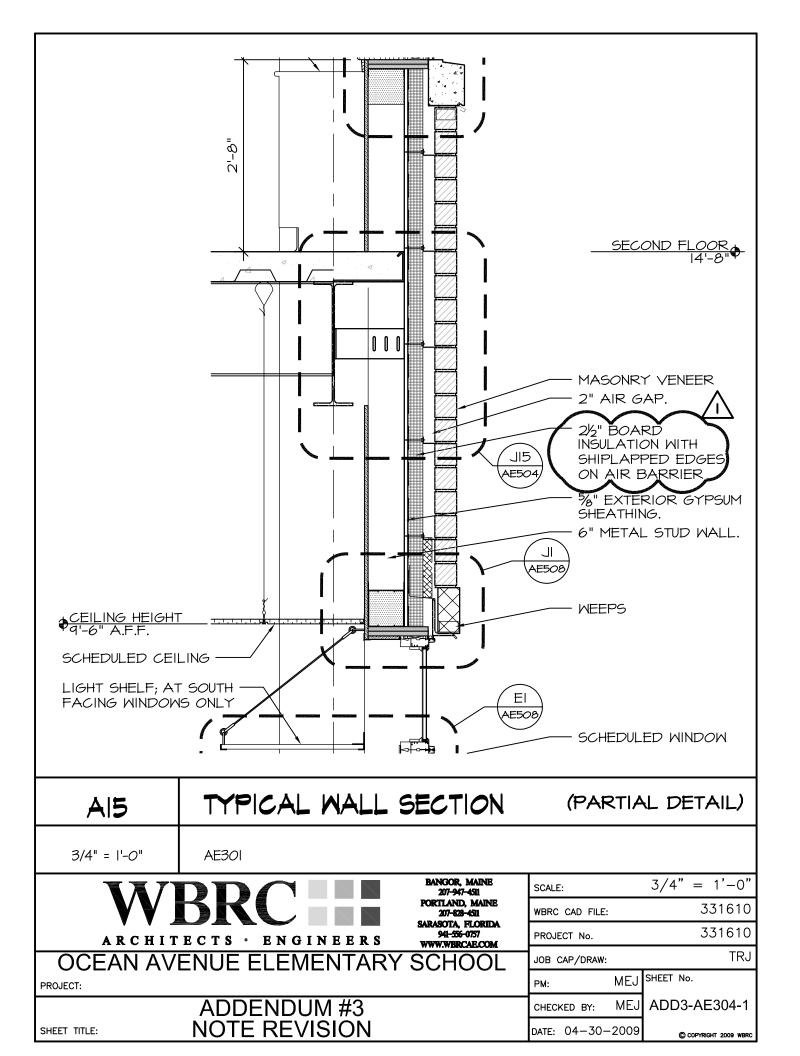


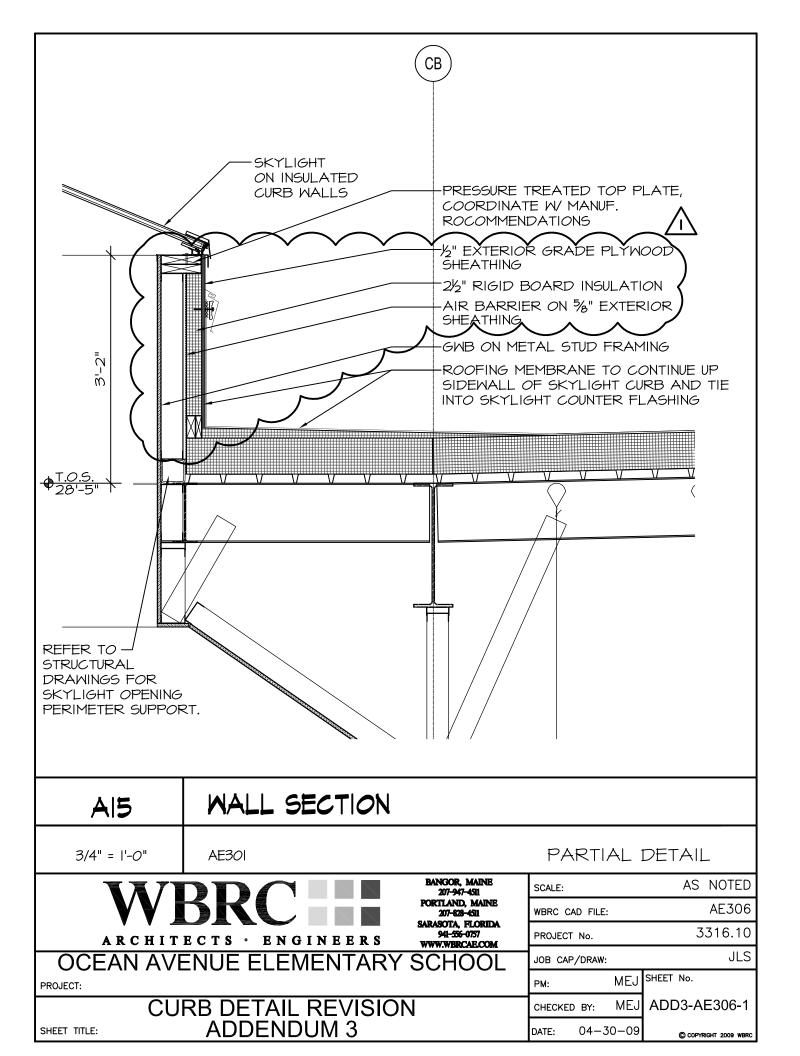


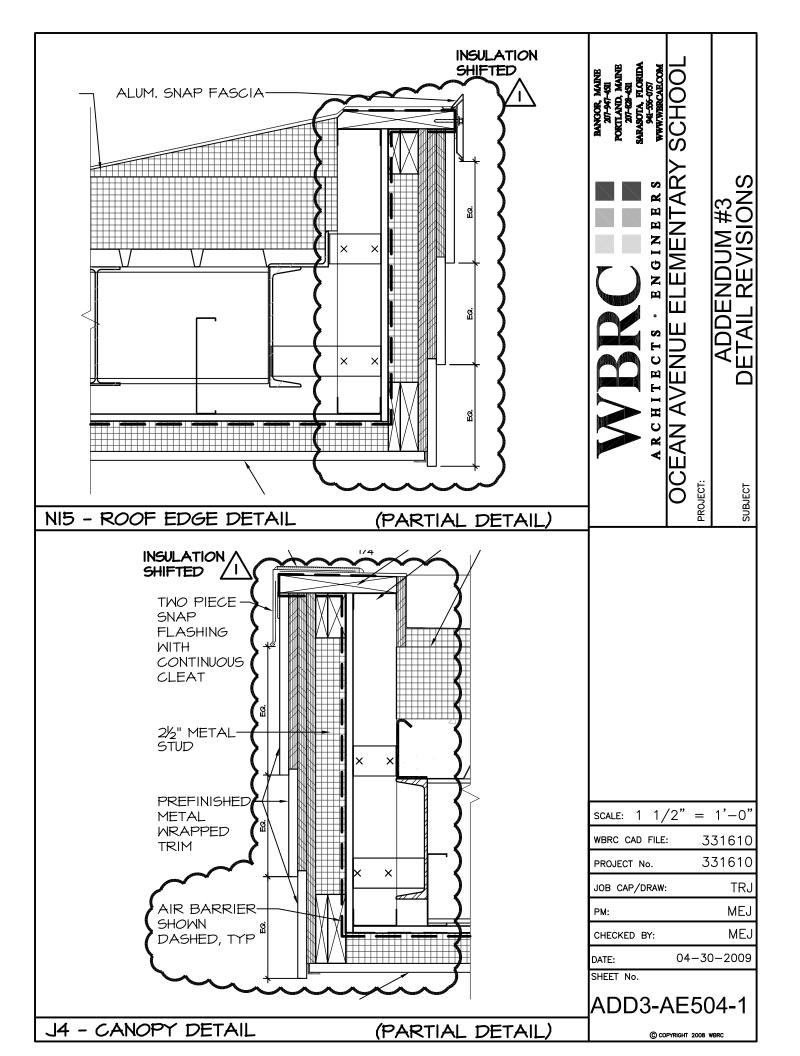

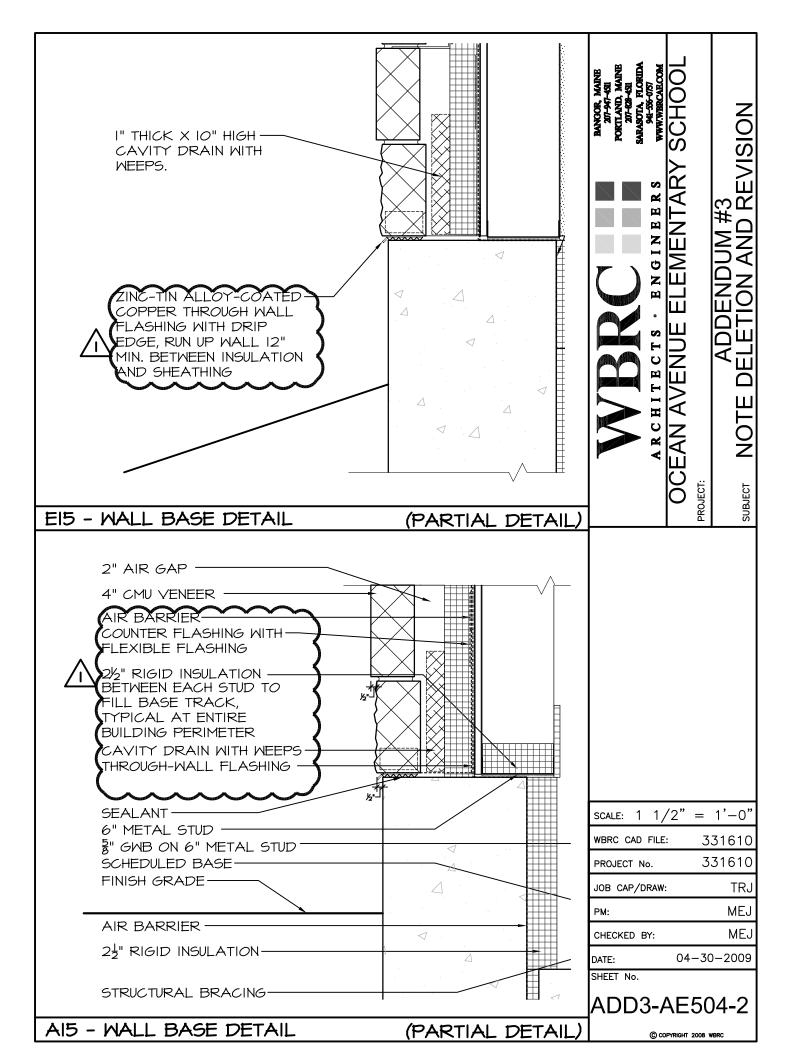

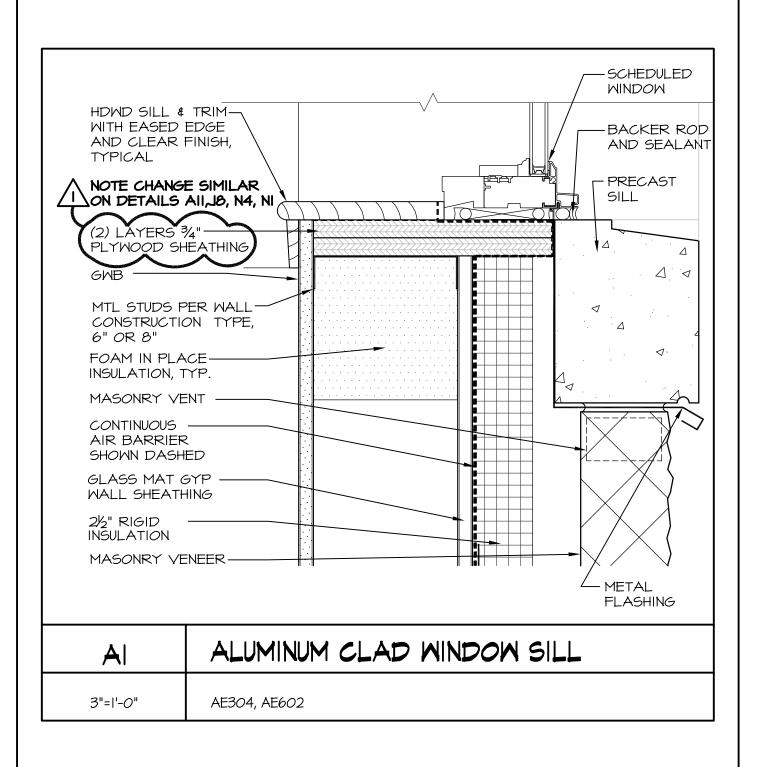

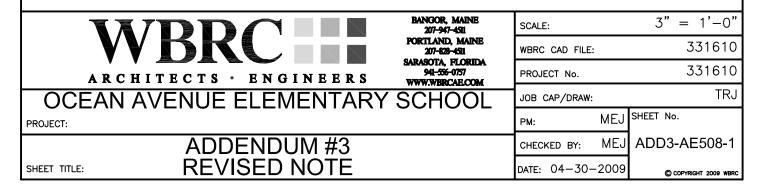

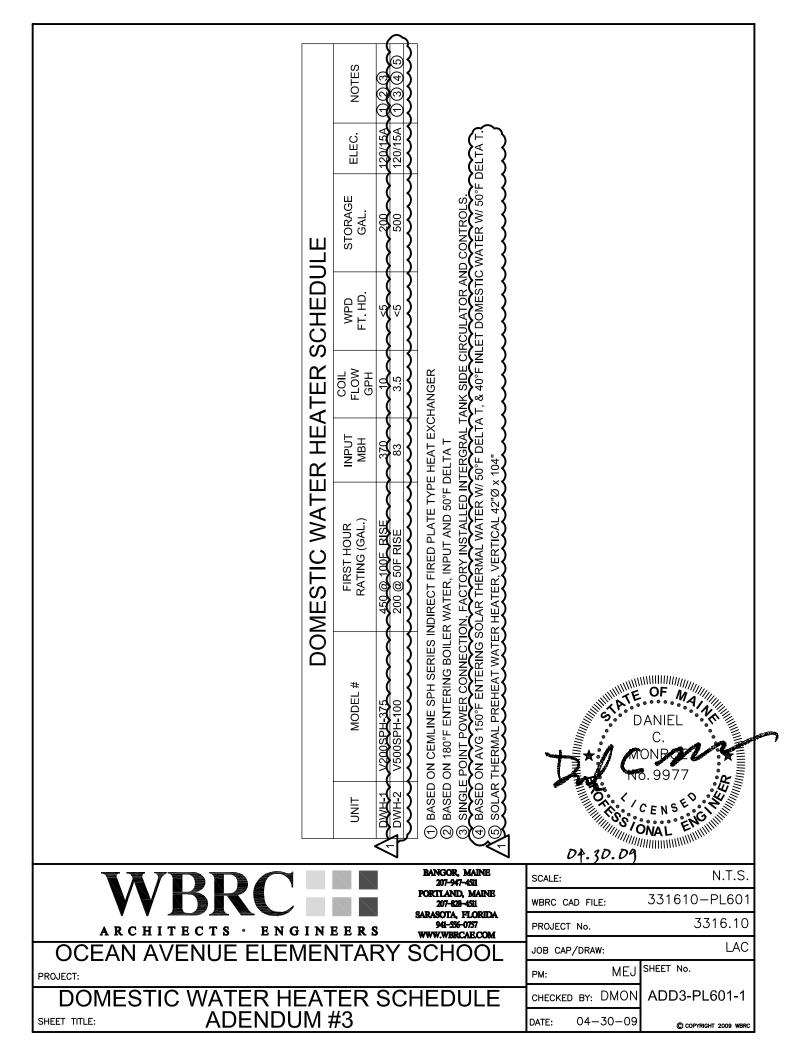

35W	54.2%	L16	ELECTRONIC	32W T8	WHITE CROSS	FINELITE SYS O AT 118 SO DOWN 377 SM EE	4, F	CEILING MOUNTED WALL WASH	×
17W	75.1%	L16	ELECTRONIC	17W T8	RIBBED ACRYLIC	LUMAX INDUSTRIES COD11702-E04SA-EB	2' L	WALL MOUNTED FLUORESCENT	J1
35W	75.1%	L16	ELECTRONIC	32W T8	RIBBED ACRYLIC	LUMAX INDUSTRIES COD13248-E04SA-EB	4. L	WALL MOUNTED FLUORESCENT	٦
29W	86.9%	L16	PROG. START ELECTRONIC	32W T8	PRISMATIC ACRYLIC	COLUMBIA LIGHTING RO4-132-EDU	4' L	CEILING SURFACE WRAPAROUND	Н
150W			PULSE START		CLEAR TEMPERED GLASS	KIM LIGHTING FM-NS2H4-150PMH277/PRA14-5125-FM-**	14' H	EXT. POLE MOUNTED SITE LIGHT	G1
150W			PULSE START		CLEAR TEMPERED GLASS	_	16' H	EXT. POLE MOUNTED SITE LIGHT	G
								NOT USED	F5
150W			PULSE START	150W MH	CLEAR TEMPERED GLASS	KIM LIGHTING 1SA-SAR4-150PMH277-**-HS/PSA16-4125-SA-**	16'Н	EXT. POLE MOUNTED SITE LIGHT	F4
300W		•	PULSE START	150W MH	CLEAR TEMPERED GLASS	KIM LIGHTING 2SB-SAR3-150PMH277-**/PSA16-4125-SB-**	16. н	EXT. POLE MOUNTED SITE LIGHT	F3
100W	•	•	PULSE START	100W MH	CLEAR TEMPERED GLASS	KIM LIGHTING 1SA-SAR2-100PMH277-**-HS/PSA12-4125-SA-**	12. Н	EXT. POLE MOUNTED SITE LIGHT	F2
150W			PULSE START	150W MH	CLEAR TEMPERED GLASS	KIM LIGHTING 1SA-SAR3-150PMH277-**-HS/PSA16-4125-SA-**	16'H	EXT. POLE MOUNTED SITE LIGHT	F1
100W			PULSE START	100W MH	CLEAR TEMPERED GLASS	KIM LIGHTING 1SA-SAR3-100PMH277-**-HS/PSA12-4125-SA-**	12' Н	EXT. POLE MOUNTED SITE LIGHT	ш
72W	82.8%	125	ELECTRONIC	32W TRIPLE	CLEAR RIBBED ACRYLIC	FC LIGHTING ECP663-277-232-E-SA-RA	18" Ø	CEILING SUSPENDED PENDANT	ш
234W	60.1%	L16	ELECTRONIC	54W T5HO	STRAIGHT BLADES	COLUMBIA LIGHTING LHEM4-454-WCBST-EU-LHEMWG	4' L	CEILING SUSPENDED HIGH BAY FLUORESCENT	D
35W		L16	ELECTRONIC	32W T8	PERFORATED METAL	ALERA LIGHTING CV-4-2T8-PERF-CM24-E-277-MW-4	4' L	CEILING SUSPENDED DIRECT/INDIRECT	C2
198W	71.6%	L16	DIMMING	32W T8	STRAIGHT BLADES	ALERA LIGHTING CVL-12-2T8-20/80-FCM12-LD-ED277	12'L	CEILING SUSPENDED DIRECT/INDIRECT	2
	198W 35W 72W 100W 150W 150W 150W 150W 150W 150W 150		60.1% 82.8% 82.8% 75.1% 75.1%	L16 71.6%  L16 60.1%  L25 82.8%  L16 86.9%  L16 75.1%  L16 54.2%	ELECTRONIC   L16   71.6%   ELECTRONIC   L16   60.1%   ELECTRONIC   L16   60.1%   ELECTRONIC   L25   82.6%   ELECTRONIC   L25   82.6%   ELECTRONIC   L25   82.6%   ELECTRONIC   L16   86.9%   ELECTRONIC   L16   54.2%   ELECTRONIC   L16   ELECTRONIC   ELECTRONIC   L16   ELECTRONIC   L16   ELECTRONIC   L16   ELECTRONIC   ELECTRONIC   L16   ELEC	32WT8 ELECTRONIC L16 71.6%  54W ELECTRONIC L16 60.1%  54W ELECTRONIC L16 60.1%  32WT8 ELECTRONIC L25 82.6%  TARPLE 100W PULSE START  100W PULSE START  100W PULSE START  150W	ALERA LIGHTING	ALERA LIGHTING	12



 Volume

INTRUSION DETECTION SYSTEM MOTION DETECTOR

SECURITY ALARM SYSTEM SIREN/STROBE

HANDICAP ELECTRICALLY-ASSISTED DOOR OPENER PUSHBUTTON 7

INTERCOM SYSTEM CONTROL PANEL

¥

FIRE ALARM SYSTEM POWER EXTENDER FA-PE

MAIN SWITCH BANK - MOUNT @ 48" AFF TO CENTER- REFER TO DETAIL A8/E-501 FOR MORE INFORMATION MSB

TEACHER CONTROL CENTER - SAME NOTES AS MAIN SWITCH BANK ABOVE TCC

POWER CONTROL CENTER - MOUNTED ABOVE ACCESSIBLE CEILING IN SHOWN LOCATION - REFER TO DETAIL A8/E-501 PCC

INTERCOM SYSTEM SUB-STATION - WITH "M" INDICATES MASTER STATION

ပ

KEYPAD - FOR ACCESS CONTROL OR INTRUSION DETECTION SYSTEM AS NOTED KEY O M

DOORBELL VIBRATING BELL

DOORBELL PUSH BUTTON

INTERCOM CALL BUTTON - REFER TO DETAIL A5/E-502 FOR MORE INFORMATION

3316.10 MEJ 3316.10-E-001 OCEAN AVENUE ELEM. SCHOOL 퓜 **ADDENDUM #3** WBRC CAD FILE: JOB CAP/DRAW: SHEET TITLE: PROJECT No. PROJECT: SCALE

04.30.09 S ADD3-E-001-1 <u>Ж</u> SHEET No. CHECKED DATE:

C COPYRIGHT 2008 WBRC

