#### ADDENDUM NO. 1, APRIL 14, 2009

RE: Ocean Avenue Elementary School City of Portland RFP No. 7109

Portland, Maine BGS project No. 723

A/E Comm. No. 3316.10

FROM: WBRC Architects Engineers City of Portland, Purchasing Department

 141 Preble Street
 389 Congress Street

 Portland, Maine 04101
 Portland, Maine 04101

 Tel: (207) 828-4511
 Tel: (207) 874-8654

## TO: Prospective Bidders

This Addendum forms a part of the Contract Documents and modifies the original Bidding Documents dated April 02, 2009, as noted below. Acknowledge receipt of the Addendum in the space provided on the Bid Form. Failure to do so may subject the Bidder to disqualification.

#### This Addendum consists of the following:

- Specification Changes
- Drawing Changes
- ADD1-CU101-1
- ADD1-AE103-A-1
- ADD1-AE103-B-1 & AE103-B-2
- ADD1-AE103-C-1
- ADD1-AE104-B-1
- ADD1-AE104-C-1
- ADD1-AE201-1
- ADD1-MH101-B-1 & MH101-B-2
- ADD1-MH101-C-1
- ADD1-MP102-B-1
- ADD1-MP102-C-1
- ADD1-EP101-B-1
- ADD1-EY101-A-1
- ADD1-EY101-B-1
- ADD1-E-601-1

### **SPECIFICATION CHANGES:**

- 1. Section 075423, Thermoplastic Polyolefin (TPO) Roofing:
  - Par. 2.1.A.1, ADD Subpar. c and d as follows:
    - "c. Firestone Building Products, UltraPly TPO."
    - "d. GAF Materials Corp., EverGuard TPO."
- 2. Section 087100. Finish Hardware:
  - Par. 2.06.B.7, DELETE in its entirety and REPLACE with the following: "Cylinders and keys shall be Sargent Signature Series and lettered keyway by Sargent Manufacturing, New Haven, CT.".
  - Par. 2.10.J, Electric Door Opener/Closer, ADD the following "or Gyro Tech GT-500 by Nabco."

- 3. Section 101400, Signage, Par. 2.2.B, ADD Item 5 as follows: "5. Size: 24" x 48".
- 4. Section 102813, Toilet and Bath Accessories, Par. 2.4.C.1, ADD the following: "as distributed by R & M Health Care Inc., Oakville, Canada, 866-664-1983."
- 5. Section 105126, Plastic Lockers:
  - Par. 2.4.A, DELETE in its entirety and REPLACE with the following: "A. Provide two side panel mounted double coat hooks within every locker in one and two tier lockers."
  - Par. 3.4.B.1, DELETE in its entirety.
- 6. Section 115213, Projection Screens:
  - Par. 2.1.B, Add Subpar. 2 as follows: "2. Size of Viewing Surface: 84" wide".
  - Par. 2.2.A.4, DELETE in its entirety.
  - Par. 2.2.B, ADD Subpar. 6 as follows: "6. Size of Viewing Surface: 10' x 10'."
  - Par. 2.3.H, DELETE in its entirety.
- 7. Section 230900, Instrumentation & Control for HVAC, Par. 2.1.B, DELETE in its entirety and REPLACE with the following: "B. The Portland School Department Energy Management System is a TAC/IA new and legacy system. The new Ocean Ave school shall be fully compatible with both of these existing systems. The system software and hardware shall have the capability to network and migrate to the existing facilities through a web browser".

## **DRAWING CHANGES**:

8. 2007 Survey Control Check

On April 6, 2009, Colonial Surveying Company performed an Elevation Check of the 2007 Survey Control shown on plans CS101 and CP101.

They observed some movement in the control points set in 2007 and have listed the correct elevations below. They also established a "Project Benchmark" on site. The Benchmark is a Railroad Spike set in the root of a large tree located on the east side of the Walton Street entrance and marks the southwest corner of land now or formerly of Joanne L. Gillies as shown on the Boundary Survey Plan, C-100. The elevation for the Project Benchmark is 57.42.


### **REVISED ELEVATIONS FOR SURVEY CONTROL POINTS:**


GMON W/DH 47.93 (UNCHANGED)
STA 25 49.65
STA 24 57.06
NEW PROJECT BENCHMARK 57.42


- 9. Sheet CU101, Site Utility Plan, CLARIFICATION as indicated on Sketch ADD1-CU101-1.
- 10. Sheet C504, Site Details, CLARIFICATION, Street Sign Details, for changeable signage letters, provide slide in letter set containing 250 characters.
- 11. Sheet S-001, Structural General Notes, ADD the following Note No. 22: "22. Cranked indicates beam to be fabricated to match ridge or valley of adjacent framing to maintain roof slope for drainage. Shop weld for full moment and shear capacity of the section."

- 12. Sheet S-102-A, S-102-B, and S-102-C in the "Second Floor, Low Roof, Mech. Mezz. Floor Framing Plan Notes," in Note #4 REVISE the length of the #3 hooked bars from 2'-0" to 3'-0" long.
- 13. Sheet S-301, Typical Concrete Details, Detail A1, "Typical Reinf. At Slab Edges", REVISE the length of the #3 hooked bars from 2'-0" to 3'-0" long.
- 14. Sheet AE103-A, First Floor Reflected Ceiling Plan Seg. A, REVISE portions as indicated on Sketch ADD1-AE103-A-1.
- 15. Sheet AE103-B, First Floor Reflected Ceiling Plan Seg. B, REVISE portions as indicated on Sketch ADD1-AE103-B-1 & AE103-B-2.
- 16. Sheet AE103-C, First Floor Reflected Ceiling Plan Seg. C, REVISE portions as indicated on Sketch ADD1-AE103-C-1.
- 17. Sheet AE104-B, Second Floor Reflected Ceiling Plan Seg. B, REVISE portions as indicated on Sketch ADD1-AE104-B-1.
- 18. Sheet AE104-C, Second Floor Reflected Ceiling Plan Seg. C, REVISE portions as indicated on Sketch ADD1-AE104-C-1.
- 19. Sheet AE201, Exterior Elevations, REVISE portions as indicated on Sketch ADD1-AE201-1.
- 20. Sheet MH101-B, First Floor Mechanical Ductwork Plan Seg. B, REVISE portions as indicated on Sketch ADD1-MH101-B-1 & MH101-B-2.
- 21. Sheet MH101-C, First Floor Mechanical Ductwork Plan Seg. C, REVISE portions as indicated on Sketch ADD1-MH101-C-1.
- 22. Sheet MP102-B, Second Floor Mechanical Piping Plan Seg. B, REVISE portions as indicated on Sketch ADD1-MP102-B-1.
- 23. Sheet MP102-C, Second Floor Mechanical Piping Plan Seg. C, REVISE portions as indicated on Sketch ADD1-MP102-C-1.
- 24. Sheet EP101-B, First Floor Electrical Power Plan Seg. B, REVISE portions as indicated on Sketch ADD1-EP101-B-1.
- 25. Sheet EY101-A, First Floor Systems Plan Seg. A, REVISE portions as indicated on Sketch ADD1-EY101-A-1.
- 26. Sheet EY101-B, First Floor Systems Plan Seg. B, REVISE portions as indicated on Sketch ADD1-EY101-B-1.
- 27. Sheet E-601, Electrical Panel Schedules, REVISE portions as indicated on Sketch ADD1-E-601-1.

#### **END OF ADDENDUM**

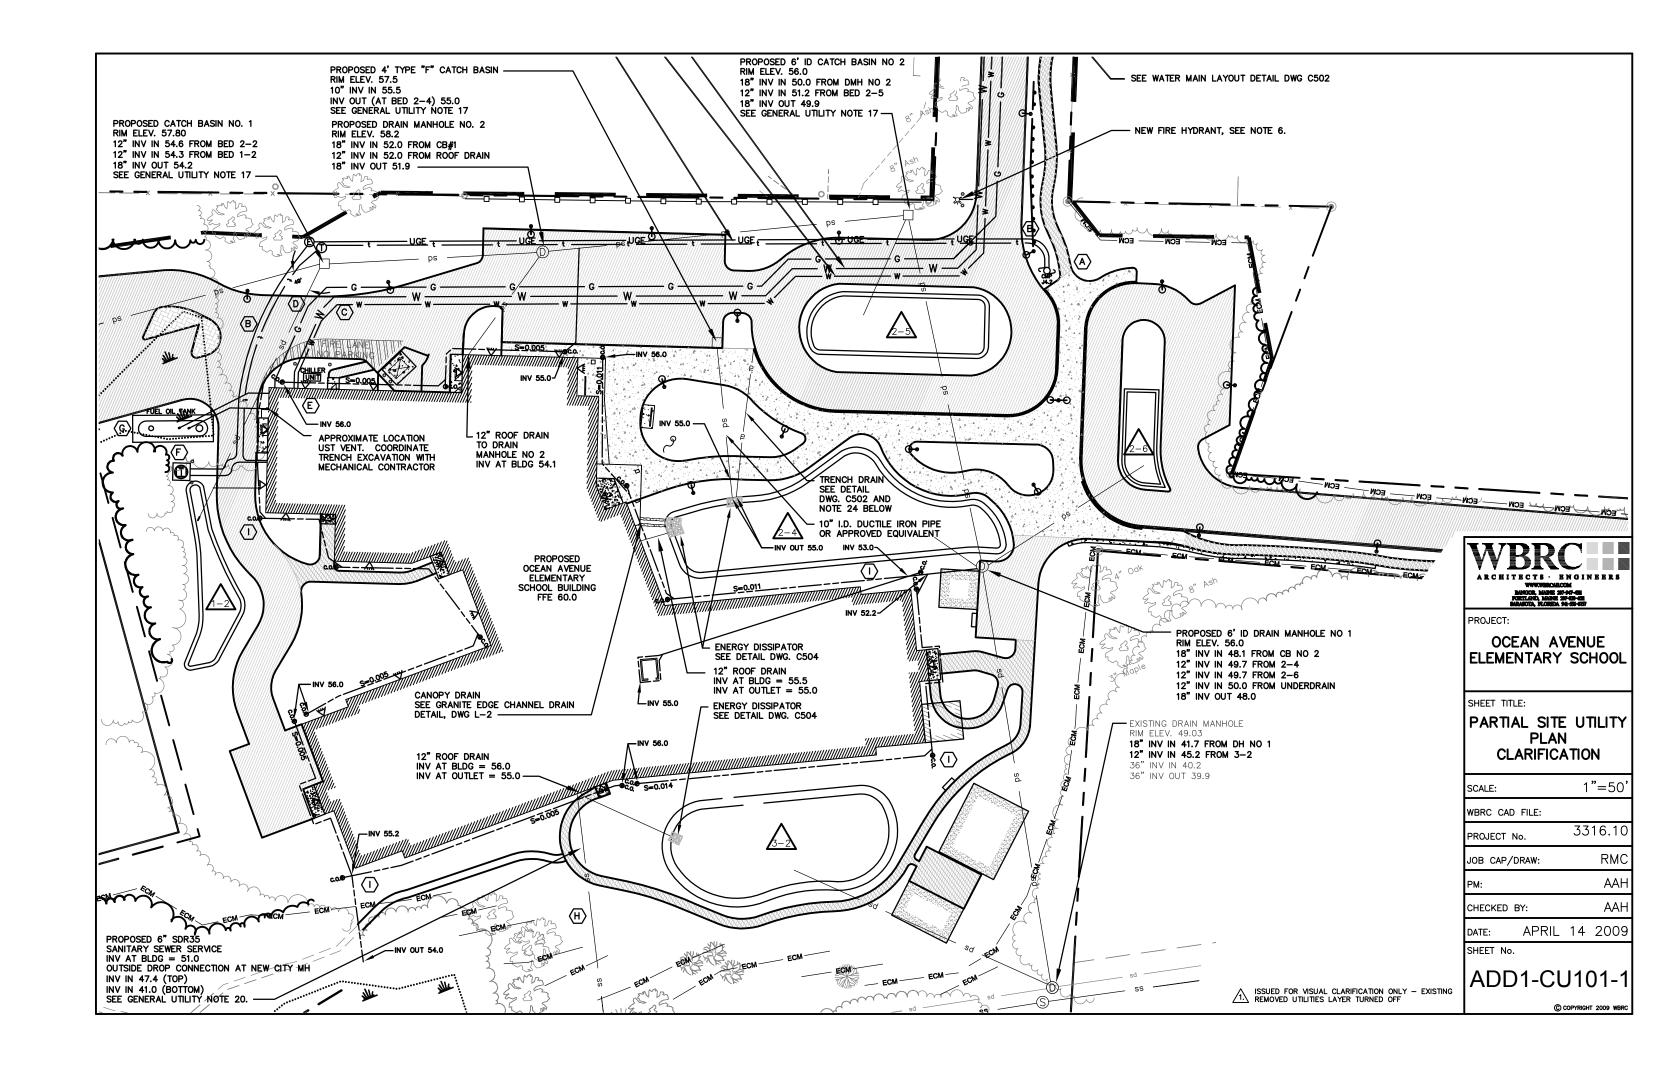

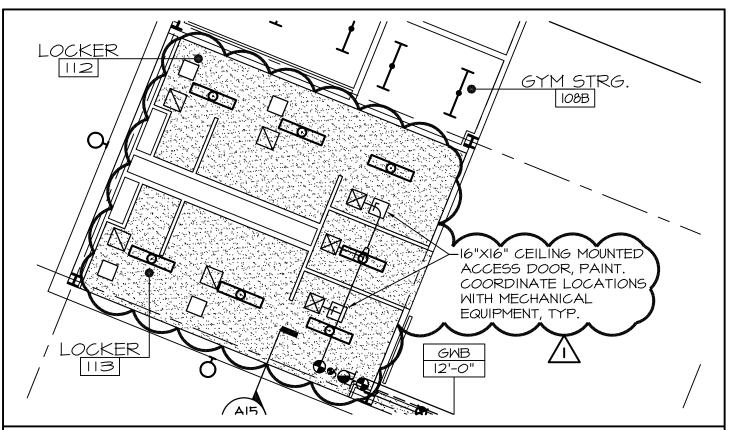

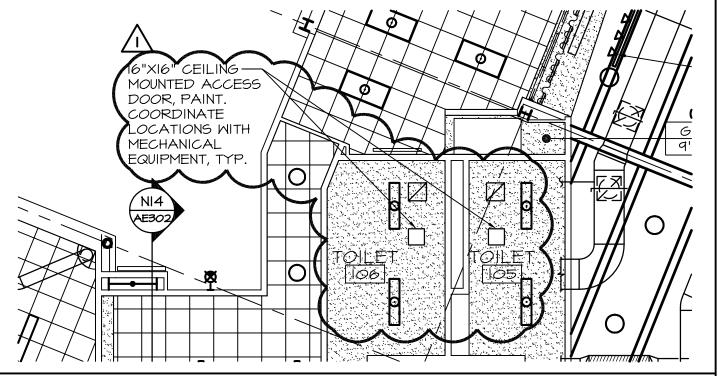

# PARTIAL PLAN

PROJECT:



BANGOR, MAINE 207-947-4511 PORTLAND, MAINE 207-828-4511 SARASOTA, FLORIDA 941-556-0757 WWW.WBRCAE.COM

WBRC CAD FILE:

331610 PROJECT No.

MEJ

SHEET No.

JOB CAP/DRAW: PM:

SCALE:

**TRJ** 

SCHOOL ADDENDUM #1

**OCEAN AVENUE ELEMENTARY** 


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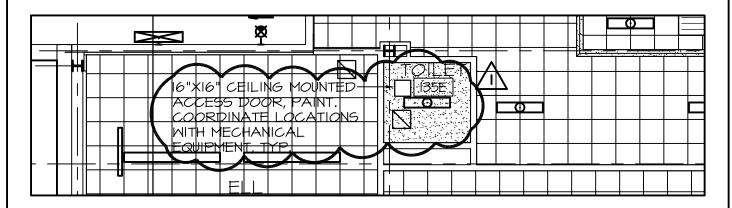
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1/8" = 1'-0"


SHEET TITLE:CEILING ACCESS DOORS ADDED

C COPYRIGHT 2009 WBRC



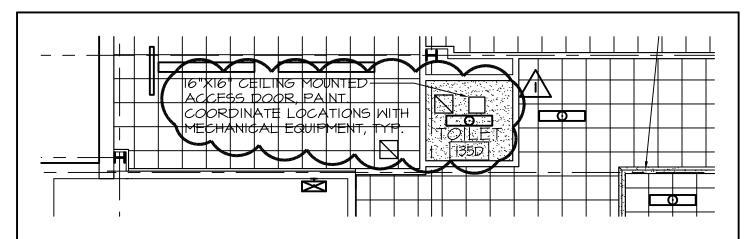

## PARTIAL PLAN

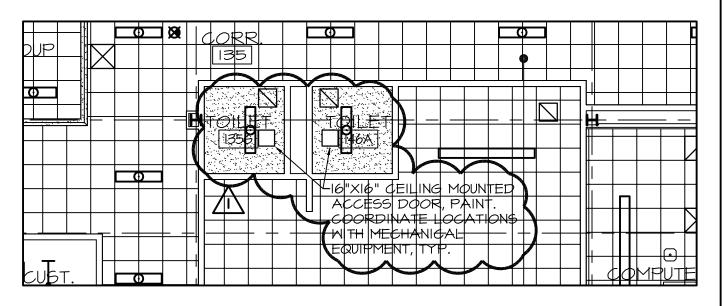

# PARTIAL PLAN

PROJECT:

SHEET TITLE:



BANGOR, MAINE 207-947-4511 PORTLAND, MAINE 207-829-4511 SARASOTA, FLORIDA 941-555-0757 WWW.WBRCAE.COM

WBRC CAD FILE:
PROJECT No. 331610

MEJ

SHEET No.

JOB CAP/DRAW:

SCALE:

PM:

TRJ

SCHOOL ADDENDUM #1

JEEL JOE

CHECKED BY: MEJ


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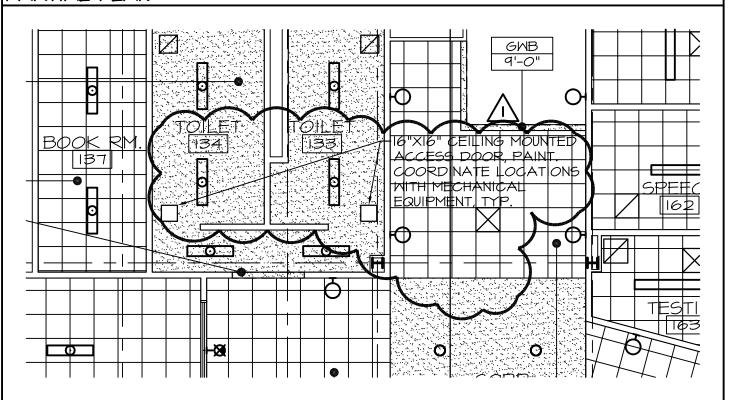
1/8" = 1'-0"

CEILING ACCESS DOORS ADDED AND DIFFUSER MOVED DATE: 04-14-2009

**OCEAN AVENUE ELEMENTARY** 

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# PARTIAL PLAN

SHEET TITLE:

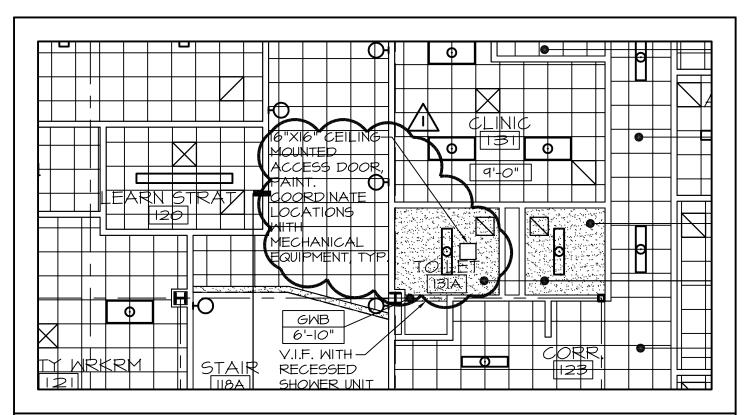

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1/8" = 1'-0"SCALE: WBRC CAD FILE:

MEJ

PROJECT No.

PM:

331610 **TRJ** 

**OCEAN AVENUE ELEMENTARY** 

SCHOOL ADDENDUM #1 PROJECT:

CEILING ACCESS DOORS ADDED AND DIFFUSER MOVED

CHECKED BY:


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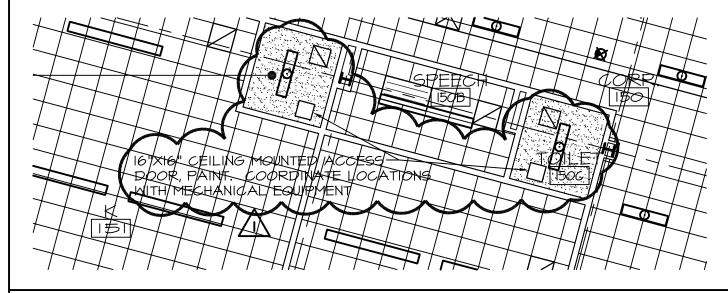
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SHEET No.

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## PARTIAL PLAN



# PARTIAL PLAN

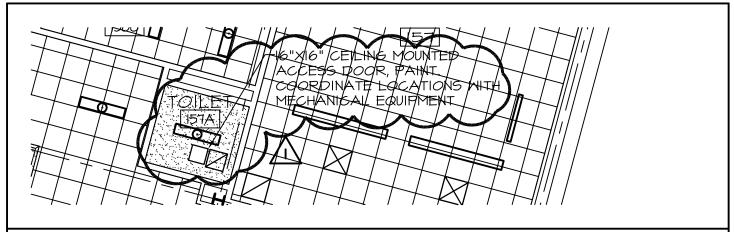

ARCHITECTS · ENGINEERS

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MEJ

28-451 WBRC CAD FILE: , FLORIDA

PM:

331610

SHEET No.

**OCEAN AVENUE ELEMENTARY** 

PROJECT: SCHOOL

ADDENDUM #1
SHEET TITLE:CEILING ACCESS DOORS ADDED

CHECKED BY: ME

MEJ ADD1-AE103-C-1


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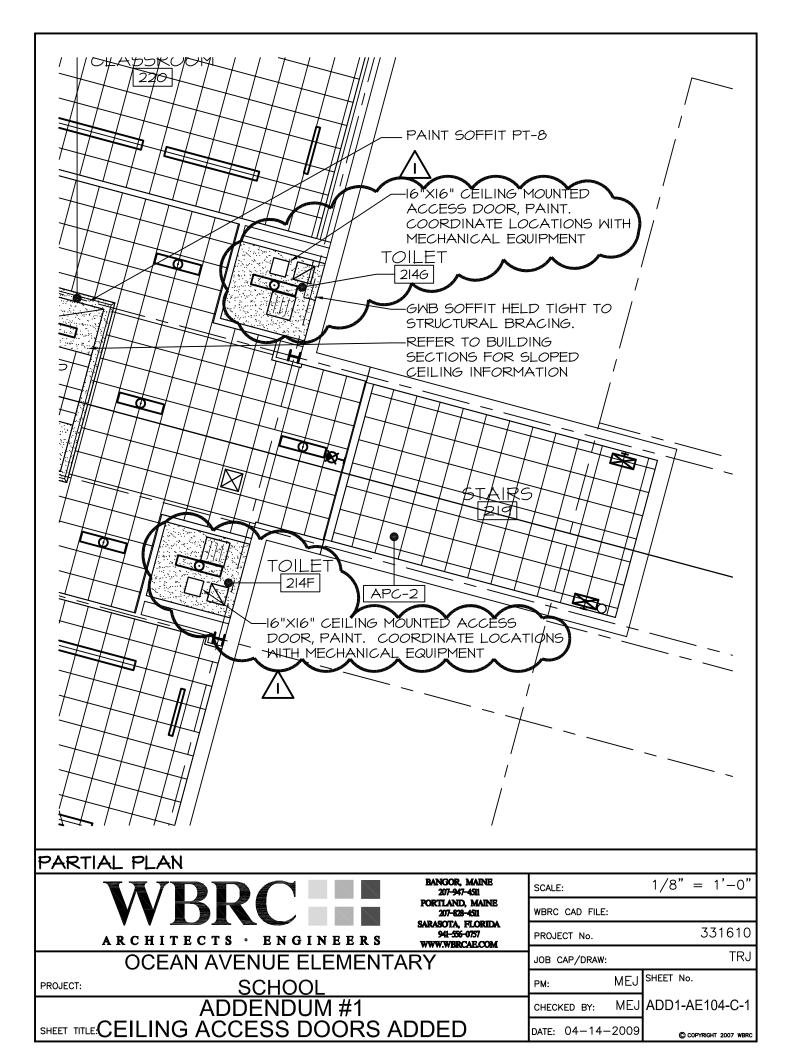
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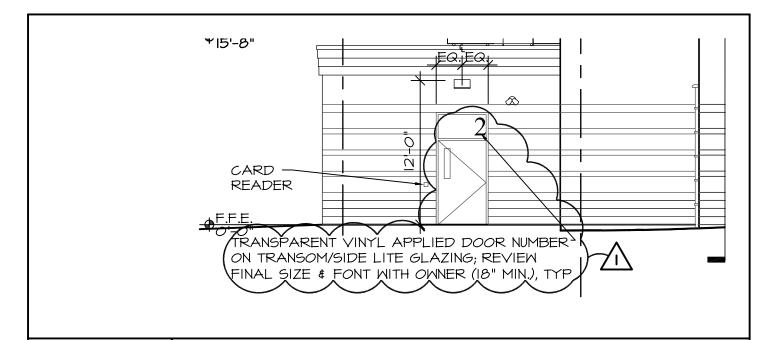
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**TRJ** 








# E | SEGMENT A WEST ELEVATION

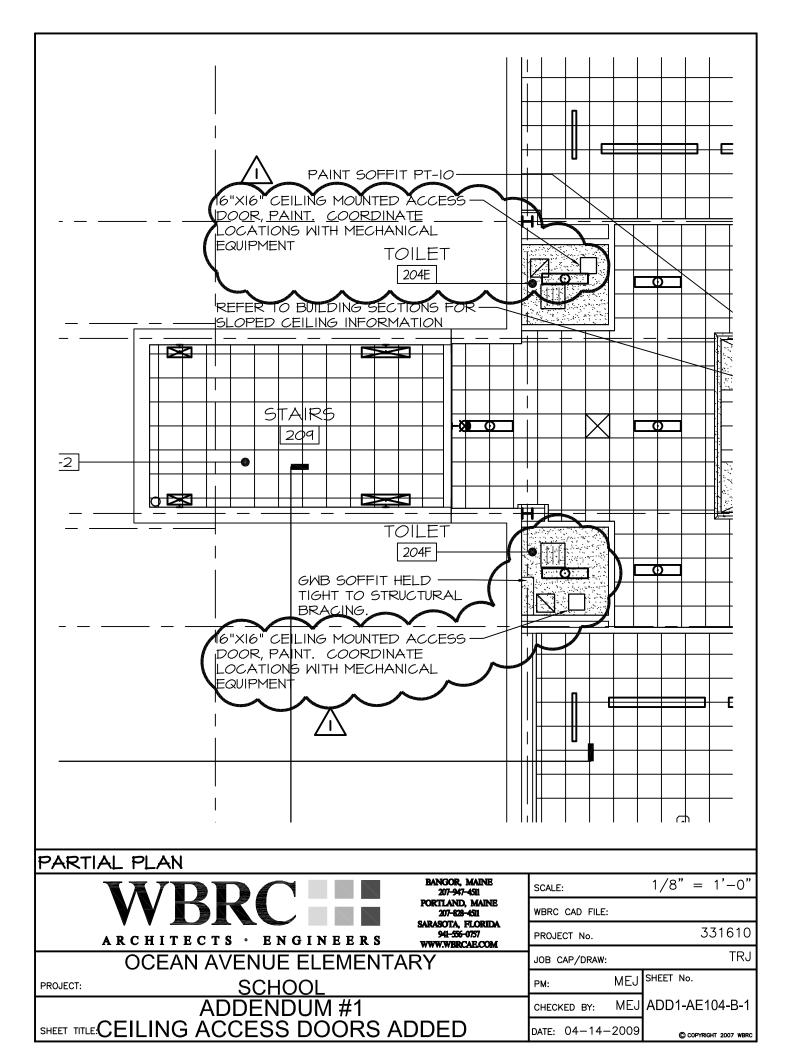1/8" = 1'-0"

AEIOI-A, AEIO2-A

(PARTIAL ELEVATION)

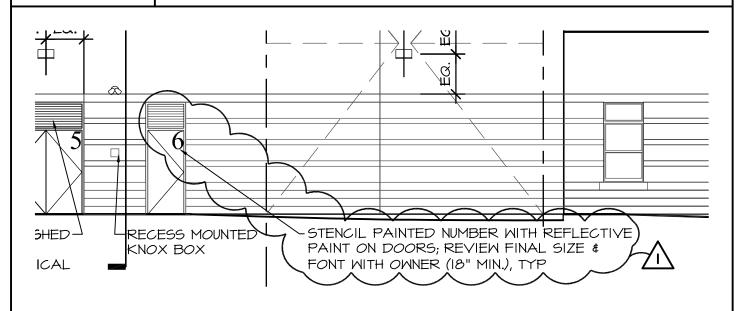

# EI SEGMENT A WEST ELEVATION

1/8" = 1'-0"

AEIOI-A, AEIO2-A

(PARTIAL ELEVATION)



BANGOR, MAINE 207-947-4511 PORTLAND, MAINE 207-829-4511 SARASOTA, FLORIDA 941-555-0757 WWW.WBRCAE.COM SCALE: 1/8" = 1'-0"WBRC CAD FILE: 3316.10

PROJECT No. MEJ

**OCEAN AVENUE ELEMENTARY** 

PROJECT:

SCHOOL ADDENDUM #1 NOTE REVISION PM: MEJ SHEET No.

CHECKED BY: MEJ ADD1-

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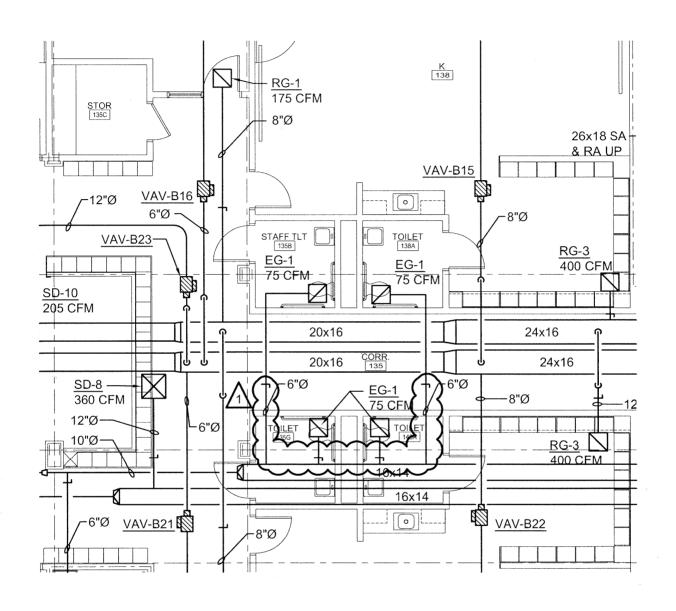
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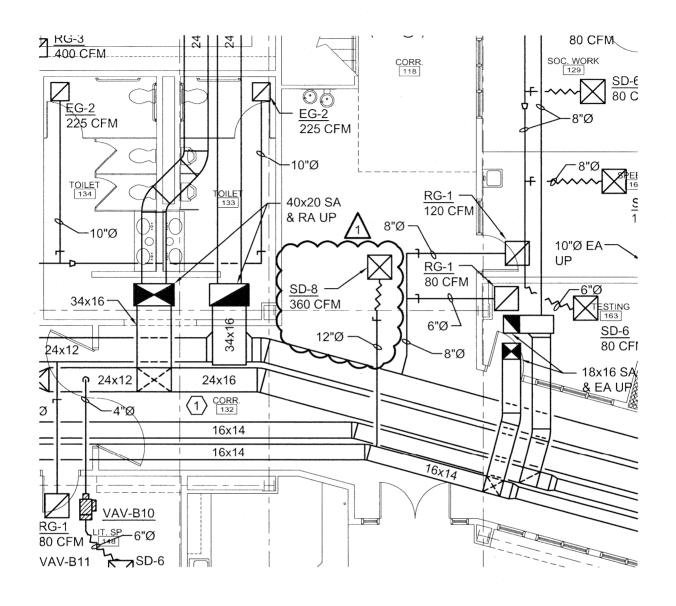
TRJ


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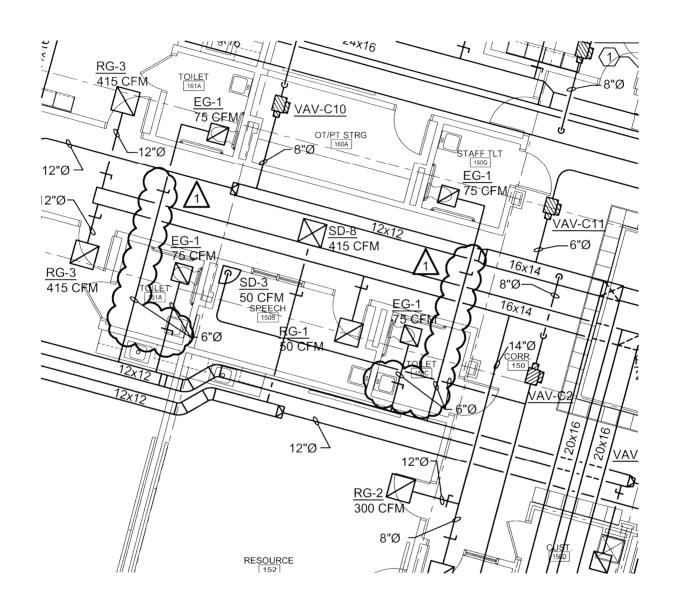
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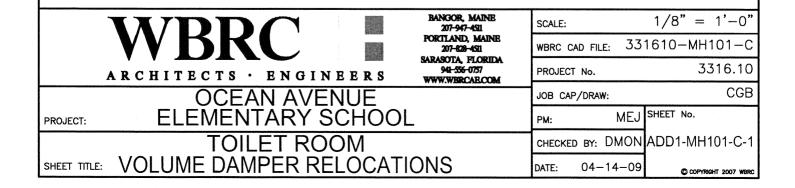











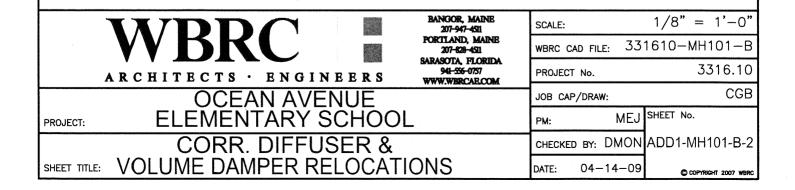

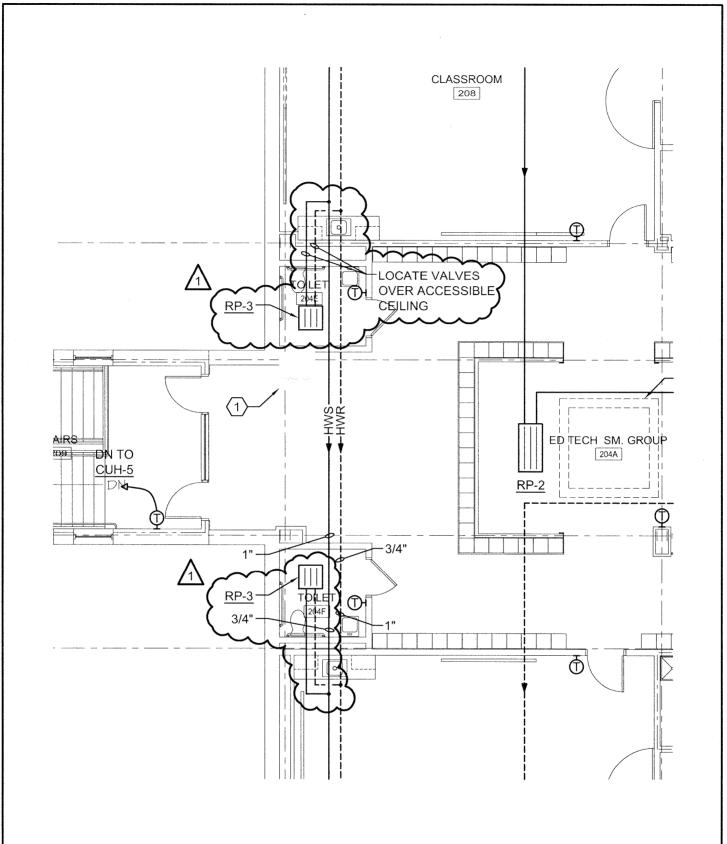



ARCHITECTS ENGINEERS

BANGOR, MAINE PORTLAND, MAINE 207-828-4511 SARASOTA, FLORIDA 941-556-0757 WWW.WBRCAR.COM

1/8" = 1'-0"331610-MP102-B

PROJECT No.

MEJ SHEET No.

JOB CAP/DRAW:

WBRC CAD FILE:

SCALE:

CGB

3316.10

CHECKED BY: DMON ADD1-MP102-B-1


04-14-09

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SHEET TITLE:

PROJECT:

RADIANT PANEL PIPING



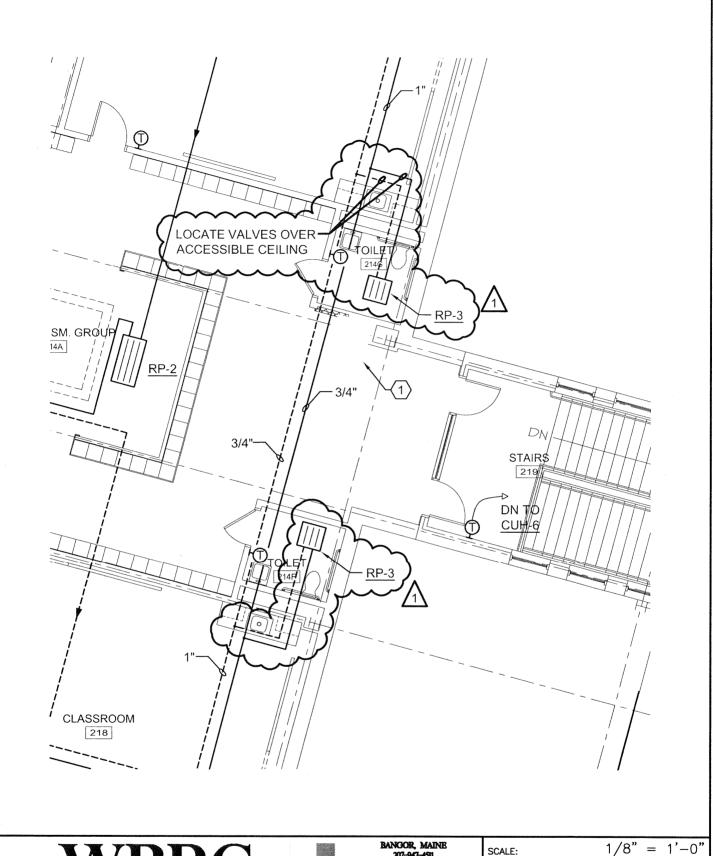



ARCHITECTS ENGINEERS

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1/8" = 1'-0"331610-MP102-C

3316.10 PROJECT No.

CGB JOB CAP/DRAW:

PROJECT:

RADIANT PANEL PIPING


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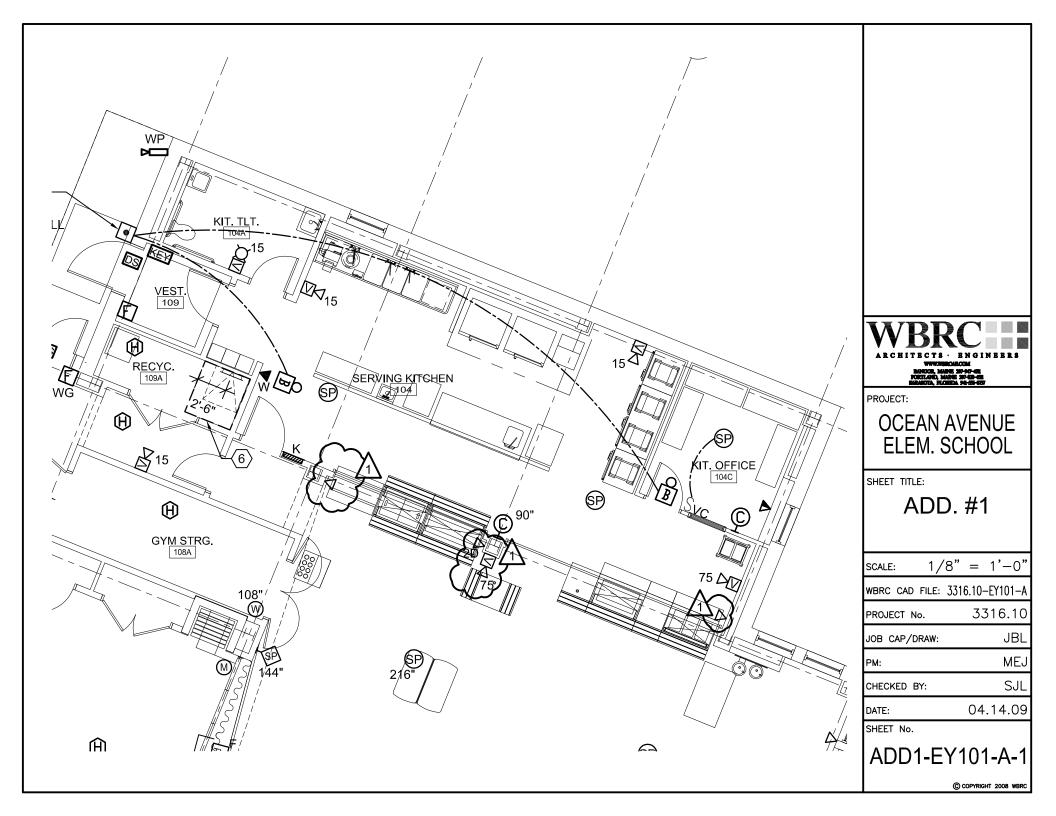
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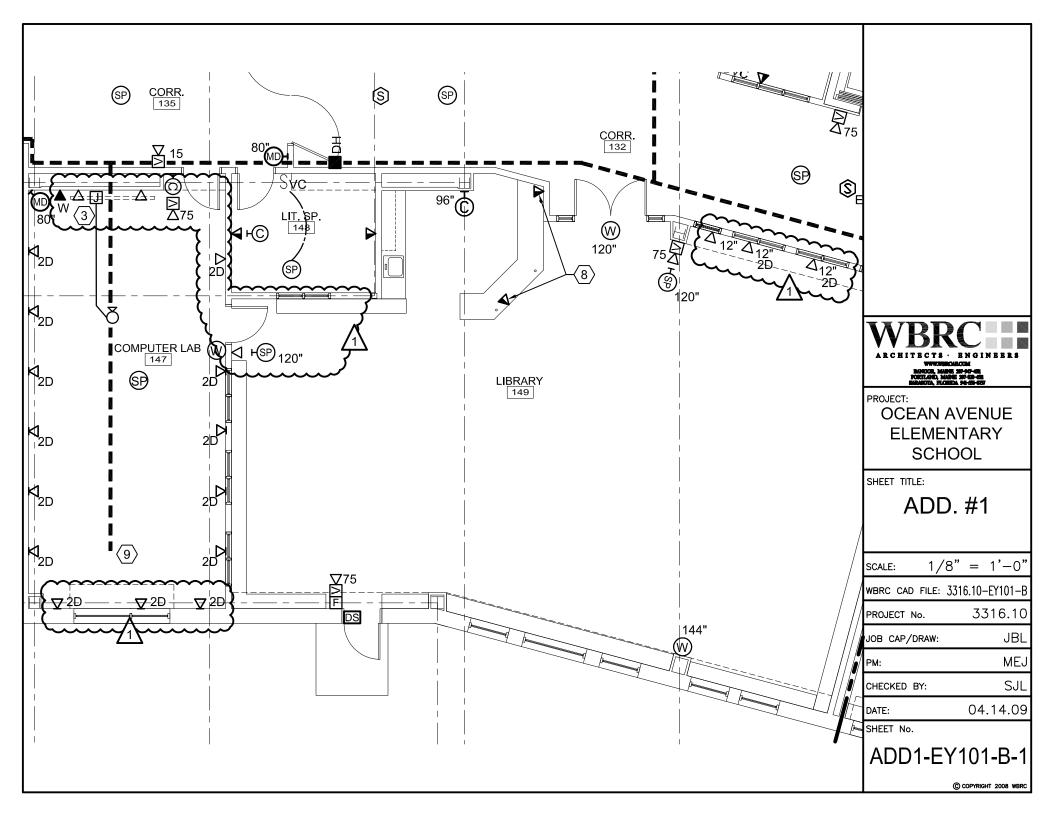
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SHEET TITLE:

DATE: 04-14-09





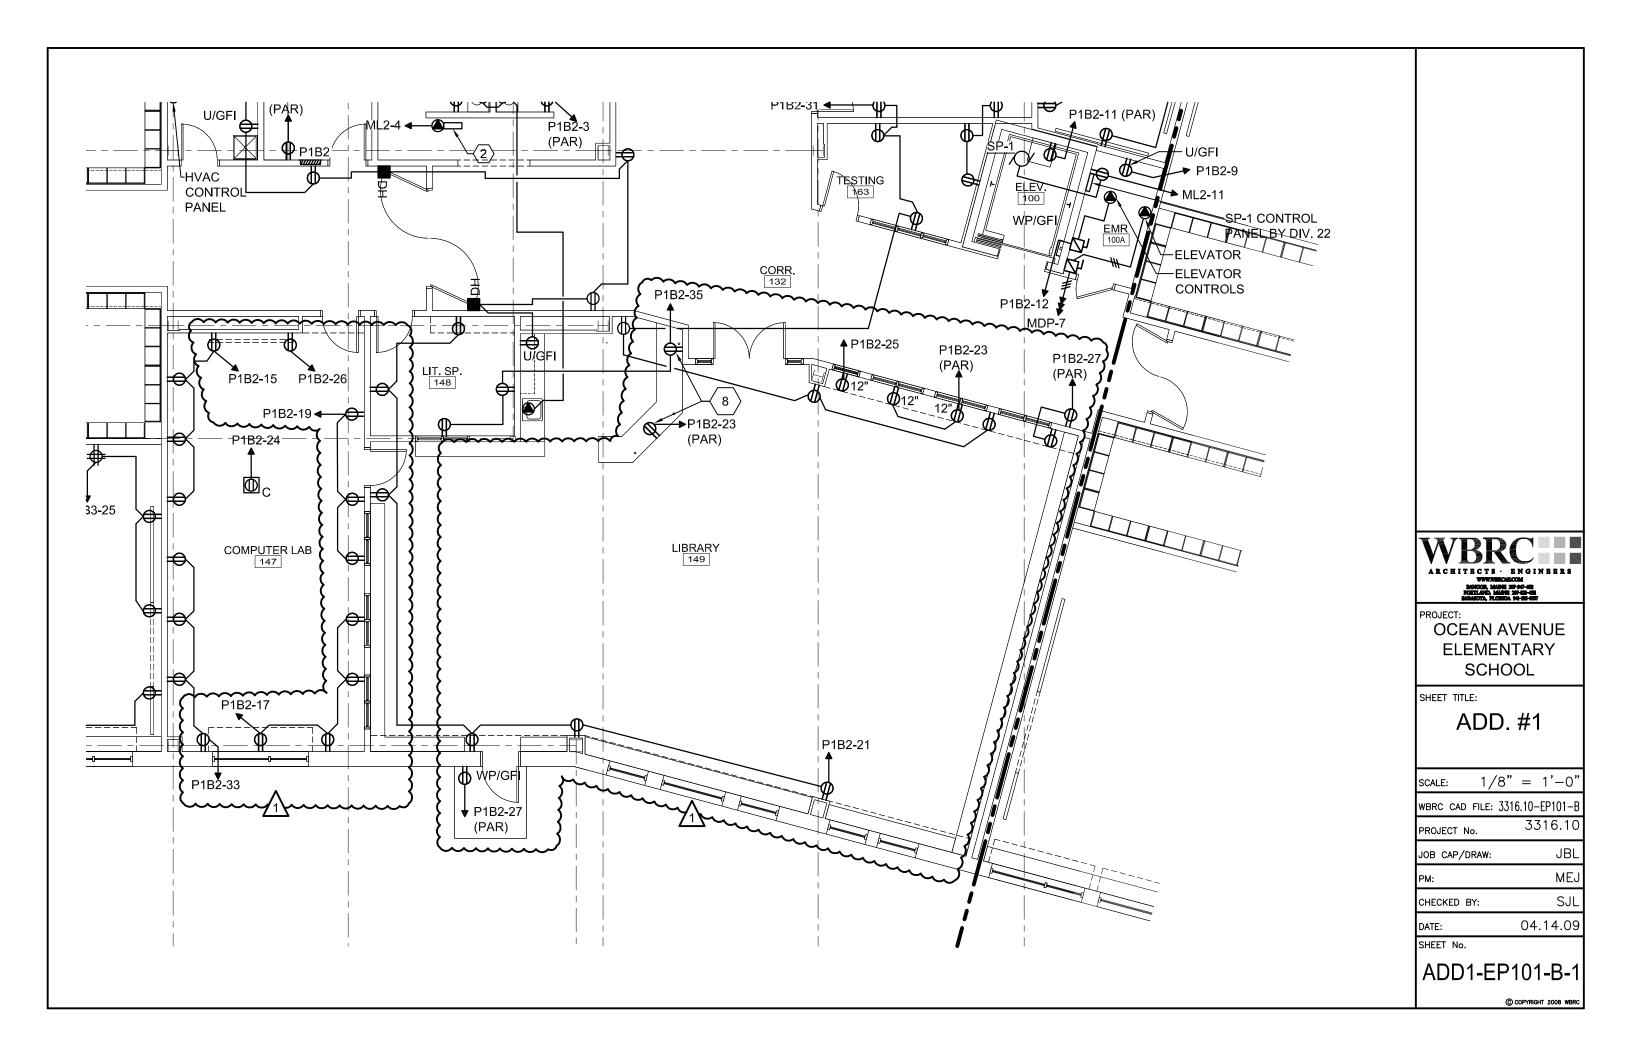

PANEL		P1B2	B2				LOCATION: CORR. 132			
VOLTAGE: 120/208V		PHASES: 3	WIRE: 4 TYPE: SQUARE D NQOD							
225A MLO		•	FED FROM: DPP							MOUNTING: FLUSH
SERVICE	KW	BRKR	NOTE	NO	PHASE	NO	NOTE	BRKR	KW	SERVICE
REC - FAC WKRM, LOUNGE	1.0	1P20		1	A	2		1P20	1.0	COPIER - FACULTY WORKROOM
REC - FAC LOUNGE, TLTS, CUST	1.4	1P20		3	В	4		1P20	1.0	COPIER - FACULTY WORKROOM
REC - SOC. WORK, CONF.	1.2	1P20		5	С	6		1P20	1.4	REFRIGERATOR - FAC LOUNGE
REC -CONF., TESTING, SPEECH	1.0	1P20		7	A	8		1P20	1.1	DISHWASHER - FAC LOUNGE
REC - ELEV. MACH. ROOM	0.2	1P20		9	В	10		1P20	1.0	MICROWAVE - FAC LOUNGE
REC & LIGHTS - ELEV. PIT	0.3	1P20		11	С	12		1P20	0.5	ELEVATOR CONTROLS
REC - CORR, TEST, SOC., FAC.	1.4	1P20		13	A	14		1P20	1.2	ELECTRIC WATER COOLER
REC -COMPUTER LAB	0.8	1P20		15	В	16		1P20	0.1	OBSERVATION AMPLIFIER - SOC WORK 127
REC - COMPUTER LAB.	0.8	1P20		17	С	18		1P20	1.0	FIRE ALARM EXTENDER- SEG B
REC - COMPUTER LAB.	0.6	1P20		19	A	20		1P20	1.6	REC LAPTOP CART - K 138
RÉC-LIBRARY, LÍT. SPÉC.	17.2^	1P20		21	В	22		1P20	0.2	FAUCET & FLUSH VALVE-TLT, LIBRARY
REC - LIBRARY	0.6	1P20		23	С	24		1P20	0.3	PROJECTOR - COMPUTER LAB
REC - LIBRARY PRINTER	1.0	1P20		25	A	26		1P20	1.5	REC - PRINTER - COMPUTER LAB
REC - EXT.,LIBRARY, CORR	0.6	1P20		27	В	28		1P20	0.2	FAUCET & FLUSH VALVE- K, TLT
REC - TEST, CONF, SOC. , CORR	1.2	1P20		29	С	30		1P20	0.8	REC K 146
REC-TEST SPEECH LIB LIT	12	1P20		31	A	32		1P20	0.8	REC K 138
REC - COMPUTER LAB	0.8	1P20		33	В	34		2P20		FLOOR SCRUBBER (FUTURE)
REC - LIBRARY, LIT. SPEC.	0.6	1P20		35	С	36				FLOOR SCRUBBER (FUTURE)
SPARE	<del>~~~</del>	1P20		37	A	38				SPACE
SPARE		1P20		39	В	40				SPACE
SPARE		1P20		41	С	42				SPACE



PROJECT:

OCEAN AVENUE ELEM. SCHOOL

SHEET TITLE:

ADD. #1

SCALE: N.T.S.

WBRC CAD FILE: 3316.10-E-601

PROJECT No. 3316.10

JOB CAP/DRAW: JBL

PM: MEJ
CHECKED BY: SJL

CHECKED BY: SJL DATE: 04.14.09

SHEET No.

ADD1-E-601-1

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