


**TECHNICAL NOTES:**

- 1 OBSERVATION MONITORING SYSTEM
- 2 TRANSFORMER FOR FAUCET & FLUSH VALVE

SENSORS SHALL BE MOUNTED ABOVE SUSPENDED CEILING OR IN UNFINISHED SPACE AS NOTED.

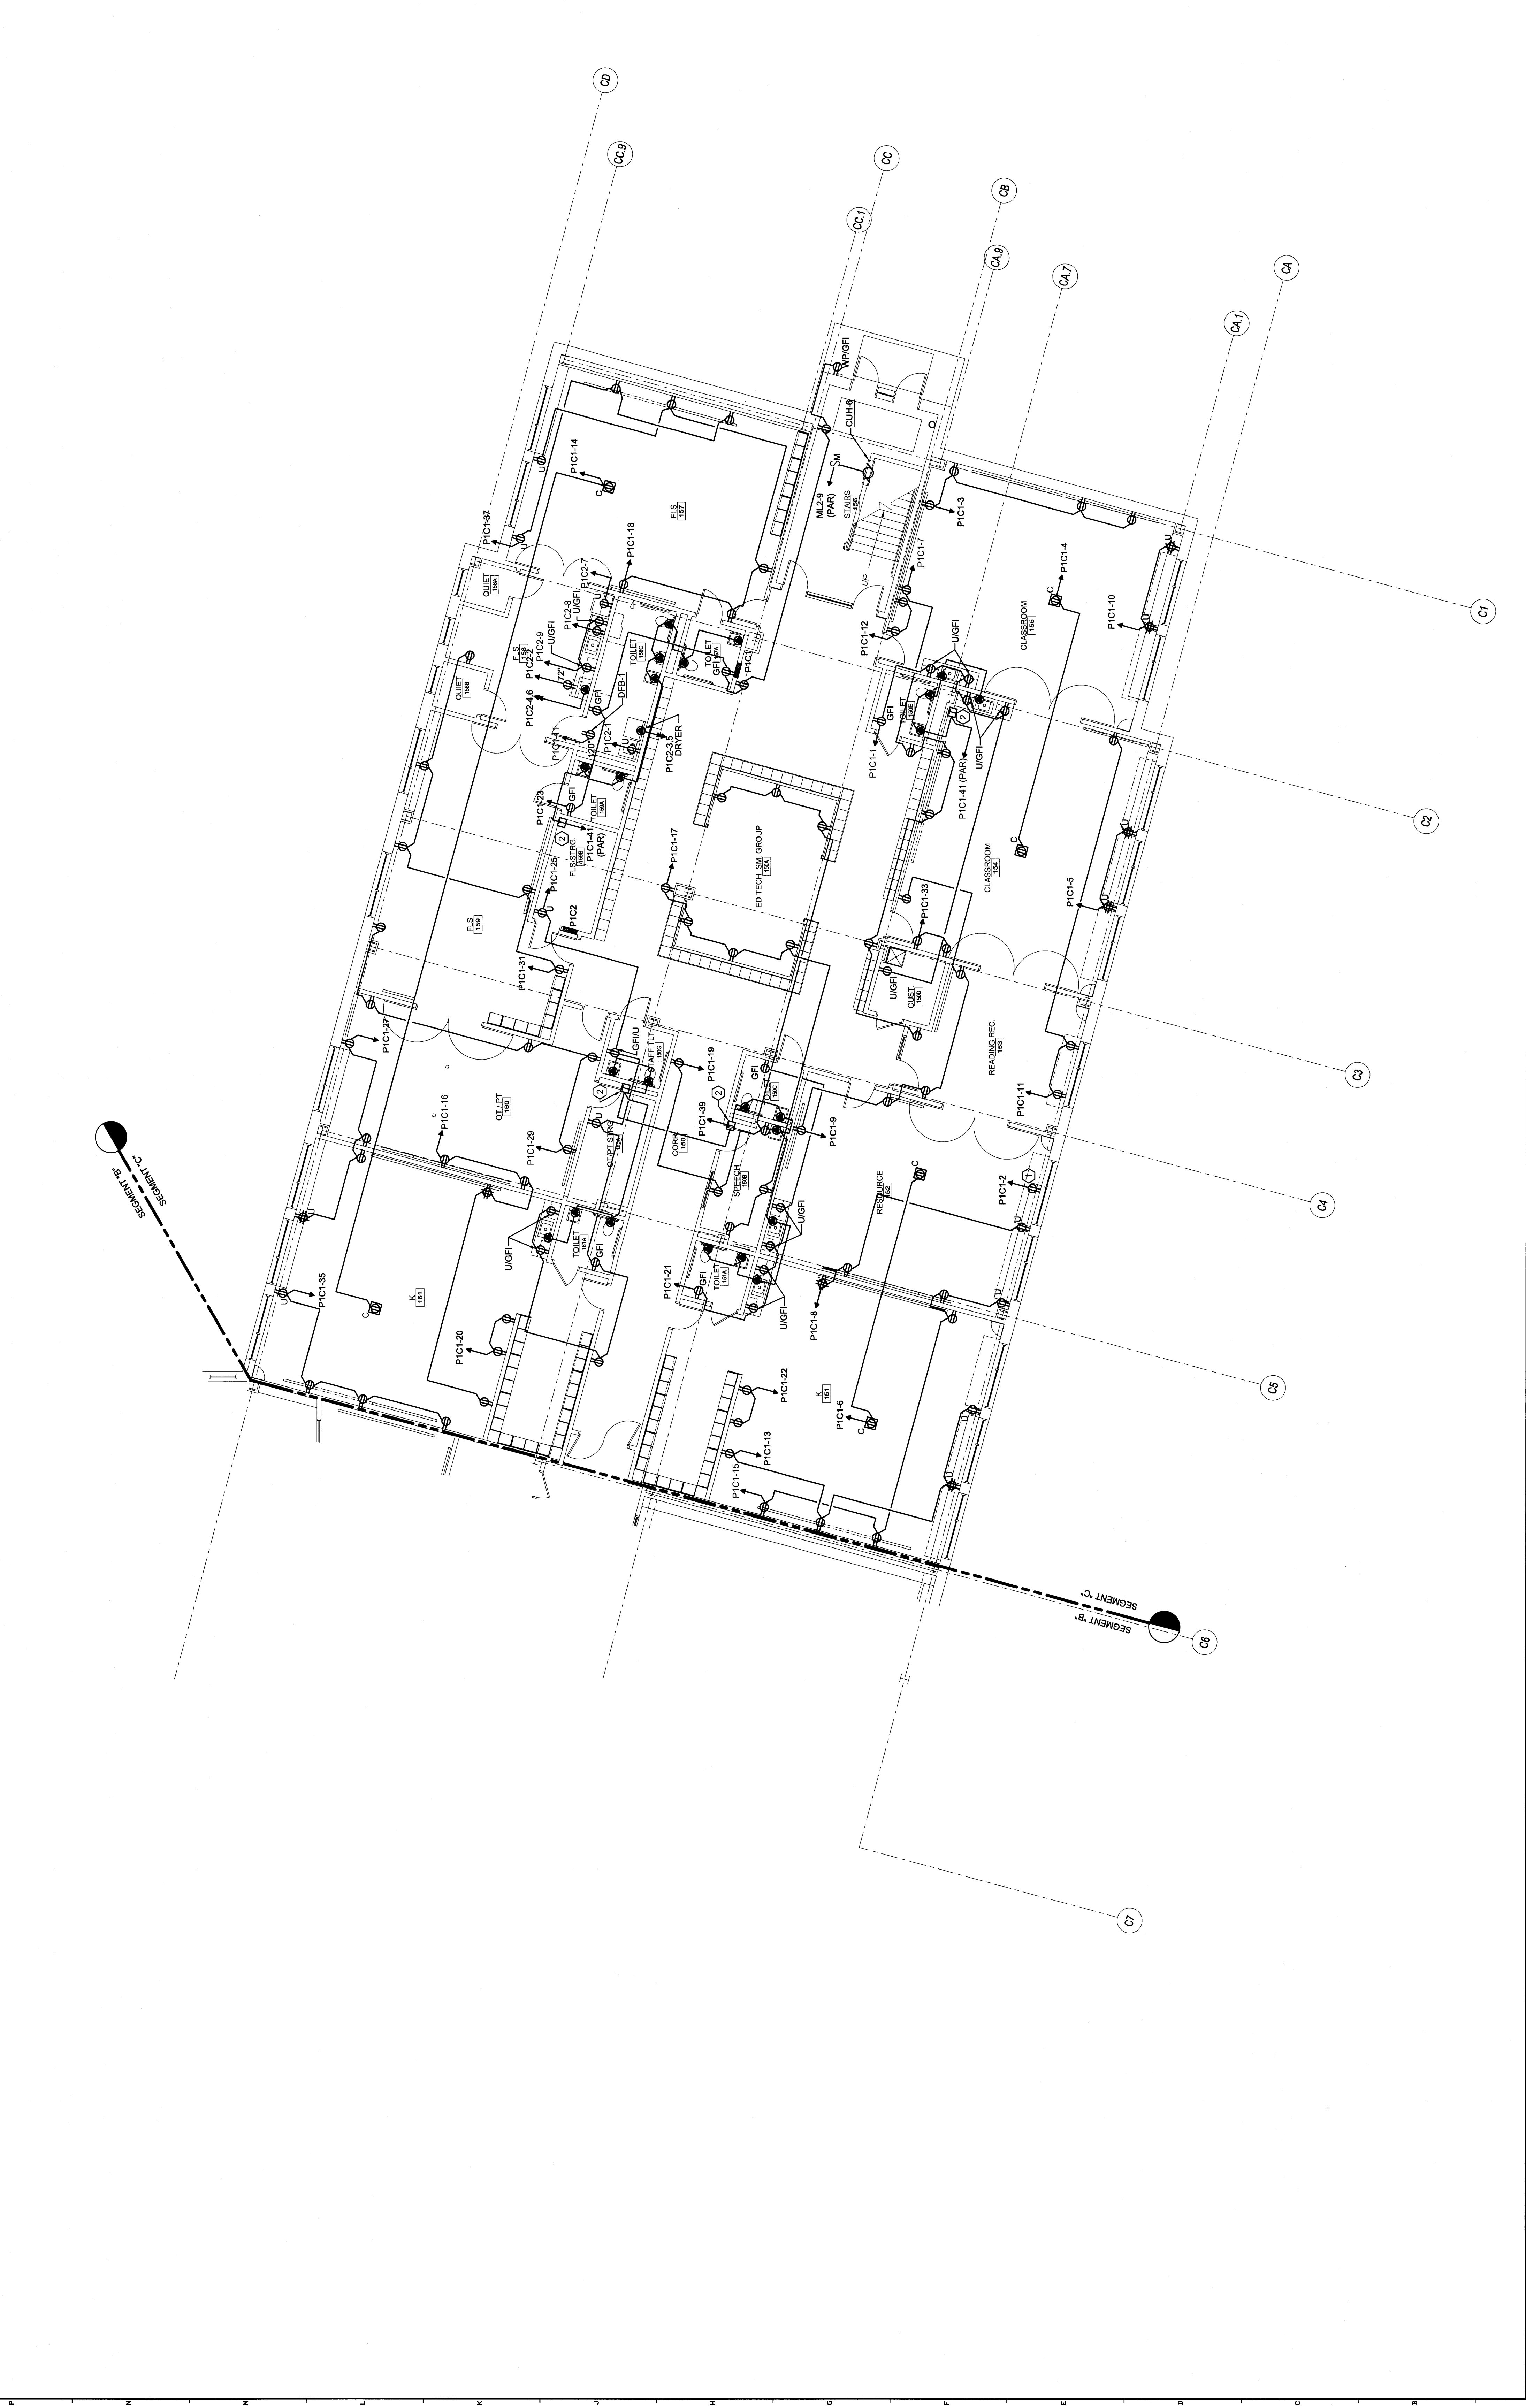

REV.	DESCRIPTION	DATE
0		03.03.09

**PERMIT APPLICATION  
SUBMISSION 3-18-09**

CURRENT ISSUE STATUS:

PROJECT NORTH

**WBRC**  
ARCHITECTS • ENGINEERS  
WWW.WBRC.COM  
100 WASHINGTON ST., SUITE 200  
PORTLAND, ME 04101-2000  
TEL: 603.763.4400  
FAX: 603.763.4401  
DP-11-P1

PROJECT: OCEAN AVENUE ELEMENTARY SCHOOL  
PORTLAND, ME

SHEET TITLE: FIRST FLOOR ELECTRICAL POWER PLAN - SEG. C

SHEET NO.	331610-EP101-C
SCALE	1/8" = 1'-0"
PROJECT MANAGER	MICJ
DRAWN BY	JBL
CHECKED BY	SJL

A1	FIRST FLOOR ELECTRICAL POWER PLAN - SEG. C
1/8" = 1'-0"	