
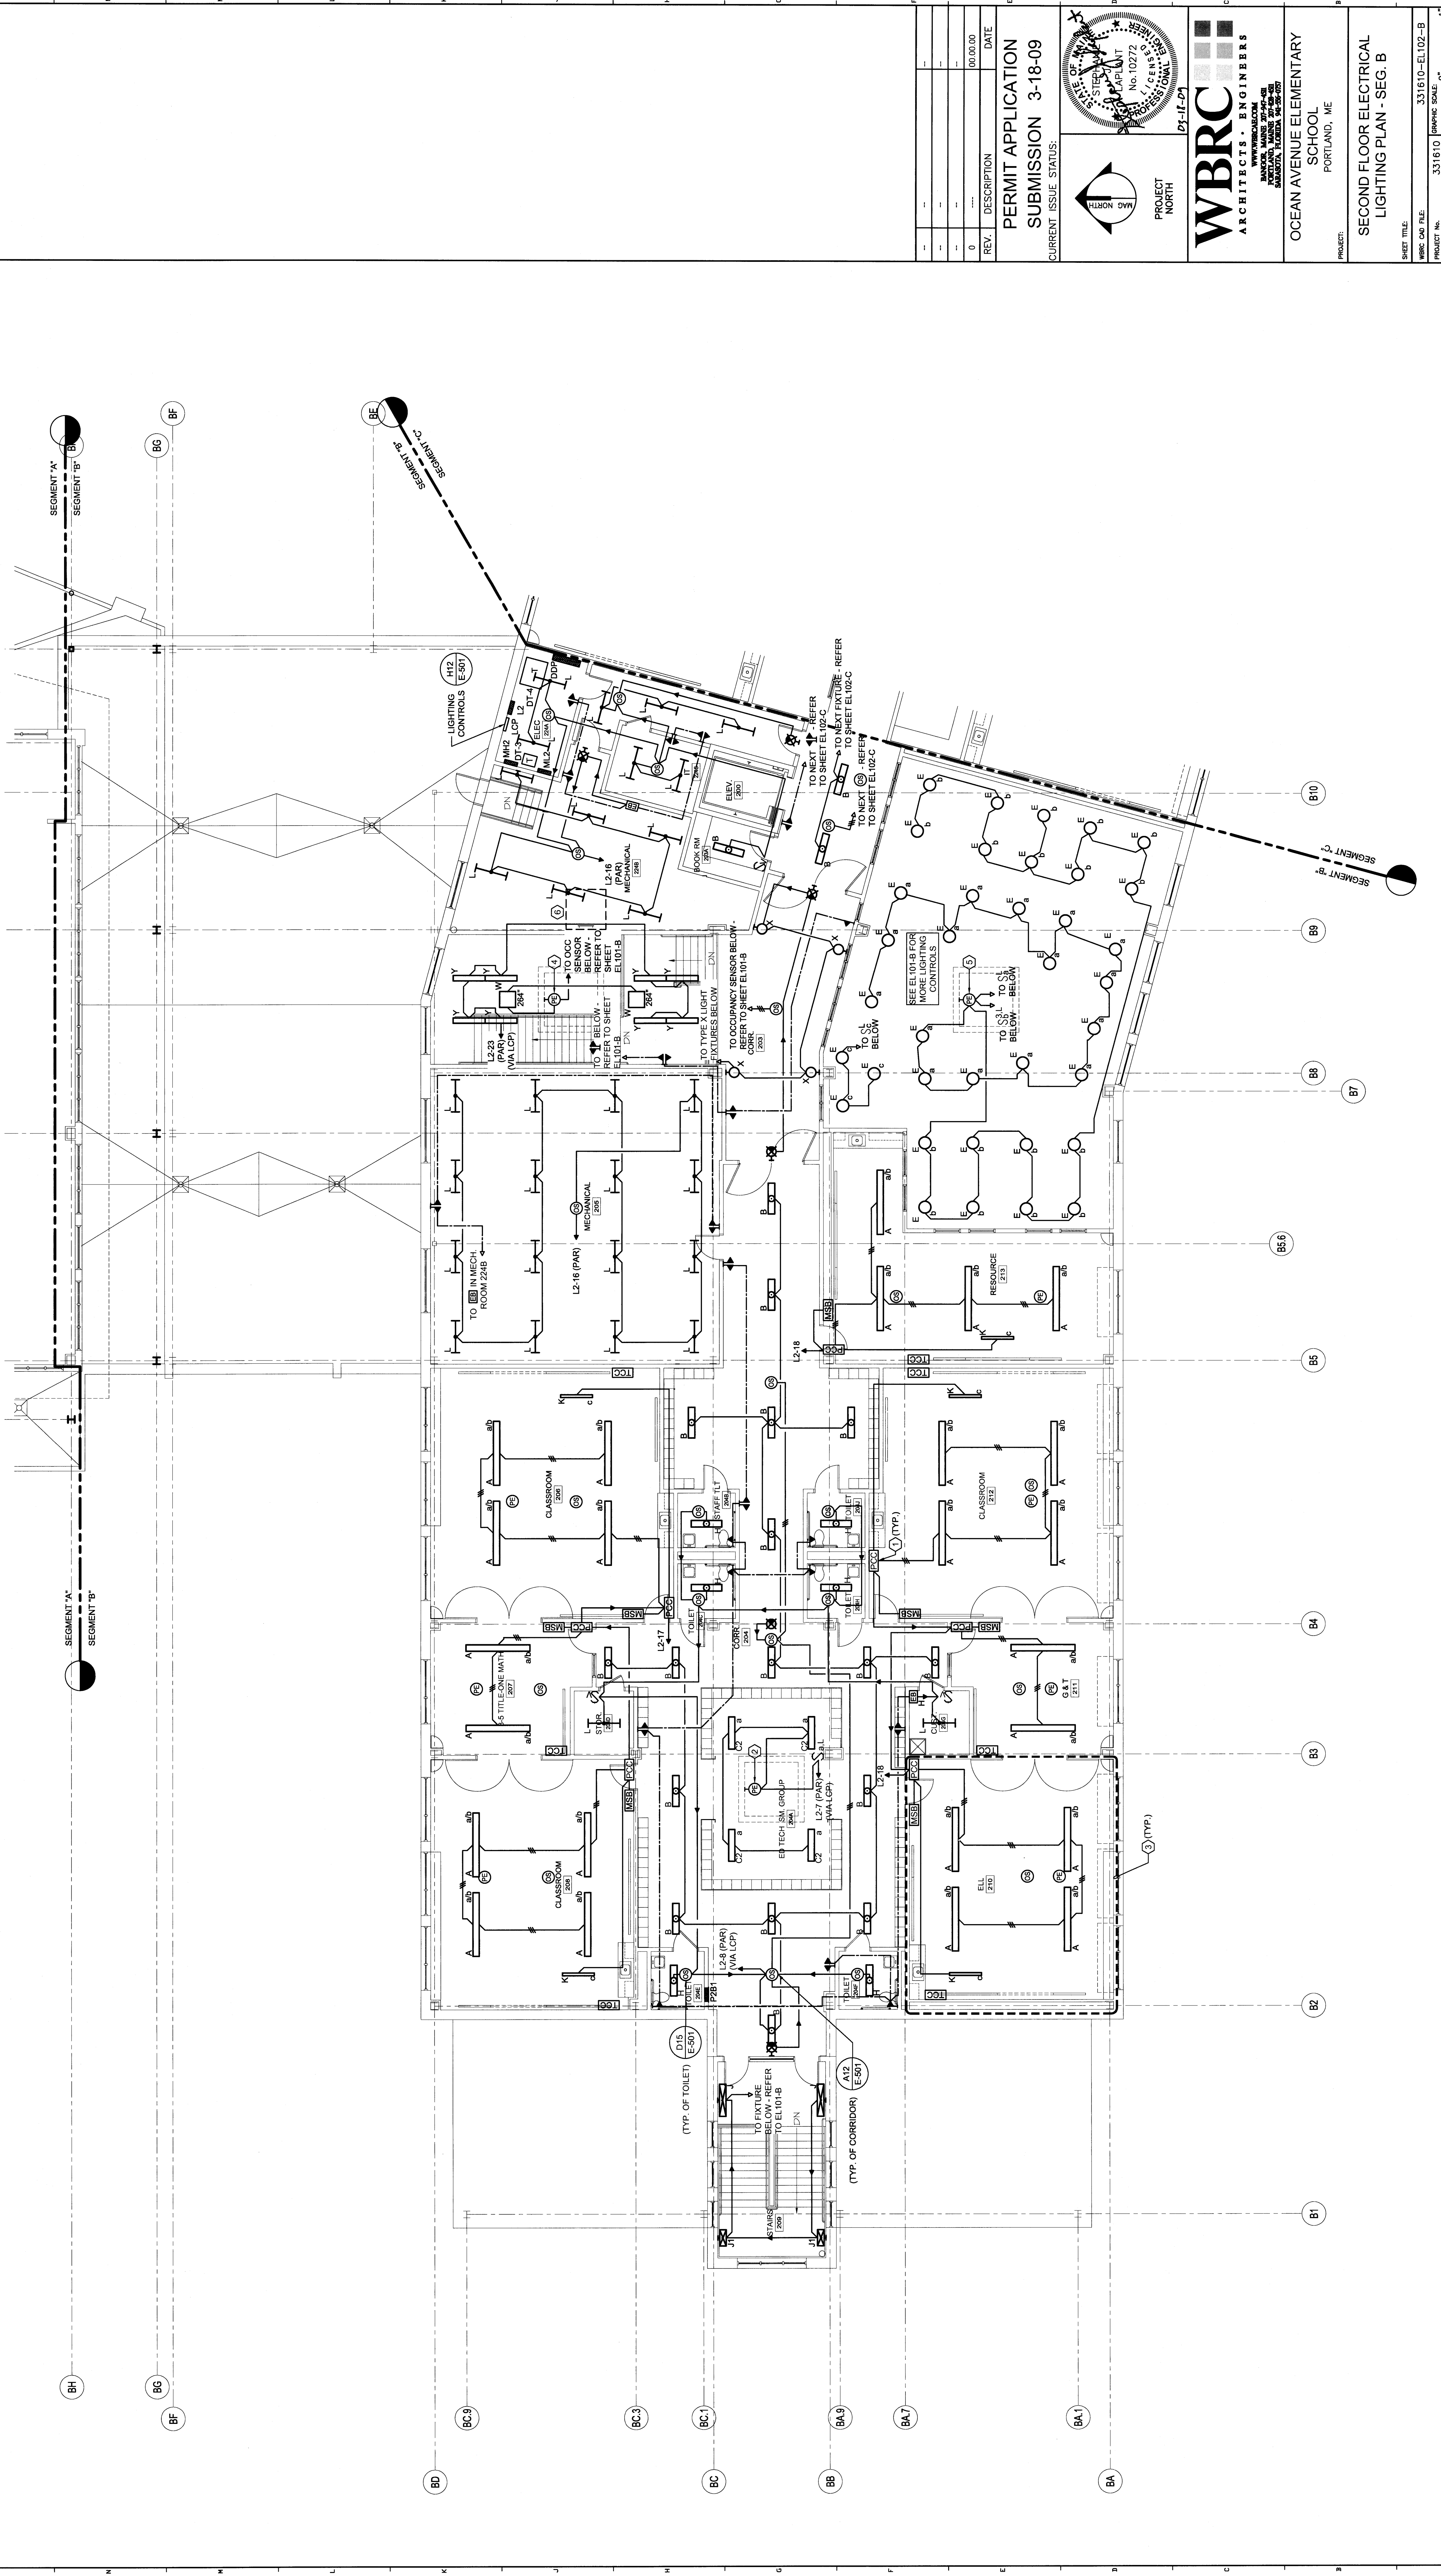


TECHNICAL NOTES:

- POWER CONTROL CENTER - MOUNT ABOVE SUSPENDED CEILING
- PHOTOCELL SHALL BE EQUAL TO HUBBELL CAT. # N8E-501 FOR ADDITIONAL WIRING INFORMATION FOR ADDITIONAL INFORMATION (TYP.)
- PLUS & MINUS CONNECTIONS NOT SHOWN FOR CLARITY PURPOSES REFER TO DETAIL A1E-501 FOR ADDITIONAL INFORMATION (TYP.)
- PHOTOCELL SHALL BE EQUAL TO HUBBELL CAT. # DLCP55. THIS DEVICE ONLY. SEE DETAIL N8E-503 FOR ADDITIONAL WIRING INFORMATION FOR ADDITIONAL INFORMATION (TYP.) THIS DEVICE SHALL BE CONTROLLED BY THIS PHOTOCELL.
- PHOTOCELL SHALL BE EQUAL TO HUBBELL CAT. # LUMSTAT1C. THIS DEVICE ONLY. SEE DETAIL J1E-501 FOR ADDITIONAL WIRING INFORMATION.
- 5 SQUARE CLEAN SPACE FOR ROOF HATCH DO NOT RUN PIPES, CONDUIT, ETC. FROM FLOOR TO ROOF DECK

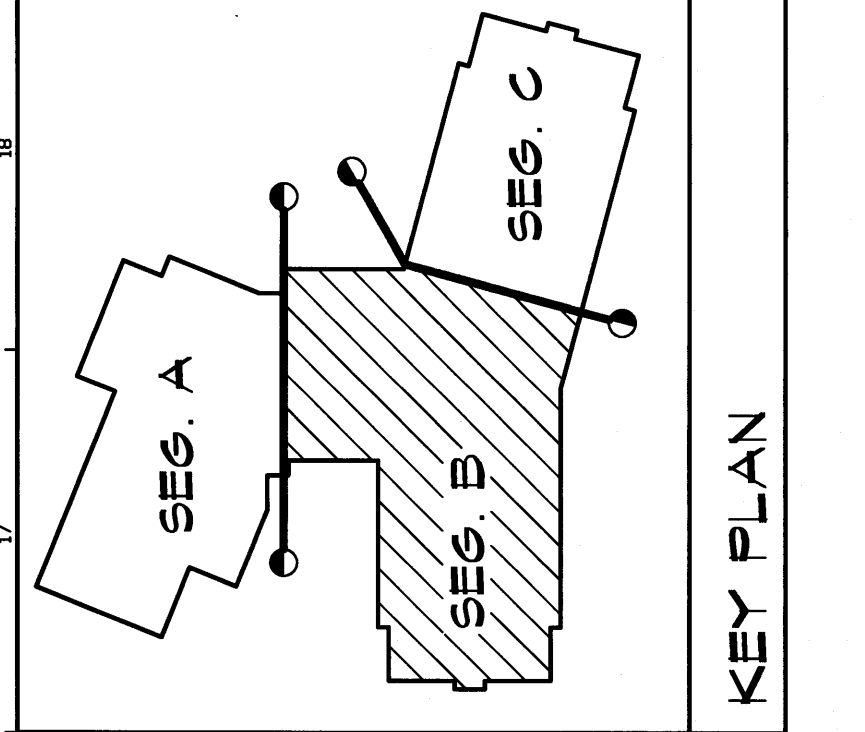

REV.	DESCRIPTION	DATE
0		06/09/09

PERMIT APPLICATION
SUBMISSION 3-18-09
 CURRENT ISSUE STATUS:



WBRC
 ARCHITECTS • ENGINEERS
 100 WATER STREET
 PORTLAND, ME 04101
 (207) 774-1171

OCEAN AVENUE ELEMENTARY SCHOOL
 PORTLAND, ME

SECOND FLOOR ELECTRICAL LIGHTING PLAN - SEG. B

SHEET FILE:	331610-EL102-B
PROJECT NO.:	331610
SCALE:	1/8" = 1'-0"
PROJECT MANAGER:	MEJ
DRAWN BY:	LJW
CHECKED BY:	SUL
SHEET NO.:	EL102-B

SECOND FLOOR ELECTRICAL LIGHTING PLAN - SEG. B

A1
 1/8" = 1'-0"