


J1	METAL GLAD WINDOW TYPES	1/4" = 1'-0"
J4	HOLLOW METAL WINDOW TYPES	1/4" = 1'-0"

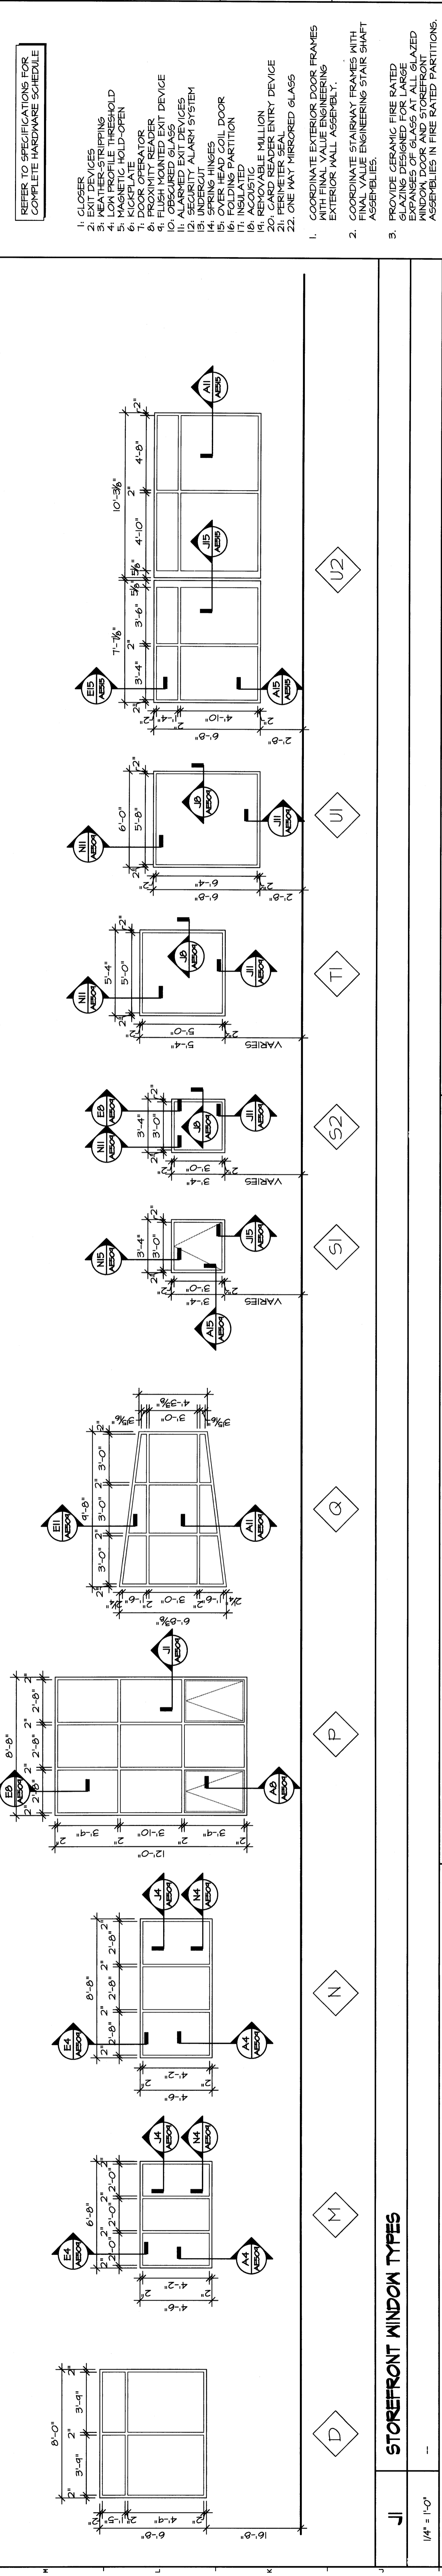


J1	STOREFRONT WINDOW TYPES	1/4" = 1'-0"
E1	HOLLOW METAL WINDOW TYPES	1/4" = 1'-0"
E7	STOREFRONT DOOR FRAME TYPES	1/4" = 1'-0"

- REFER TO SPECIFICATIONS FOR COMPLETE HARDWARE SCHEDULE.
- CLOSER
  - KEY PLACEMENT
  - KEY PROFILES
  - LOW PROFILE THRESHOLD
  - MAGNETIC HOLD-OPEN
  - DOOR OPERATOR
  - PROXIMITY READER
  - OBSCURED GLASS
  - ALARMED EXIT DEVICES
  - UNDERCUT ALARM SYSTEM
  - SPRING-HINGED
  - INSULATED
  - FOLDING PARTITION
  - COORDINATE EXTERIOR DOOR FRAMES WITH EXTERIOR WALL ASSEMBLY.
  - COORDINATE STAIRWAY FRAMES WITH FINISHABLE STAIRWAY ASSEMBLIES.
  - PROVIDE CERAMIC FIRE RATED GLAZING DESIGNED FOR LARGE SPANS OF GLASS AT ALL GLAZED PARTITIONS IN FIRE RATED PARTITIONS.
  - ALL EXTERIOR FRAME DIMENSIONS ARE MASONRY DIMENSIONS. CONTRACTOR TO VERIFY MASONRY OPENINGS IN FIELD.
  - REFER TO EXTERIOR ELEVATIONS FOR DOOR NUMBERS TO BE LOCATED ON DOORS. THE SAME CORRESPONDING NUMBER IS TO BE LOCATED ADJACENT EXTERIOR DOOR AT THE INTERIOR SIDE OF THE OPENING.

HATCHED AREA TO BE ASBESTOS PANELS THICKNESS TO BE SUCH THAT IT FITS SNUGLY INSIDE OF HOLLOW METAL FRAME TYP.

HATCHED AREA TO BE ASBESTOS PANELS THICKNESS TO BE SUCH THAT IT FITS SNUGLY INSIDE OF HOLLOW METAL FRAME TYP.

PERMIT APPLICATION  
SUBMISSION 3-18-09  
CURRENT ISSUE STATUS:

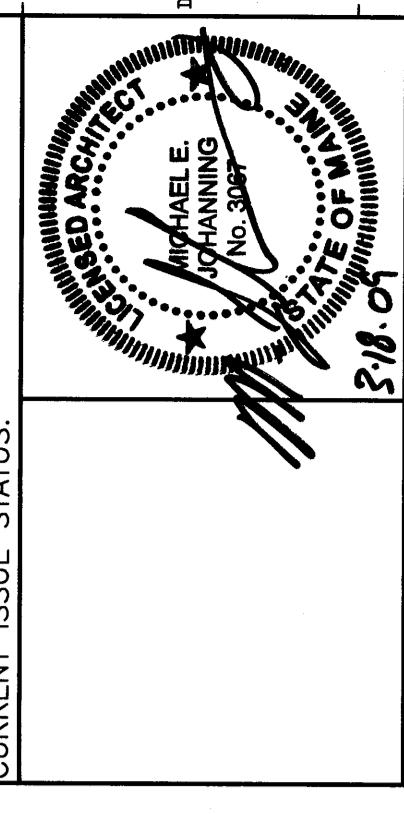

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OCEAN AVENUE ELEMENTARY SCHOOL  
PORTLAND, ME

PROJECT: DOOR FRAME AND WINDOW TYPES

SHEET TITLE: 331610-01-01  
PROJECT NO.: 331610  
SCALE: AS NOTED  
DATE: 03/03/09

DESIGNED BY: MEJ  
CHECKED BY: MEJ

PROJECT NUMBER: AE602