


GENERAL CEILING PLAN NOTES:


1. REFER TO SHEET G1002 FOR ALL ABBREVIATIONS.
2. CONTRACTORS TO VERIFY LOCATION OF MAIN STRUCTURAL BEAMS PRIOR TO CEILING REFLECTED CEILING INSTALLATION. NOTIFY ARCHITECT OF INTERFERENCES.
3. NOTIFY ARCHITECT OF ANY DISCREPANCIES BETWEEN ARCHITECTURAL REFLECTED CEILING AND ELECTRICAL LIGHTING PLANS PRIOR TO CONSTRUCTION.
4. REFER TO ELECTRICAL PLANS FOR LOCATIONS OF STROBES AND EXIT SIGNS.
5. ALL CEILING GRILLES, TRIM EDGES, AND SLOOT DIFFUSERS TO MATCH ADJACENT CEILING COLOR, FINISH, AND MATERIALS.
6. ALL SPRINKLER HEADS TO OCCUR AT CENTER OF TILES.
7. LAYOUT TILES AS SHOWN IN REFLECTED CEILING PLANS.
8. REFER TO SPECIFICATION SECTION 09811 FOR ALL ACOUSTICAL PANEL CEILING TYPES.
9. ALL CEILINGS TO BE 9'-6" A.F.F. U.N.O.
10. WHERE NO CEILING MATERIAL IS SHOWN THE STRUCTURE ABOVE IS TO BE EXPOSED, U.N.O.
11. SEE EL SHEETS FOR CONTINUED LIGHTING INFORMATION.
12. SEE ME SHEETS FOR CONTINUED MECHANICAL INFORMATION.
13. ALL APC IS APC-1 U.N.O.

CEILING LEGEND:

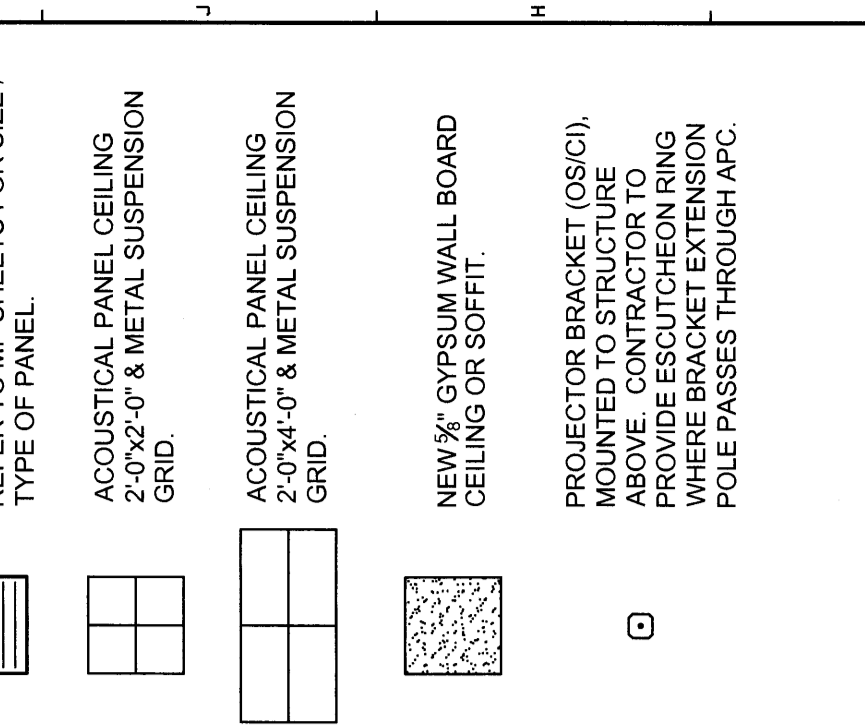

REV.	DESCRIPTION	DATE
0		00.00.00

PERMIT APPLICATION
SUBMISSION 3-18-09
 CURRENT ISSUE STATUS:

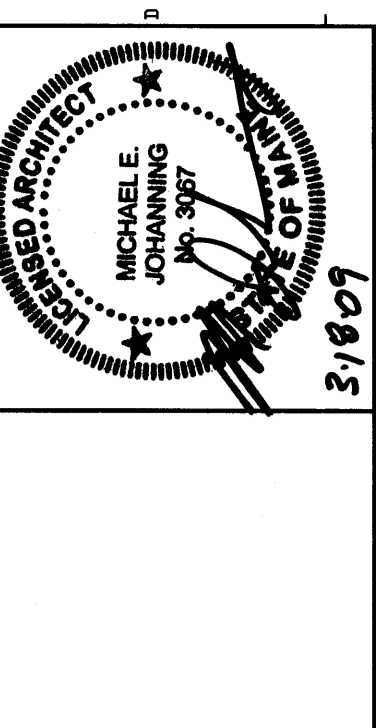


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3/18/09

OCEAN AVENUE ELEMENTARY SCHOOL
 PORTLAND, ME

SECOND FLOOR REFLECTED CEILING PLAN SEG. B

SHEET TITLE:	331610	DRAWING SCALE:	1" = 12'
WBRC CAD FILE:			
PROJECT NO.:		AS NOTED	
PROJECT MANAGER:	MEJ		
DRAWN BY:	RJD		
CHECKED BY:	MEJ		
SHEET NO.		AE104-B	

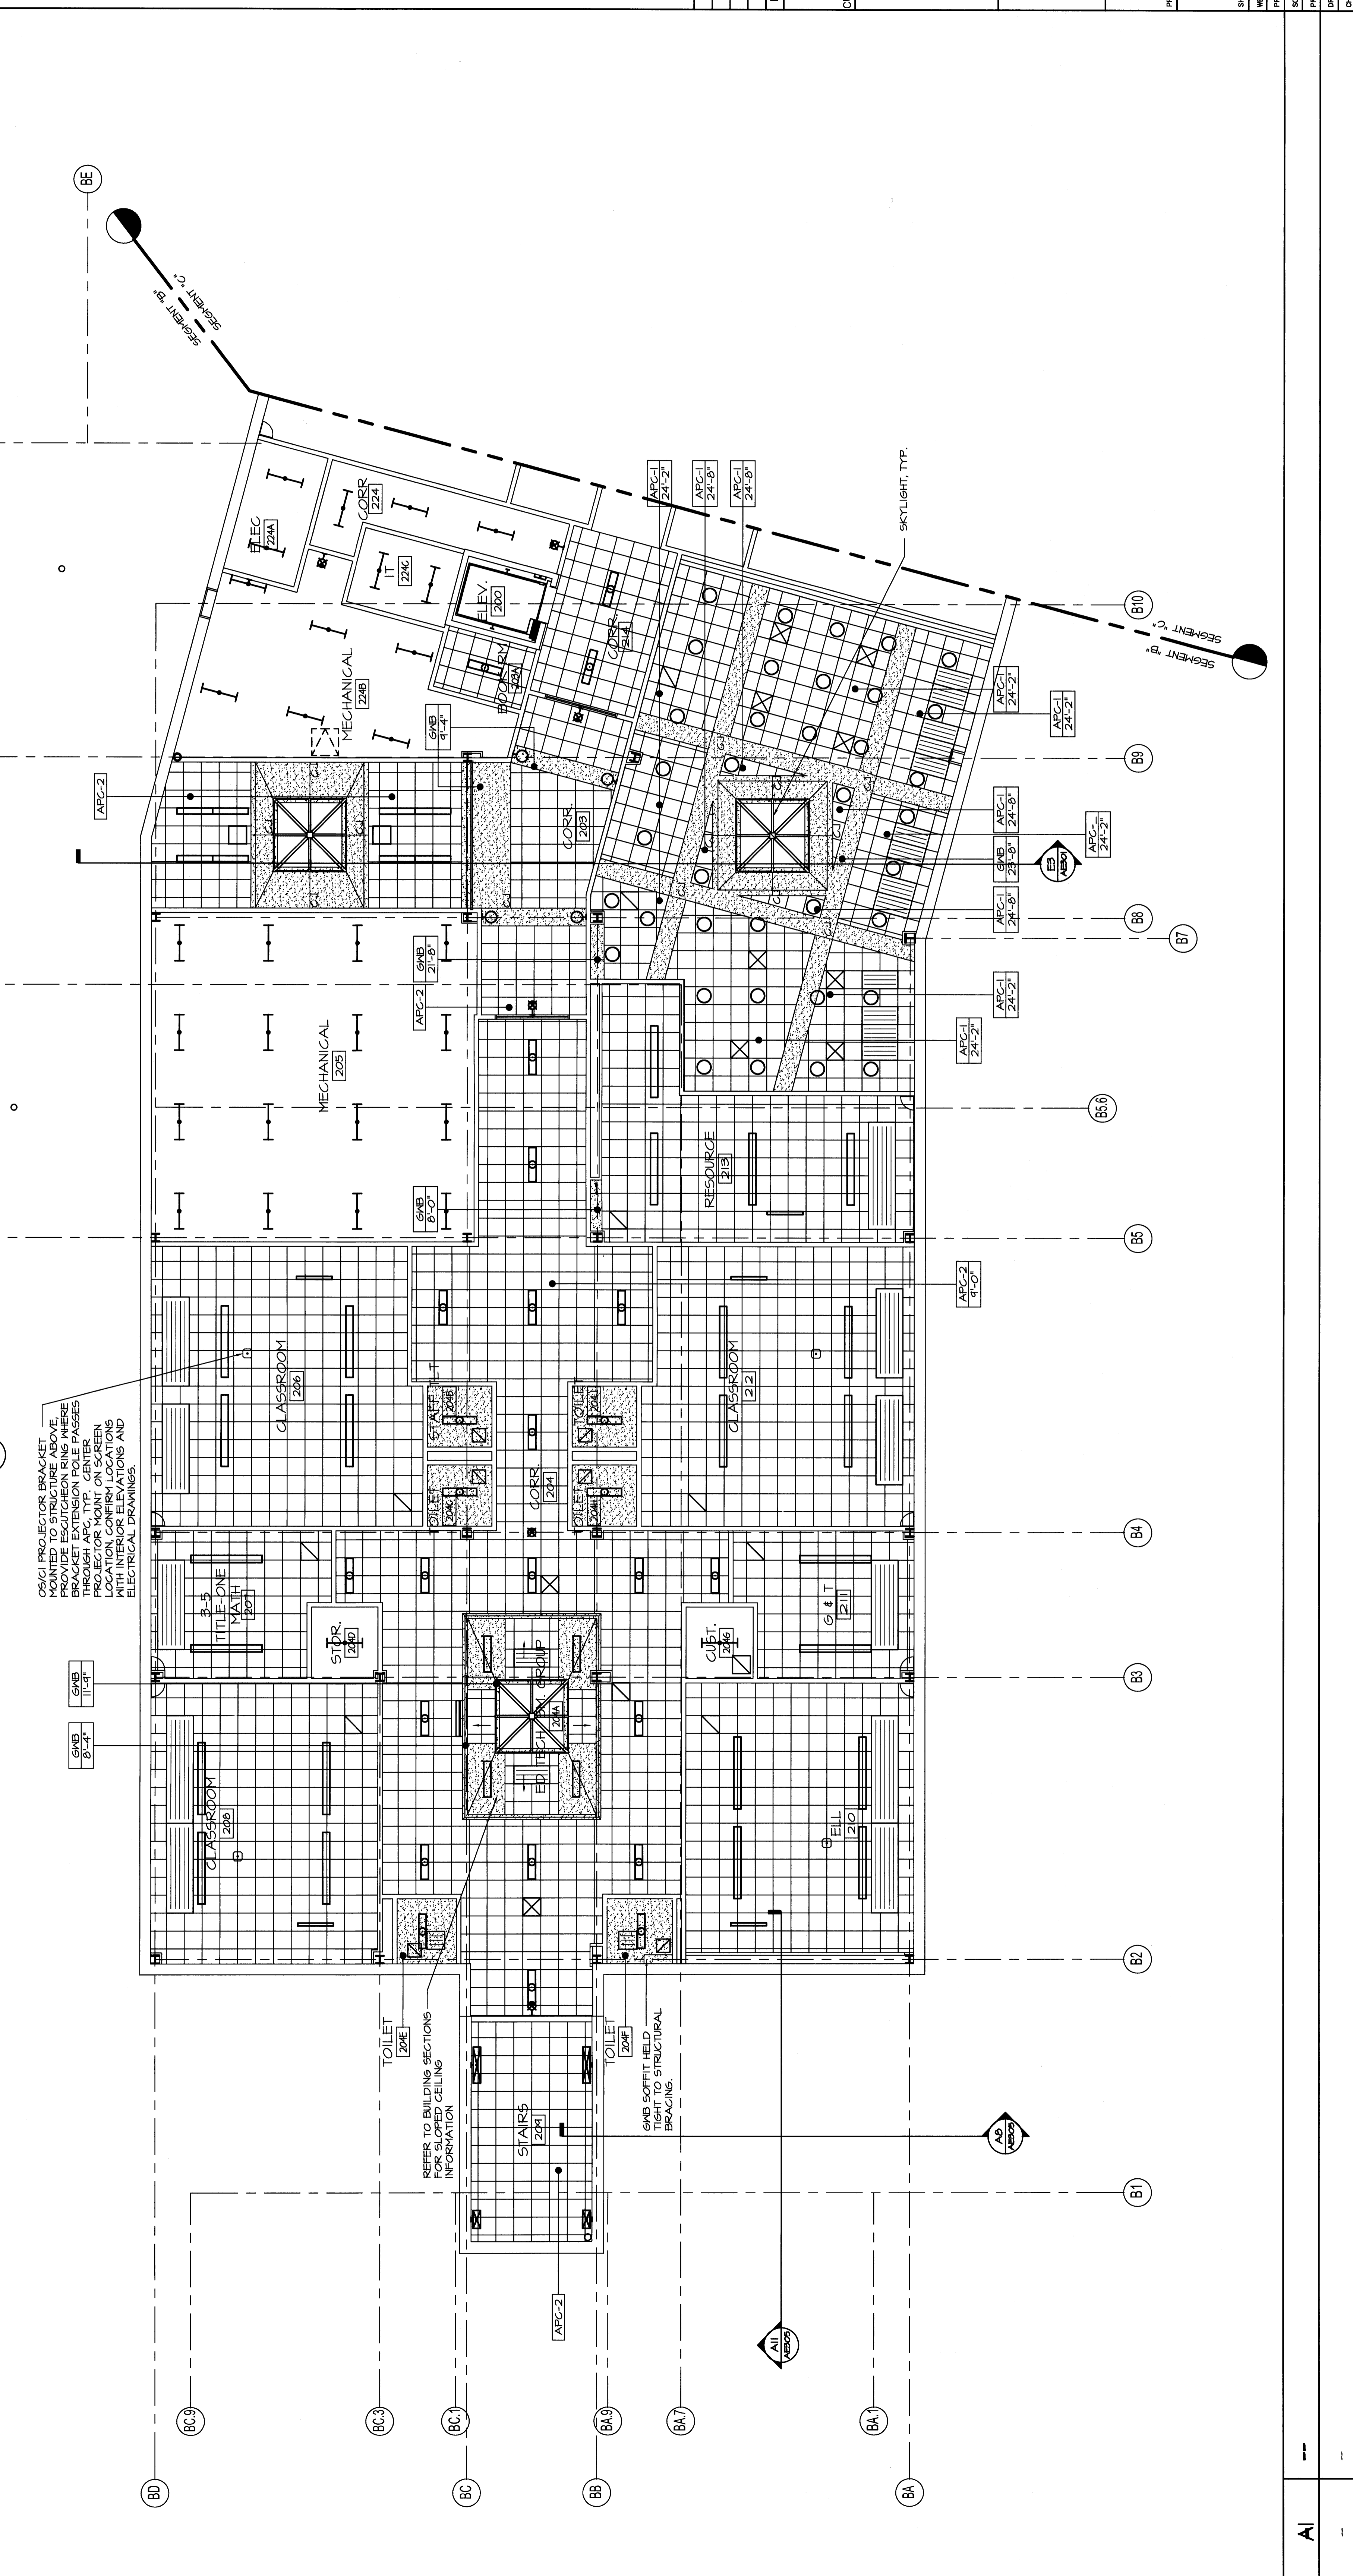

OS/CI PROJECTOR BRACKET MOUNTED TO STRUCTURE ABOVE. BRACKET EXTENSION POLE PASSES THROUGH APC. TYP. CENTER PROJECTIONS ON SCREENS TO MATCH INTERIOR ELEVATIONS AND ELECTRICAL DRAWINGS.

REFER TO BUILDING SECTIONS FOR INFORMATION ON STAIRS.

GWB SOFFIT HELD TIGHT TO STRUCTURAL BRACINGS.