MOTHERHOUSE SENIOR HOUSING 605 Stevens Ave. **Portland, Maine**

Consultants:

PROJECT MANAGER:

LICHT ENVIRONMENTAL DESIGN, LLC 35 Fran Circle Gray, ME 04039 (207) 749-4924

LANDSCAPE ARCHITECT:

CARROLL ASSOCIATES 217 Commercial St. Suite 200 Portland, ME 04101 (207) 772-1552

CIVIL ENGINEER:

FAY SPOFFORD & THORNDIKE 778 Main Street, Suite 8 South Portland, ME 04106 (207) 775-1121

ARCHITECT:

ARCHETYPE ARCHITECTS 48 Union Wharf Portland, ME 04101 (207) 772-6022

SURVEYOR:

TITCOMB ASSOCIATES 133 Gray Road Falmouth, ME 04105 (207) 797-9199


MAP 136, LOT E-6

APPLICATION FOR: Site Plan Review

Owner / Applicant:

MOTHERHOUSE ASSOCIATES LP

100 COMMERCIAL STREET, SUITE 414 PORTLAND, ME 04101 207.772.7673 rlicht@securespeed.net

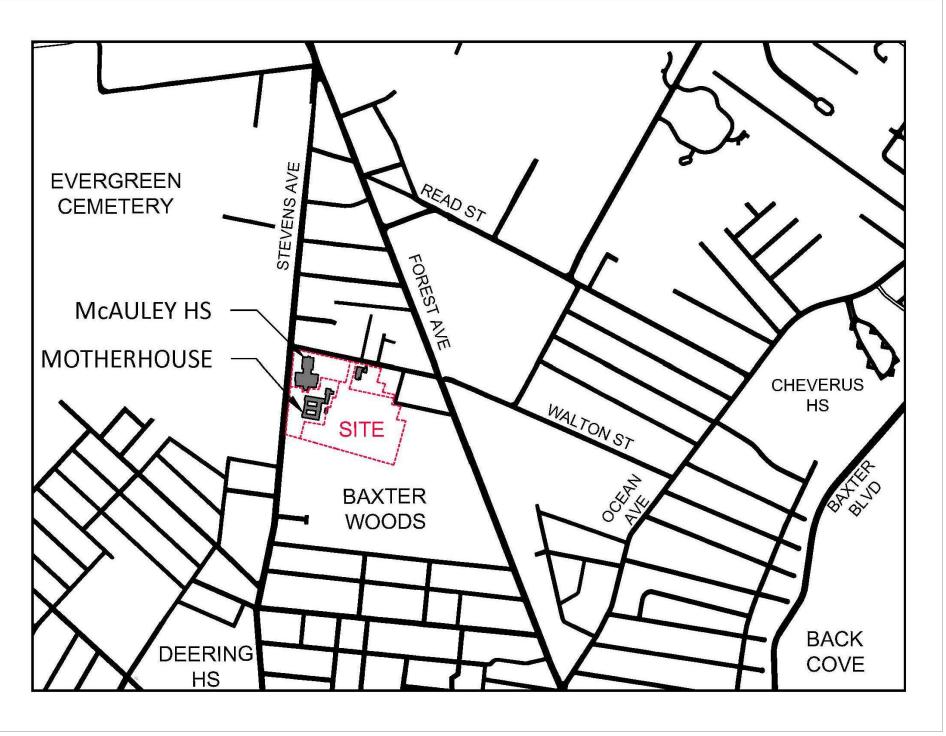


LOCATION MAP

N.T.S


Index of Drawings:

G1	TITLE / COVER SHEET
C1	EXISTING CONDITIONS
C2	OVERALL SUBDIVISION PLAN
C3	SECTIONAL SUBDIVISION PLAT
C4.0 C5.0 C6.0	SITE PLAN UTILITY PLAN GRADING, DRAINAGE & EROSION CONTROL PLAN
L1.0	TREE PRESERVATION PLAN
L2.0	LANDSCAPE & LIGHTING PLAN
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C9.0	PRE-DEVELOPMENT WATERSHED PLAN
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A2.01	SOUTH ELEVATION
A2.02	WEST ELEVATION
A2.03	EAST ELEVATION
A2.04	NORTH ELEVATION
A2.05	ELEVATIONS

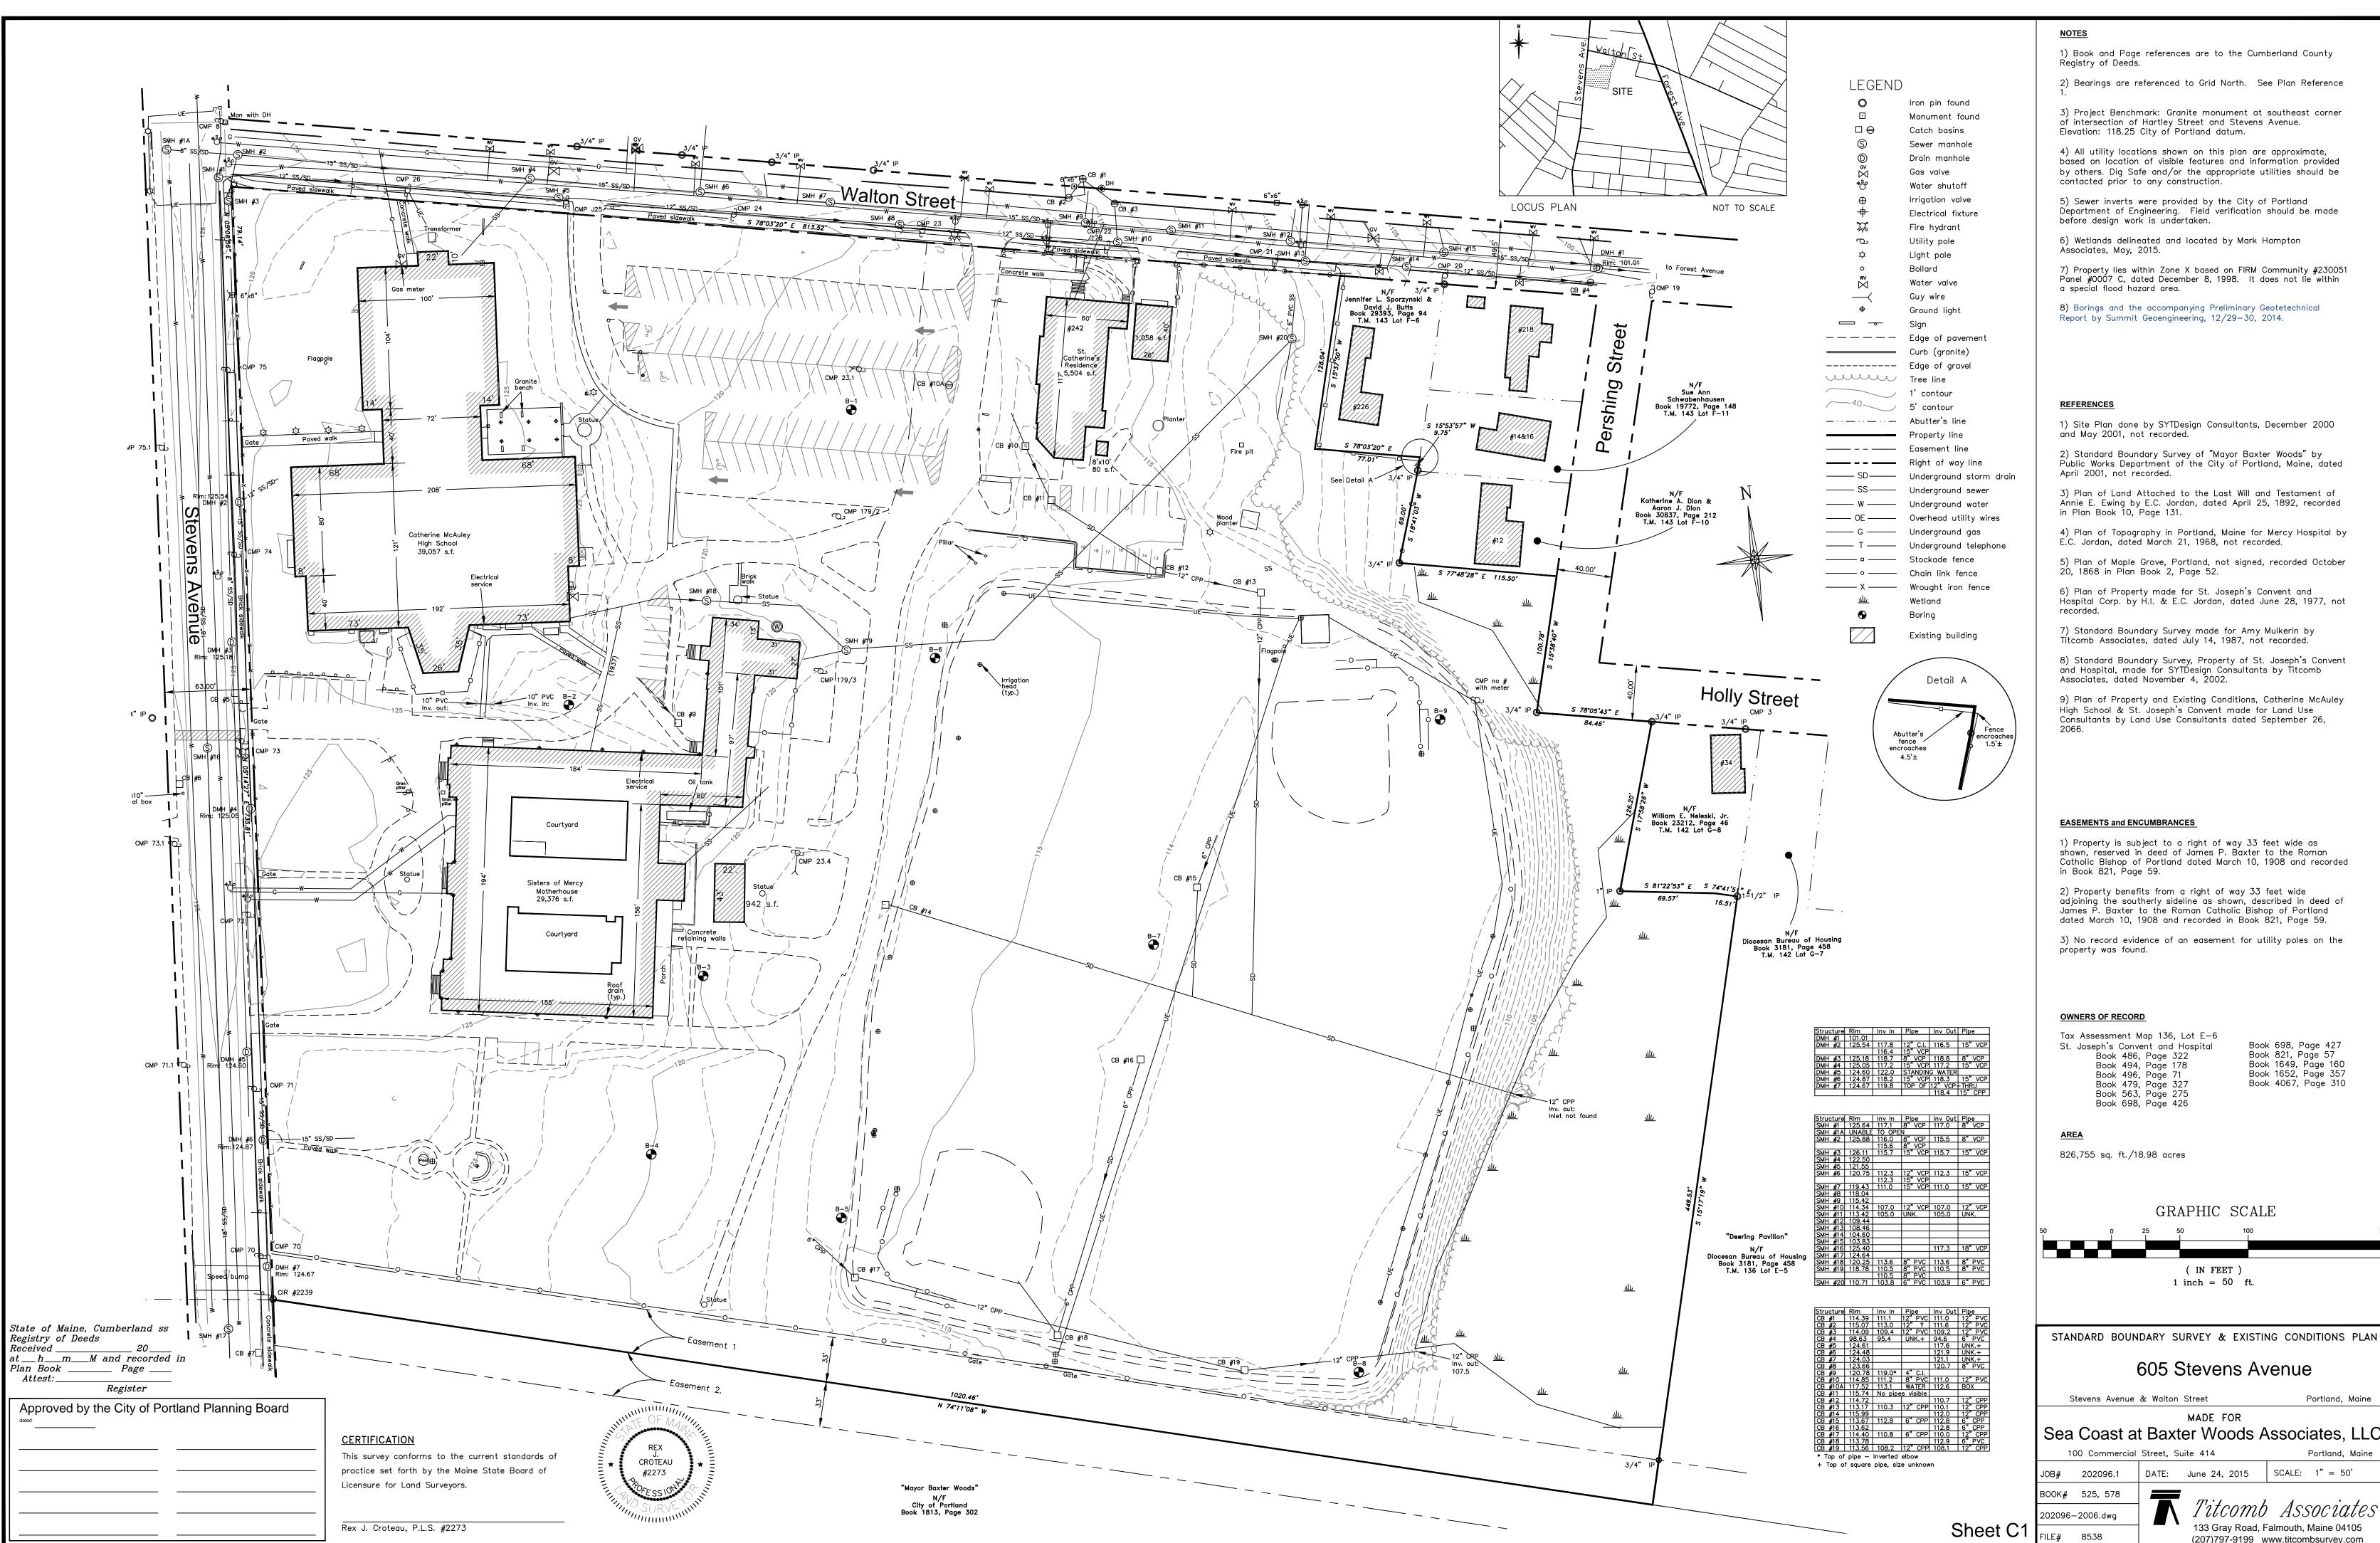

8538

(207)797-9199 www.titcombsurvey.com

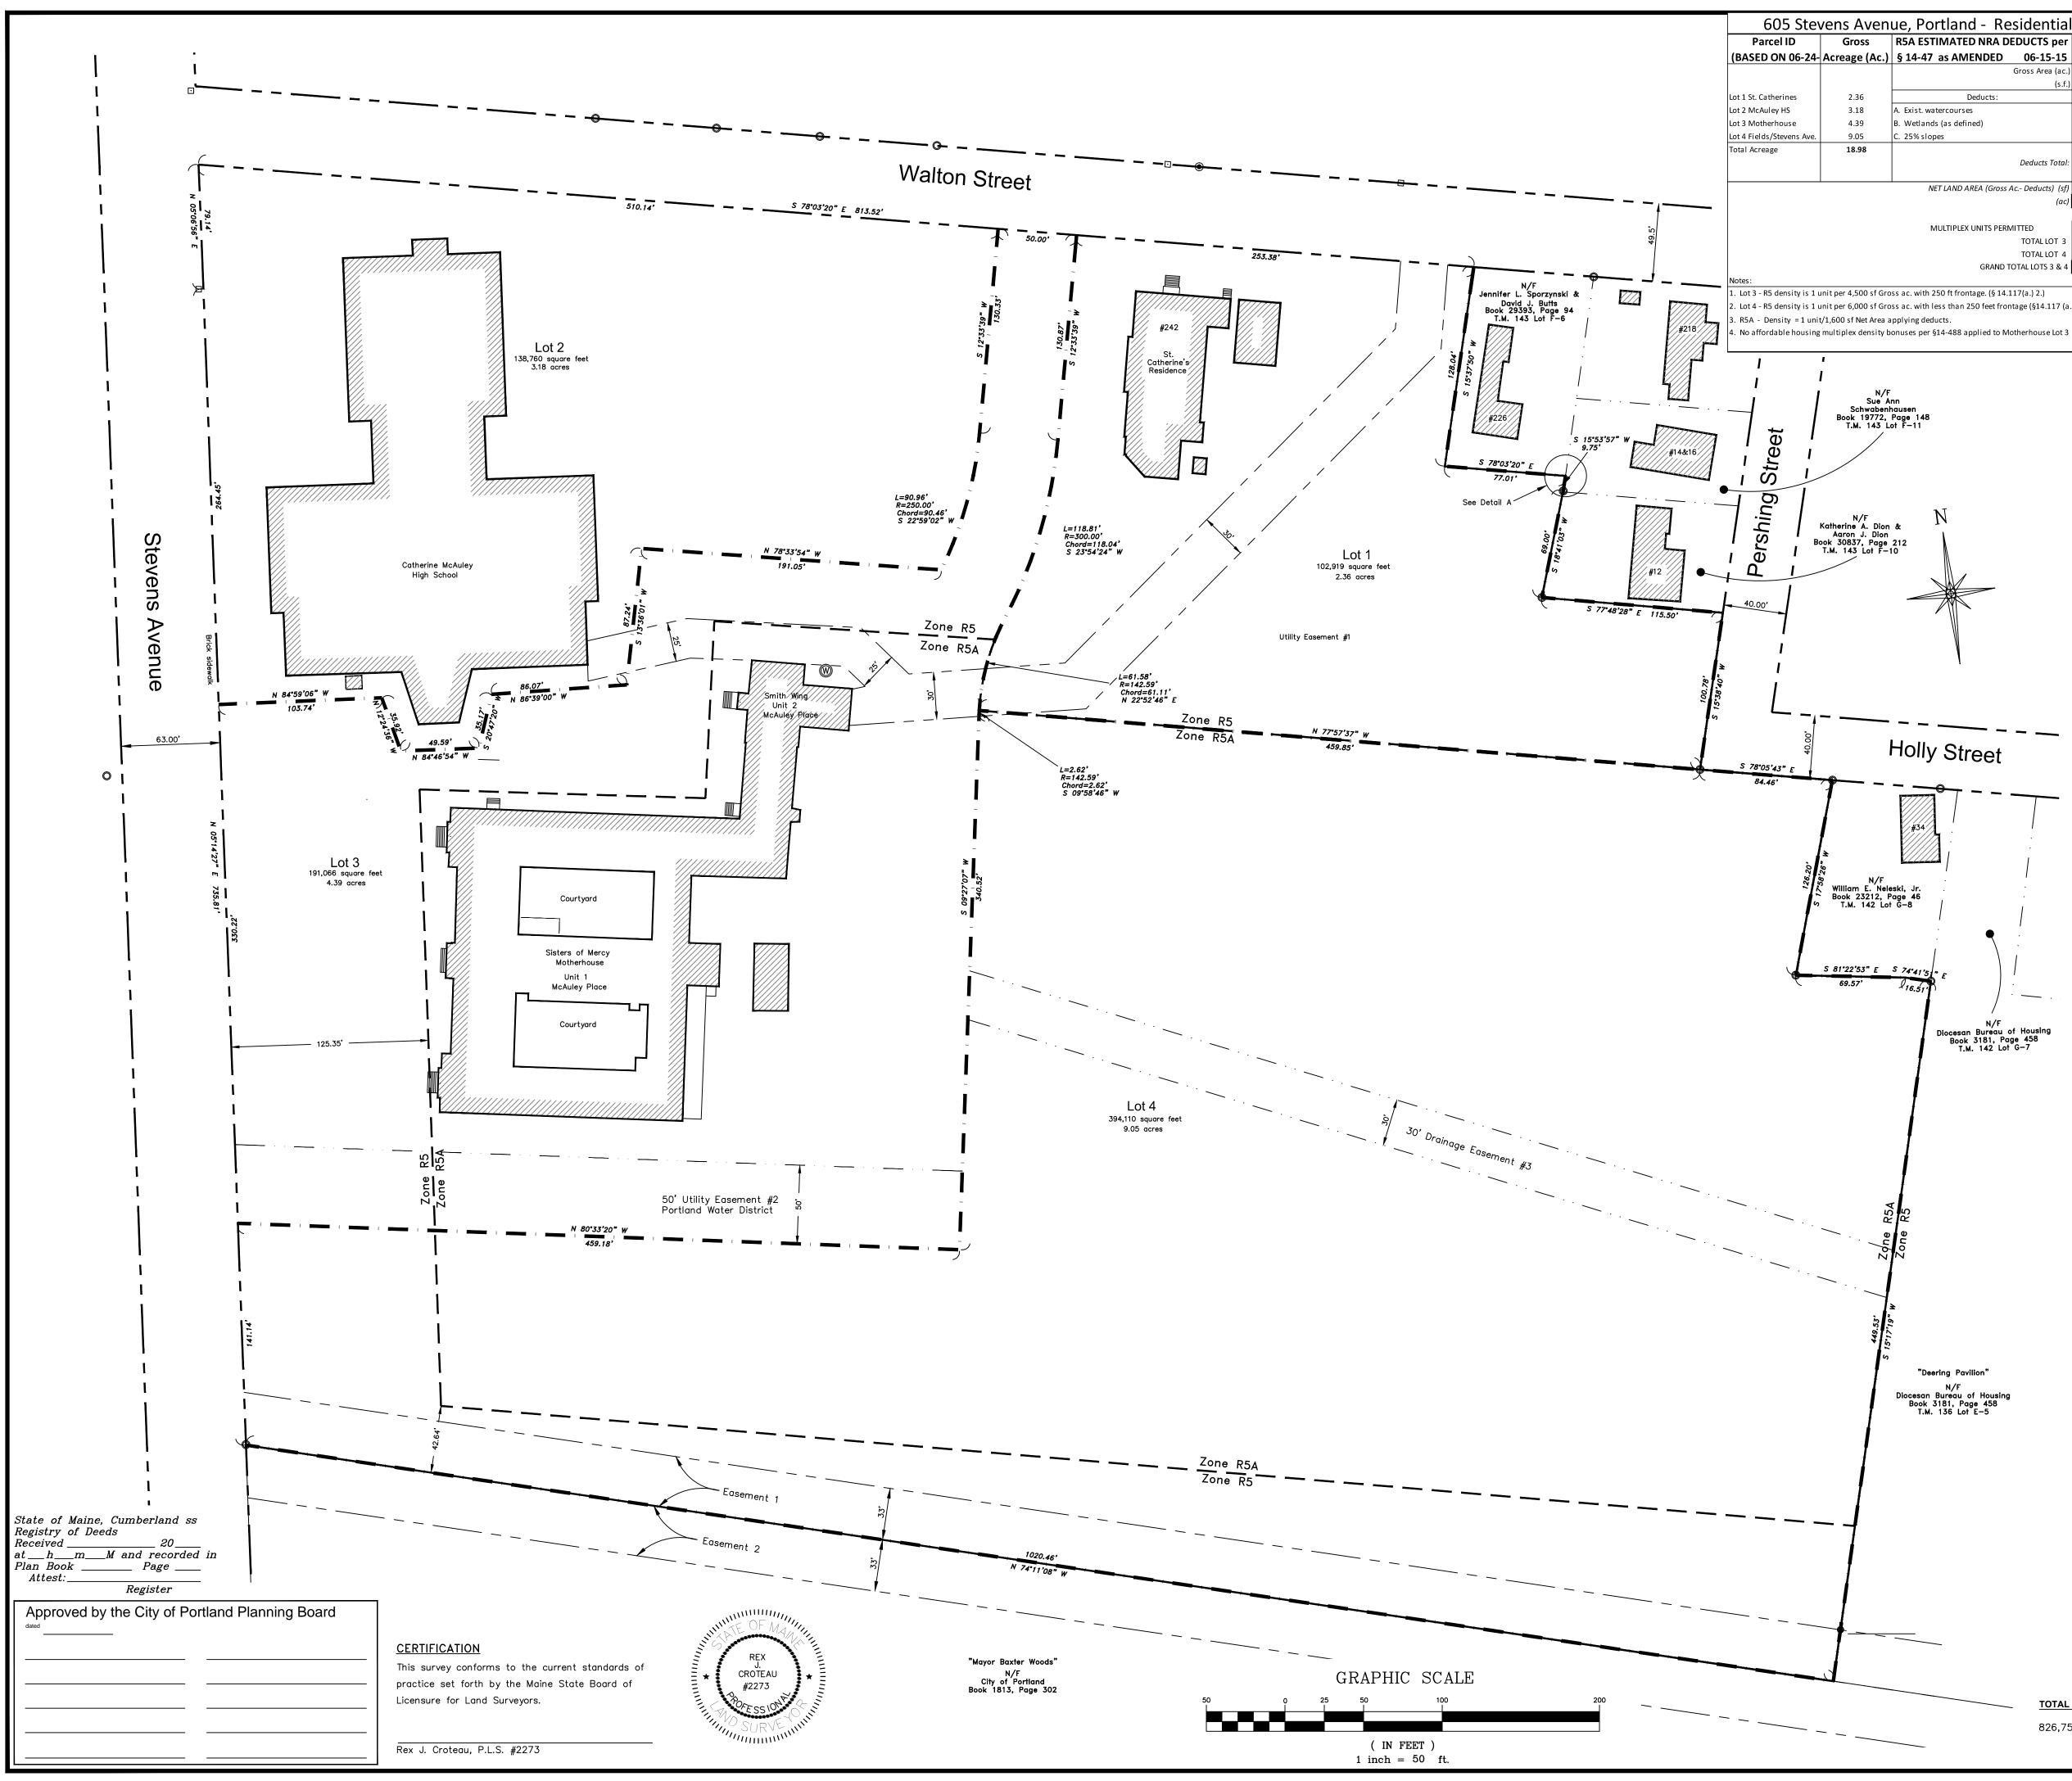

605 Stevens Avenue, Portland - Residential Density Computations Lots 3 & 4

STIMATED NRA DEDUCTS per	LOT AREA IN I	R5A (APPLY	LOT AREA IN R5 (NO			
7 as AMENDED 06-15-15	Mother House Lot 3	Lot 4 (Fields)	Mother House Lot 3	Lot 4 (Fields)		
Gross Area (ac.)	2.65	7.15	1.73	1.90		
(s.f.)	115,538	311,533	75,528	82,577		
Deducts:						
watercourses	0	0	NA	NA		
nds (as defined)	0	54,341	NA	NA		
lopes	0	19,827	NA	NA		
Deducts Total:	0	74,168	NA	NA		
NET LAND AREA (Gross Ac Deducts) (sf)	115,538	237,365	75,528	82,577		
(ac)	2.65	5.45	1.73	1.90		
MULTIPLEX UNITS PERMITTED	72	148	16	13		
TOTAL LOT 3	88					
TOTAL LOT 4	161					
GRAND TOTAL LOTS 3 & 4	249					
			•			
h 250 ft frontage. (§ 14.117(a.) 2.)						
h less than 250 feet frontage (§14.117 (a	.) 2.)					
oducts						

LEGEND

— · · — · · — · · Abutter's line

———————————————————————Easement line

Right of way line


lron pin found

Property line

Monument found

Existing building

0

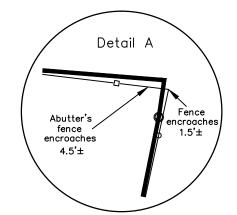

SITE NOT TO SCALE

LOCUS PLAN

SITE D	ATA TABLE	
	REQU	IRED
STANDARD	R5	R5A
MIN. LOT AREA		
A. MULTIFAMILY	9,000 SF	2 AC
B. CONGREGATE CARE	N/A	2 AC
C. ELEM - SECONDARY SCHOOL	30,000 SF	N/A
MIN. FRONTAGE (FT)	50	50
MIN. YD. DIMENSIONS (FT.)		
A. FRONT YD.	20	25
B. REAR YD.	20	25
C. SIDE YD.	14	16
MAX. LOT COVERAGE	40%	30%
MIN. LOT WIDTH (FT.)	90	60

NOTES

1) Book and Page references are to the Cumberland County Registry of

2) Bearings are referenced to Grid North. See Plan Reference 1.

3) This plan has been prepared and approved in accordance with the City of Portland Land Use Code, Article IV Subdivisions as a four (4)—lot subdivision. Development of Lots 1—4 shall be subject to Site Plan Review and approval by the Planning Board pursuant to Article V Site Plan Review standards. A sectional recording plat for individual or master planned development shall be prepared and approved for individual lot or section development in accordance with Article IV, § 14-495(h) requirements prior to construction on any lots.

4) No development shall occur within the 33-foot right of way easement located on the southerly property line (the Baxter Easement). Said easement shall forever remain natural, however allowing for tree and vegetation maintenance by a licensed arborist, creation and maintenance of trails for use by the public or other activities consistent with permitted uses within the adjacent Mayor Baxter Woods property.

REFERENCES

1) Site Plan done by SYTDesign Consultants, December 2000 and May 2001, not recorded.

2) Standard Boundary Survey of "Mayor Baxter Woods" by Public Works Department of the City of Portland, Maine, dated April 2001, not recorded.

3) Plan of Land Attached to the Last Will and Testament of Annie E. Ewing by E.C. Jordan, dated April 25, 1892, recorded in Plan Book 10, Page 131.

4) Plan of Topography in Portland, Maine for Mercy Hospital by E.C. Jordan, dated March 21, 1968, not recorded.

5) Plan of Maple Grove, Portland, not signed, recorded October 20, 1868 in Plan Book 2, Page 52. 6) Plan of Property made for St. Joseph's Convent and Hospital Corp. by H.I. & E.C. Jordan, dated June 28, 1977, not recorded.

7) Standard Boundary Survey made for Amy Mulkerin by Titcomb Associates, dated July 14, 1987, not recorded.

8) Standard Boundary Survey, Property of St. Joseph's Convent and Hospital, made for SYTDesign Consultants by Titcomb Associates, dated November 4, 2002.

9) Plan of Property and Existing Conditions, Catherine McAuley High School & St. Joseph's Convent made for Land Use Consultants by Land Use Consultants dated September 26, 2066.

EASEMENTS and ENCUMBRANCES

1) Property is subject to a right of way 33 feet wide as shown, reserved in deed of James P. Baxter to the Roman Catholic Bishop of Portland dated March 10, 1908 and recorded in Book 821, Page 59.

2) Property benefits from a right of way 33 feet wide adjoining the southerly sideline as shown, described in deed of James P. Baxter to the Roman Catholic Bishop of Portland dated March 10, 1908 and recorded in Book 821, Page 59.


3) No record evidence of an easement for utility poles on the property was found.

OWNERS OF RECORD

Tax Assessment Map 136, Lot E—6 St. Joseph's Convent and Hospital Book 486, Page 322 Book 494, Page 178

Book 496, Page 71 Book 479, Page 327 Book 563, Page 275 Book 698, Page 426

Book 698, Page 427

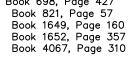

OVERALL SUBDIVISION PLAN

605 Stevens Avenue

Stevens Avenue & Walton Street

MADE FOR Sea Coast at Baxter Woods Associates, LLC 966 Riverside Street

Portland, Maine DATE: June 24, 2015 SCALE: 1" = 50'

Portland, Maine

Titcomb Associates 133 Gray Road, Falmouth, Maine 04105 (207)797-9199 www.titcombsurvey.com


TOTAL AREA 826,755 sq. ft./18.98 acres

Sheet C2 FILE# 8538

202096-2006.dwg

JOB# 202096.1

BOOK# 525, 578

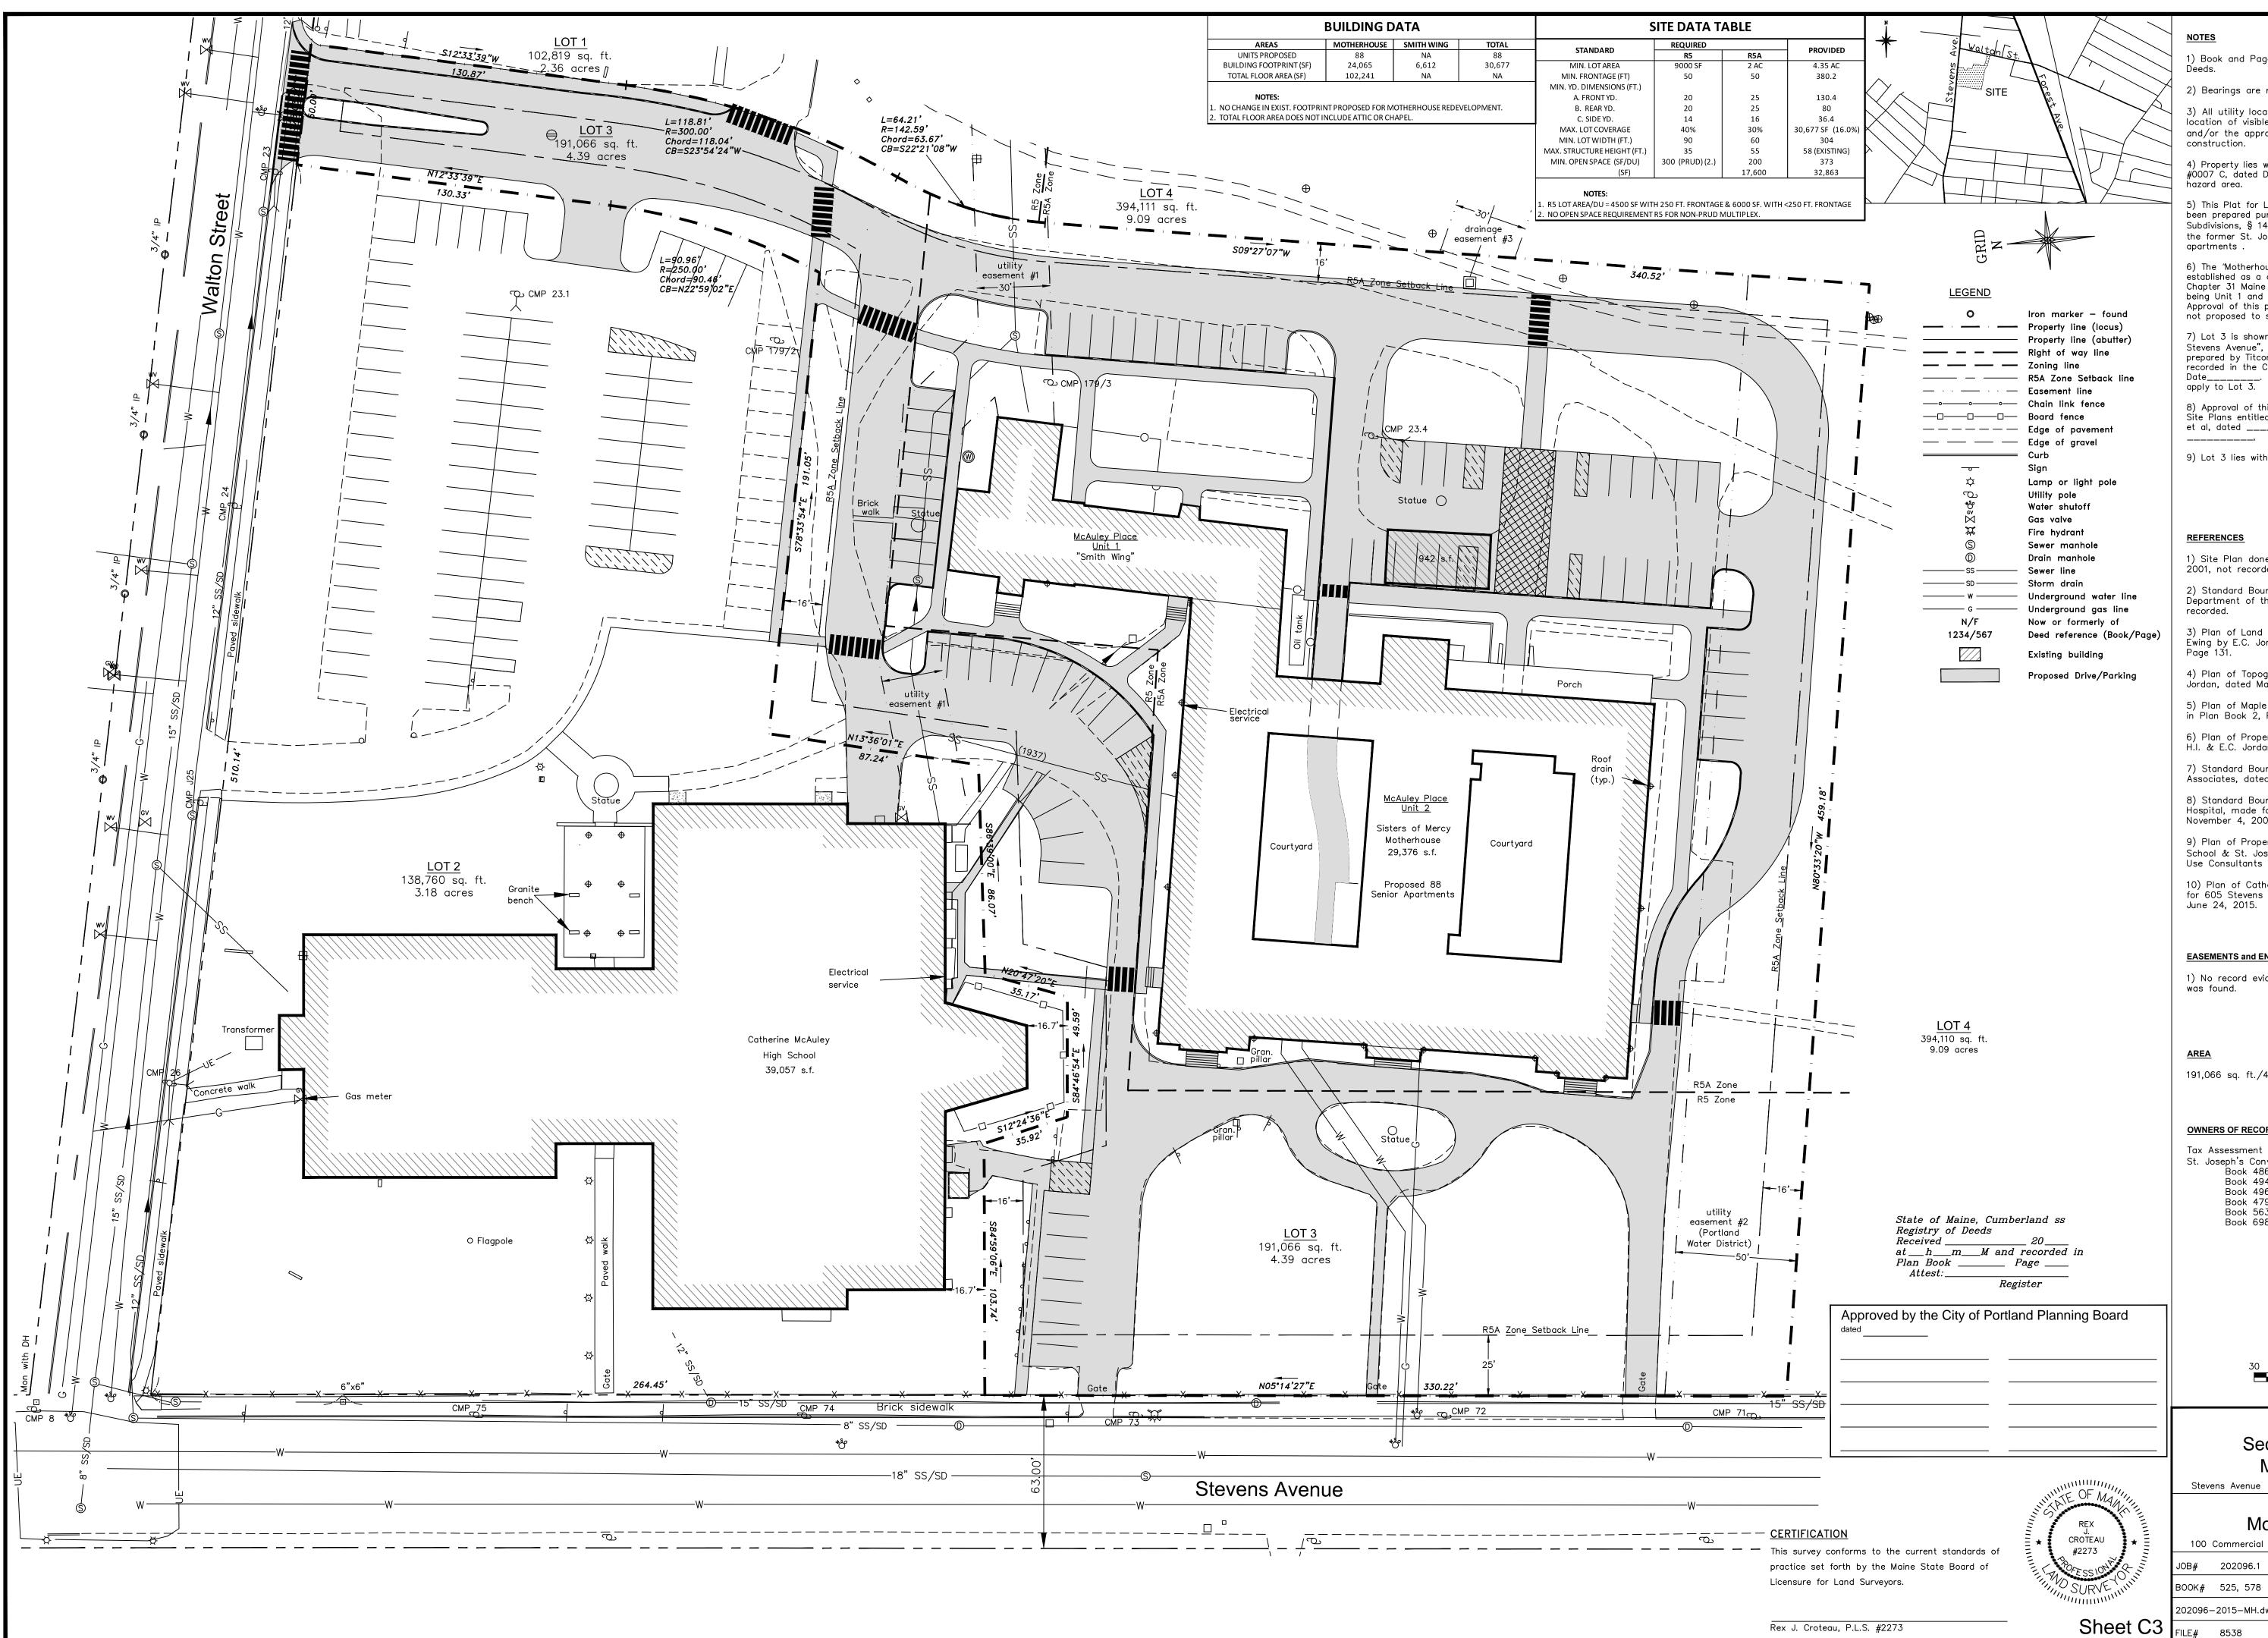

Deeds. 2) Bearings are referenced to Grid North. See Plan Reference 1.

NOTES

3) All utility locations shown on this plan are approximate, based on location of visible features and information provided by others. Dig Safe and/or the appropriate utilities should be contacted prior to any construction.

1) Book and Page references are to the Cumberland County Registry of

4) Property lies within Zone X based on FIRM Community #230051 Panel #0007 °C, dated December 8, 1998. It does not lie within a special flood hazard area.

5) This Plat for Lot 3 — of the Motherhouse Senior Apartments has been prepared pursuant to the City of Portland Land Use Code Article IV, Subdivisions, § 14-495(h.) Sectional Recordings, for the re-development of the former St. Joseph's Convent (the Motherhouse) into 88 senior apartments .

6) The "Motherhouse" and connected "Smith Wing" are collectively to be established as a condominium under the Maine Condominium Act, Title 33 Chapter 31 Maine Revised Statutes entitled McAuley Place, the Motherhouse being Unit 1 and the Smith Wing being Unit 2 of said condominium. Approval of this plat creates an 88 unit subdivision of Unit 1 only and does not proposed to subdivide Unit 2.

7) Lot 3 is shown on the approved 4 lot subdivision plat entitled "605 Stevens Avenue", made for Sea Coast at Baxter Woods Associates, LLC recorded in the CCRD Plan Bk_____Page_____ on Date_____. All relevant conditions of that plan and approval shall apply to Lot 3. prepared by Titcomb Associates, Plan Sheet C2 dated June 24, 2015 and

8) Approval of this Sectional Plat includes by reference the accompanying Site Plans entitled 'Motherhouse Senior Living, prepared by Carroll Associates, et al, dated ______ and approved by the Portland Planning Board on ____,

9) Lot 3 lies within the R5 Residential and R5A Residential zones.

REFERENCES

1) Site Plan done by SYTDesign Consultants, December 2000 and May 2001, not recorded.

2) Standard Boundary Survey of "Mayor Baxter Woods" by Public Works Départment of the City of Portland, Maine, dated April 2001, not recorded.

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9) Plan of Property and Existing Conditions, Catherine McAuley High School & St. Joseph's Convent made for Land Use Consultants by Land Use Consultants dated September 26, 2066.

10) Plan of Catherine McAuley High School & St. Joseph's Convent made for 605 Stevens Avenue Senior Apartments by Titcomb Associates dated June 24, 2015.

EASEMENTS and ENCUMBRANCES

1) No record evidence of an easement for utility poles on the property was found.

<u>AREA</u>

191,066 sq. ft./4.39 acres


OWNERS OF RECORD

Stevens Avenue

JOB# 202096.1

202096-2015-MH.dwg


8538

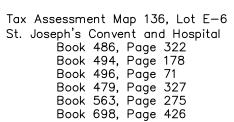

Book 698, Page 427 Book 821, Page 57 Book 1649, Page 160 Book 1652, Page 357 Book 4067, Page 310

1" = 30'

PLAN OF LOT 3 Sectional Subdivisional Plat

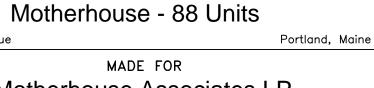



Motherhouse Associates LP 100 Commercial Street-Suite 414 Portland, Maine


DATE: June 24, 2015 | SCALE: 1" = 30'

Titcomb Associates 133 Gray Road, Falmouth, Maine 04105 (207)797-9199 www.titcombsurvey.com

Rex J. Croteau, P.L.S. #2273

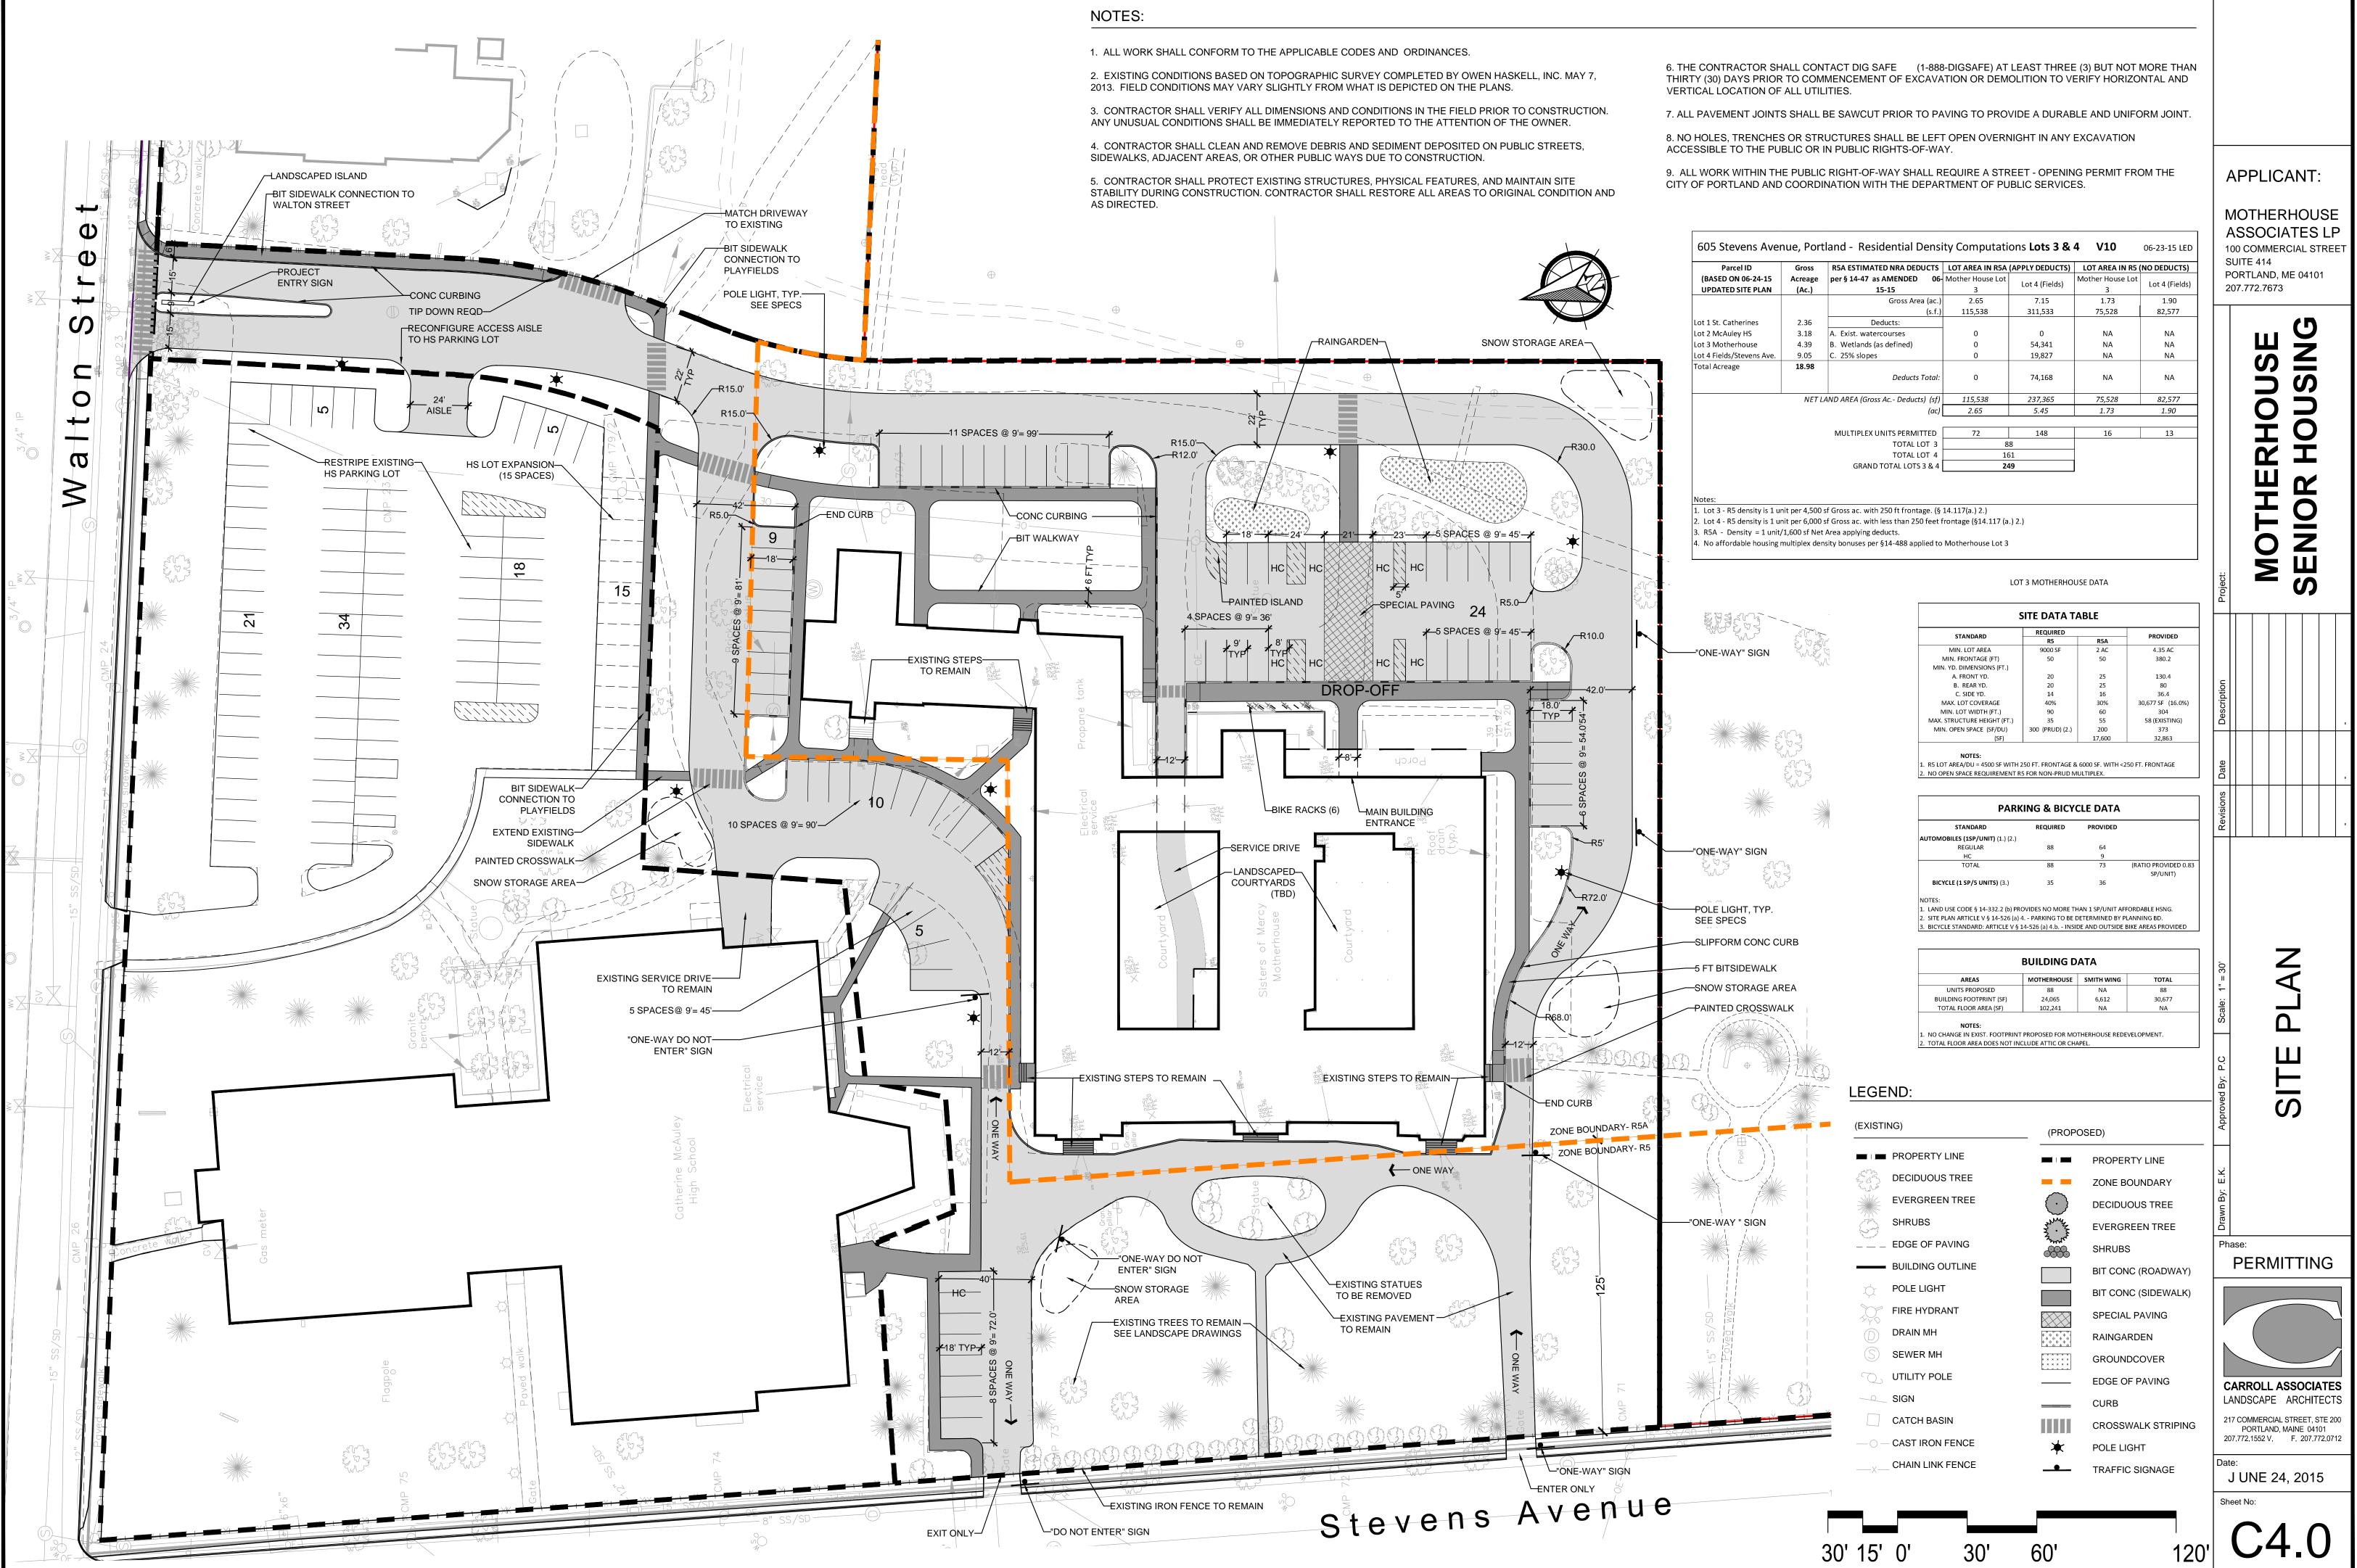


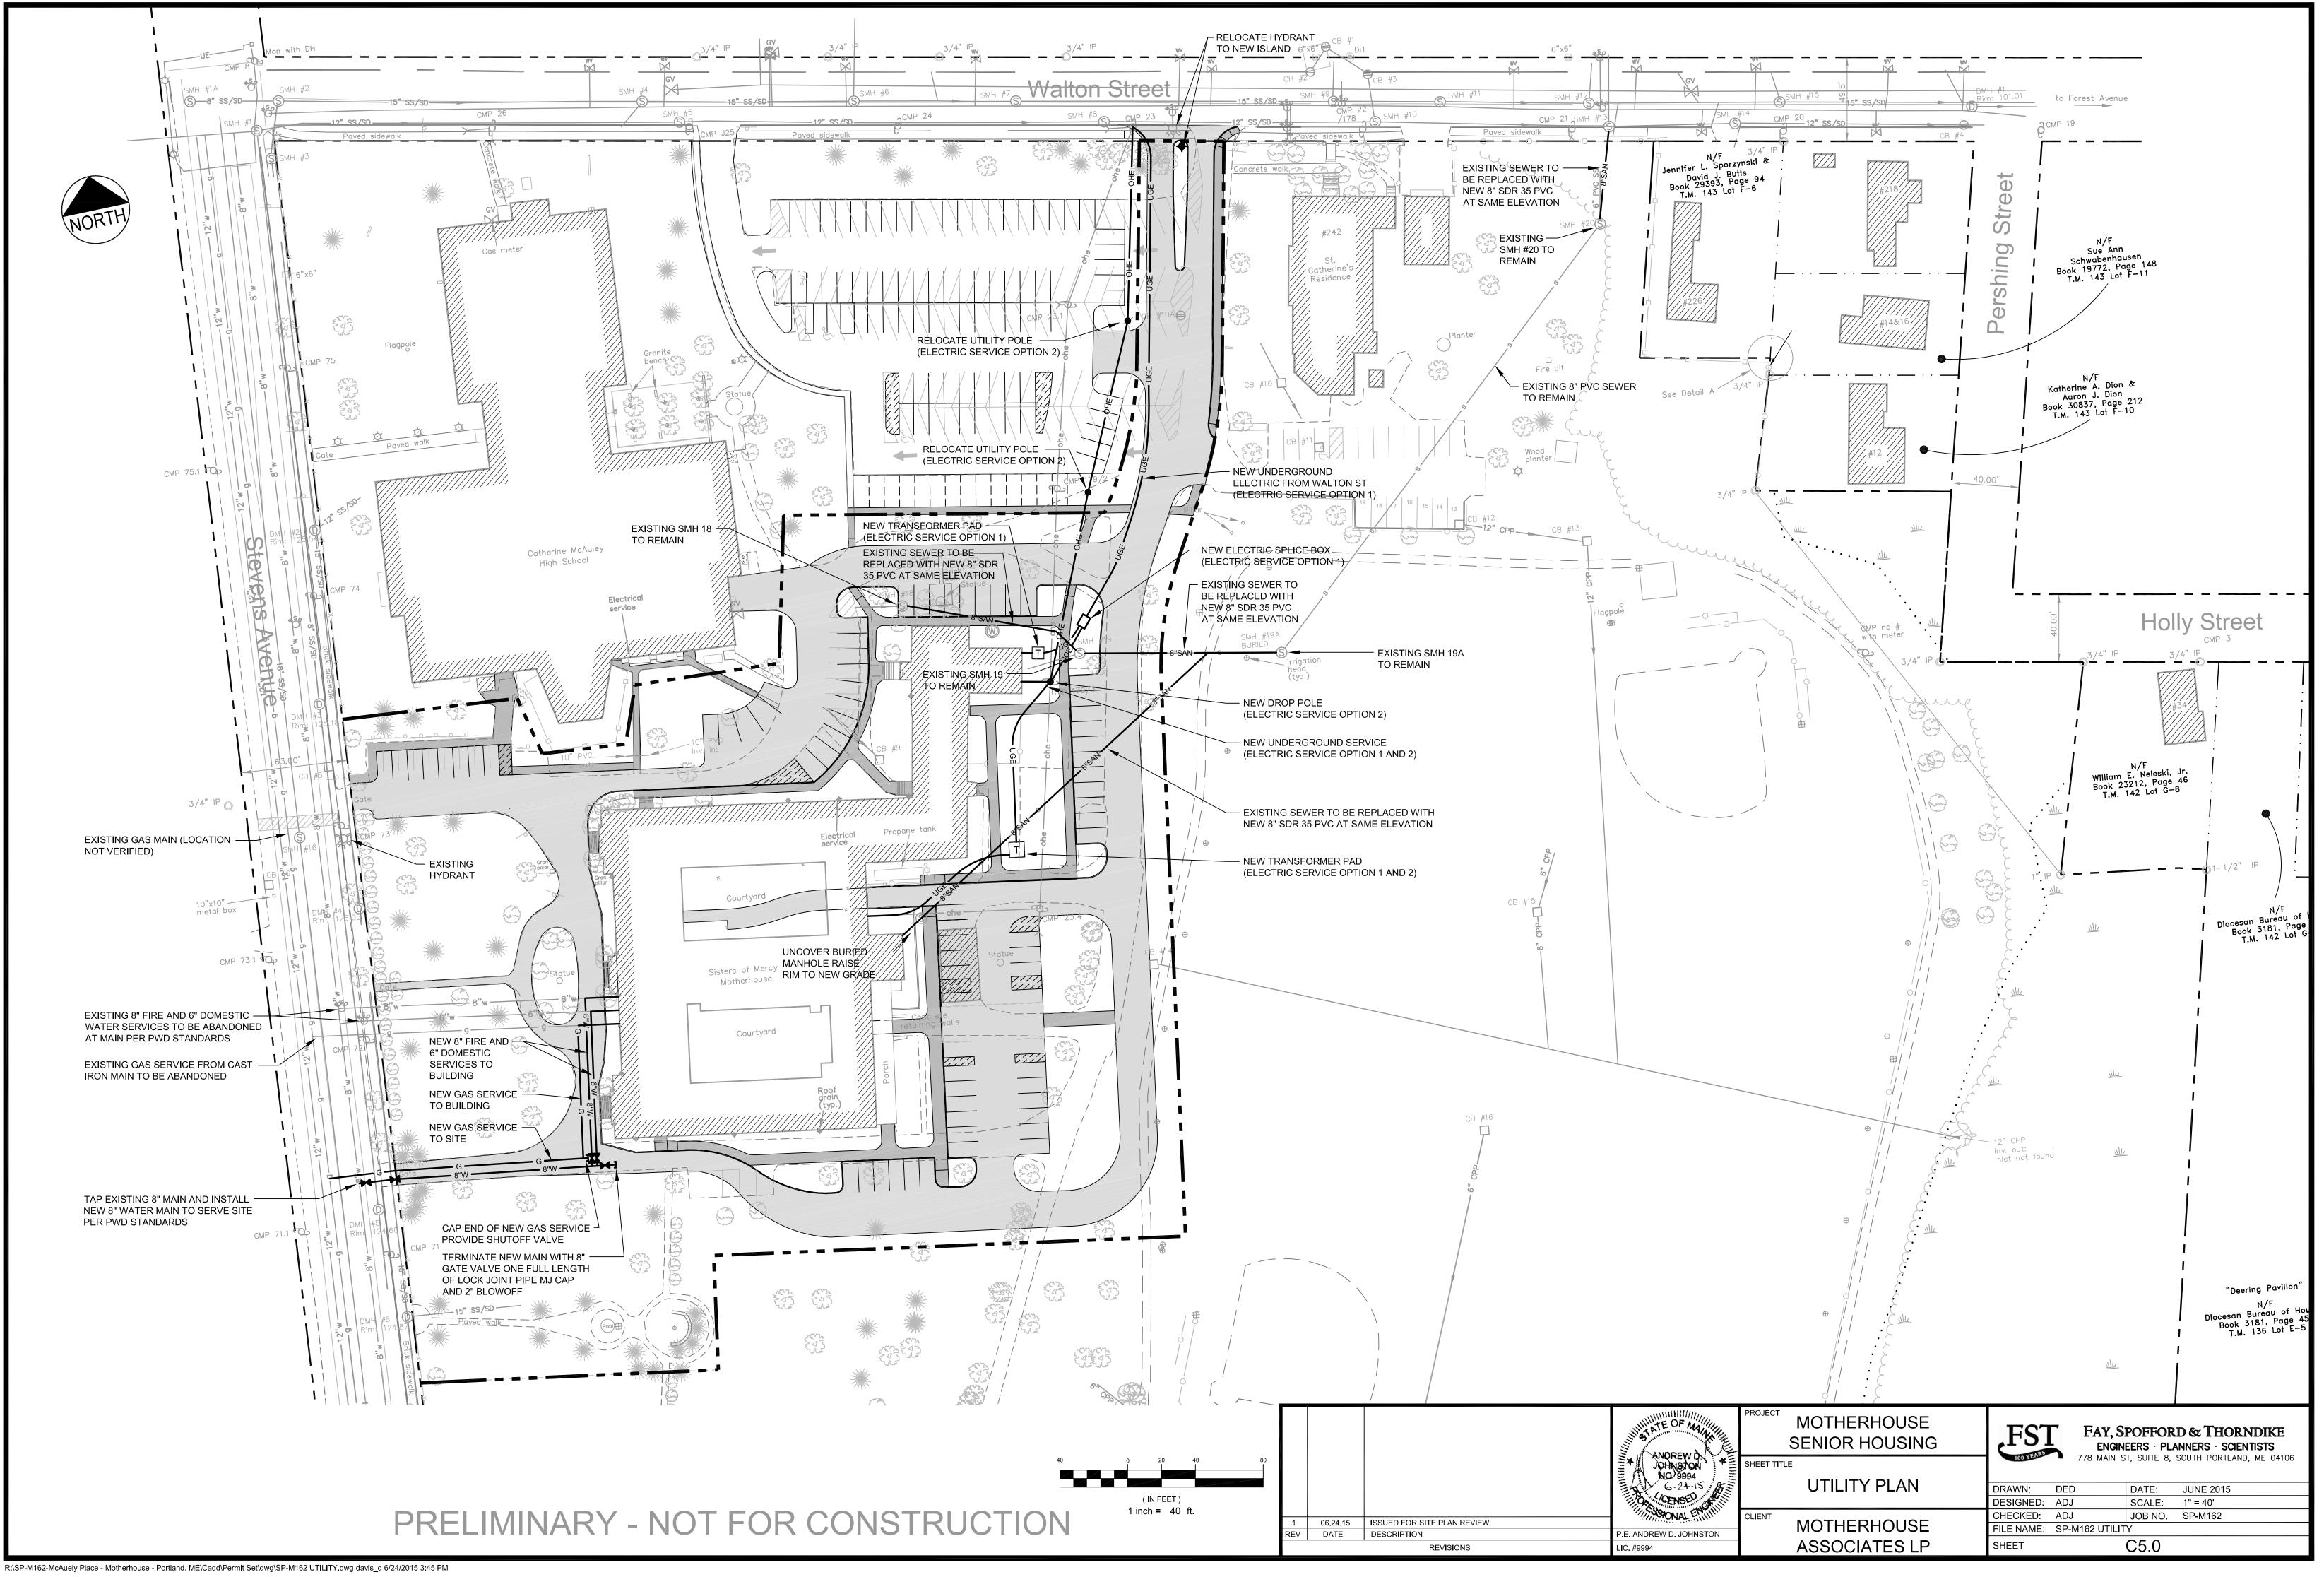


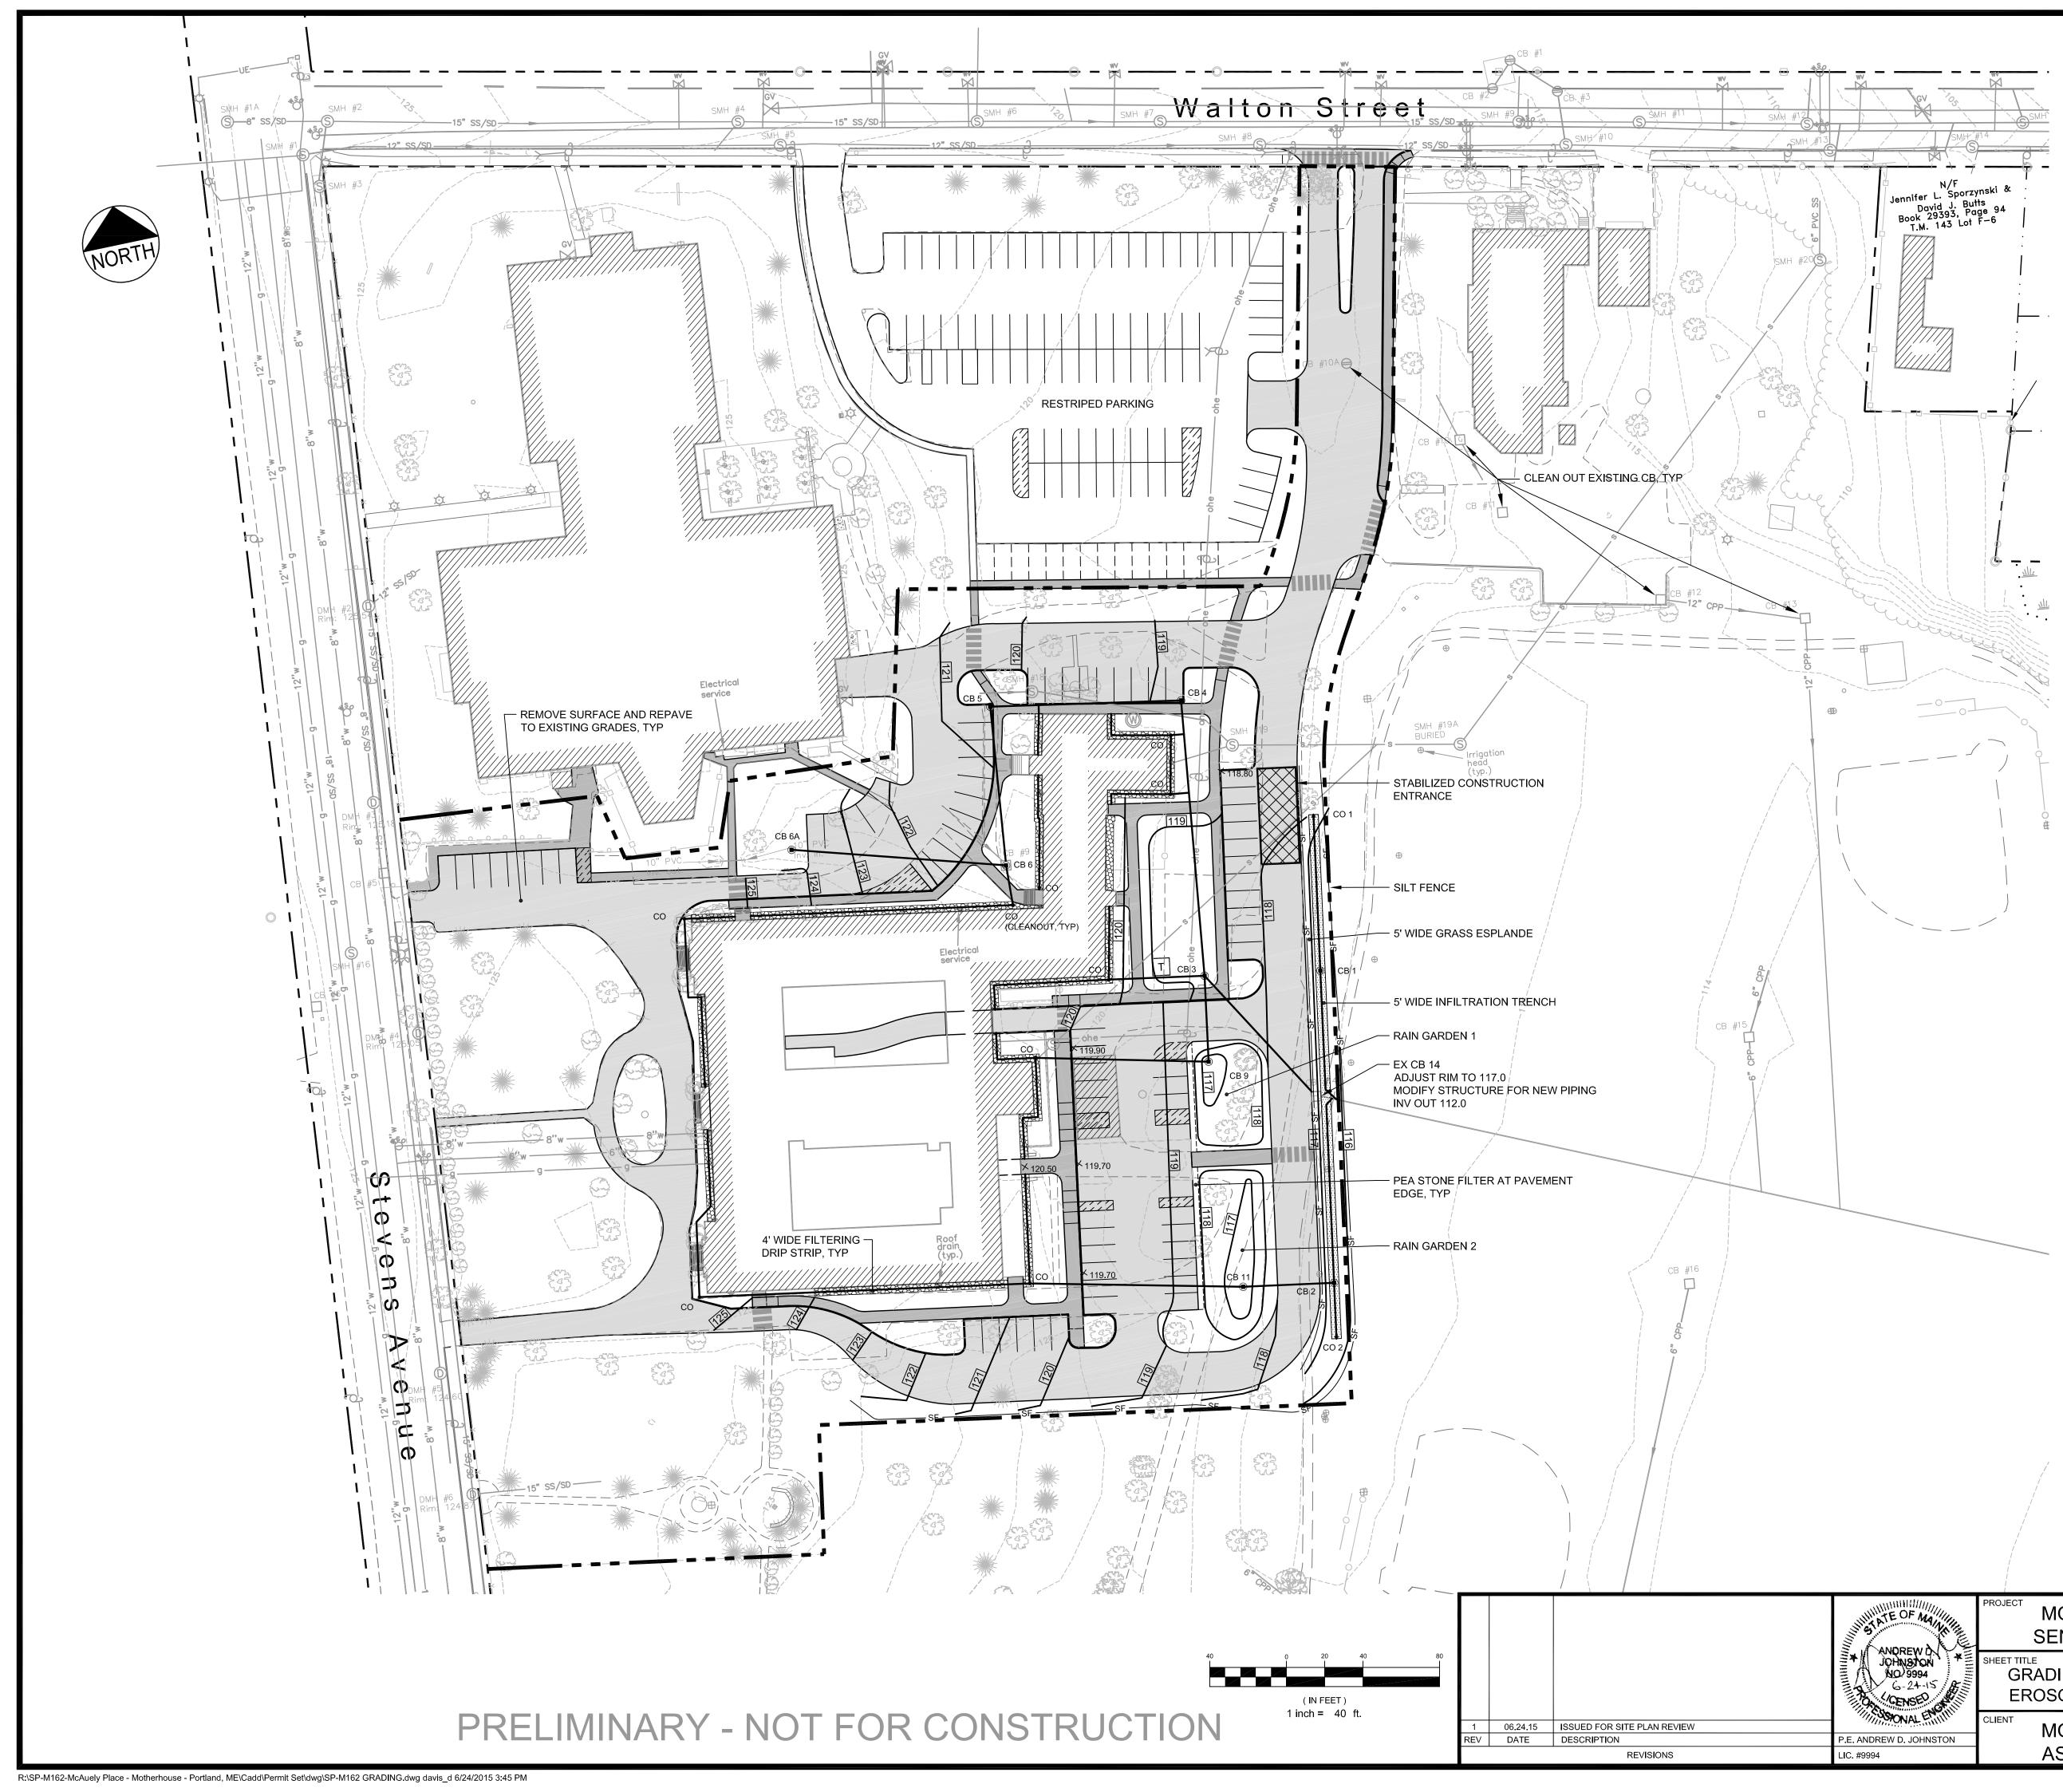


		MOTHER	HOUSE DRA	IN SCHEDULE		
STRUCTURE	RIM	INV IN	DIR	INV OUT	SUMP	SIZE
NEW CB 11	117.50	114.68	W	113.50	111.50	2'ID
NEW CB 2	116.50	113.20	W	112.98	110.50	2'ID
	110.00	113.02	s	112.00	110.00	210
NEW CB 6A	122.50	N/A	N/A	117.00	116.50	2'ID
NEW CB 6	120.00	115.96	W	115.50	114.00	2'ID
		115.90	S			
NEW CB 5	120.40	114.86	S	114.66	111.66	4'ID
NEW CB 4	118.50	113.66	W	113.56	110.56	4'ID
NEW CB 9	117.50	114.68	W	114.50	112.50	2'ID
NEW CB 3	118.50	112.70	N	112.60	109.60	4'ID
		114.14	S			
		115.00	W			
NEW CB 1	116.50	112.86	SE	112.82	110.50	2'ID
EX CB 14	117.00	112.09	NW	112.00	109 (EX)	4'ID
		112.50	S			
		112.50	N			
PIPE FROM	PIPE TO	LENGTH	SLOPE	US INV	DS INV	SIZE
CO 12	NEW CB 11	110	0.012	116.00	114.68	6"PVC
NEW CB 11	NEW CB 2	20	0.015	113.50	113.20	8"PVC
CO 7	NEW CB 6	20	0.005	116.00	115.90	6"PVC
NEW CB 6A	NEW CB 6	104	0.01	117.00	115.96	8"PVC
NEW CB 6	NEW CB 5	80	0.008	115.50	114.86	8"PVC
NEW CB 5	NEW CB 4	100	0.01	114.66	113.66	8"PVC
NEW CB 4	NEW CB 3	143	0.006	113.56	112.70	10"HDPE
CO 10	NEW CB 9	88	0.015	116.00	114.68	6"PVC
NEW CB 9	NEW CB 3	45	0.008	114.50	114.14	8"PVC
NEW CB 3	EX CB 14	85	0.006	112.60	112.09	12"HDPE
NEW CB 2	EX CB 14	96	0.005	112.98	112.50	8"PVC PERF
NEW CB 1	EX CB 14	65	0.005	112.82	112.50	8"PVC PERF


ANDREW D	MOTHERHOUSE SENIOR HOUSING	FST FAY, SPOFFORD & THORNDIKE ENGINEERS · PLANNERS · SCIENTISTS
ANDREW DY JOHNSTON NO 9994 G-24-15	SHEET TITLE GRADING, DRAINAGE AND EROSOIN CONTROL PLAN	100 YEAN 778 MAIN ST, SUITE 8, SOUTH PORTLAND, ME 04106 DRAWN: DED DATE: JUNE 2015 DESIGNED: ADJ SCALE: 1" = 40'
	MOTHERHOUSE	CHECKED: ADJ JOB NO. SP-M162
P.E. ANDREW D. JOHNSTO		FILE NAME: SP-M162 GRADING
LIC. #9994	ASSOCIATES LP	SHEET C6.0

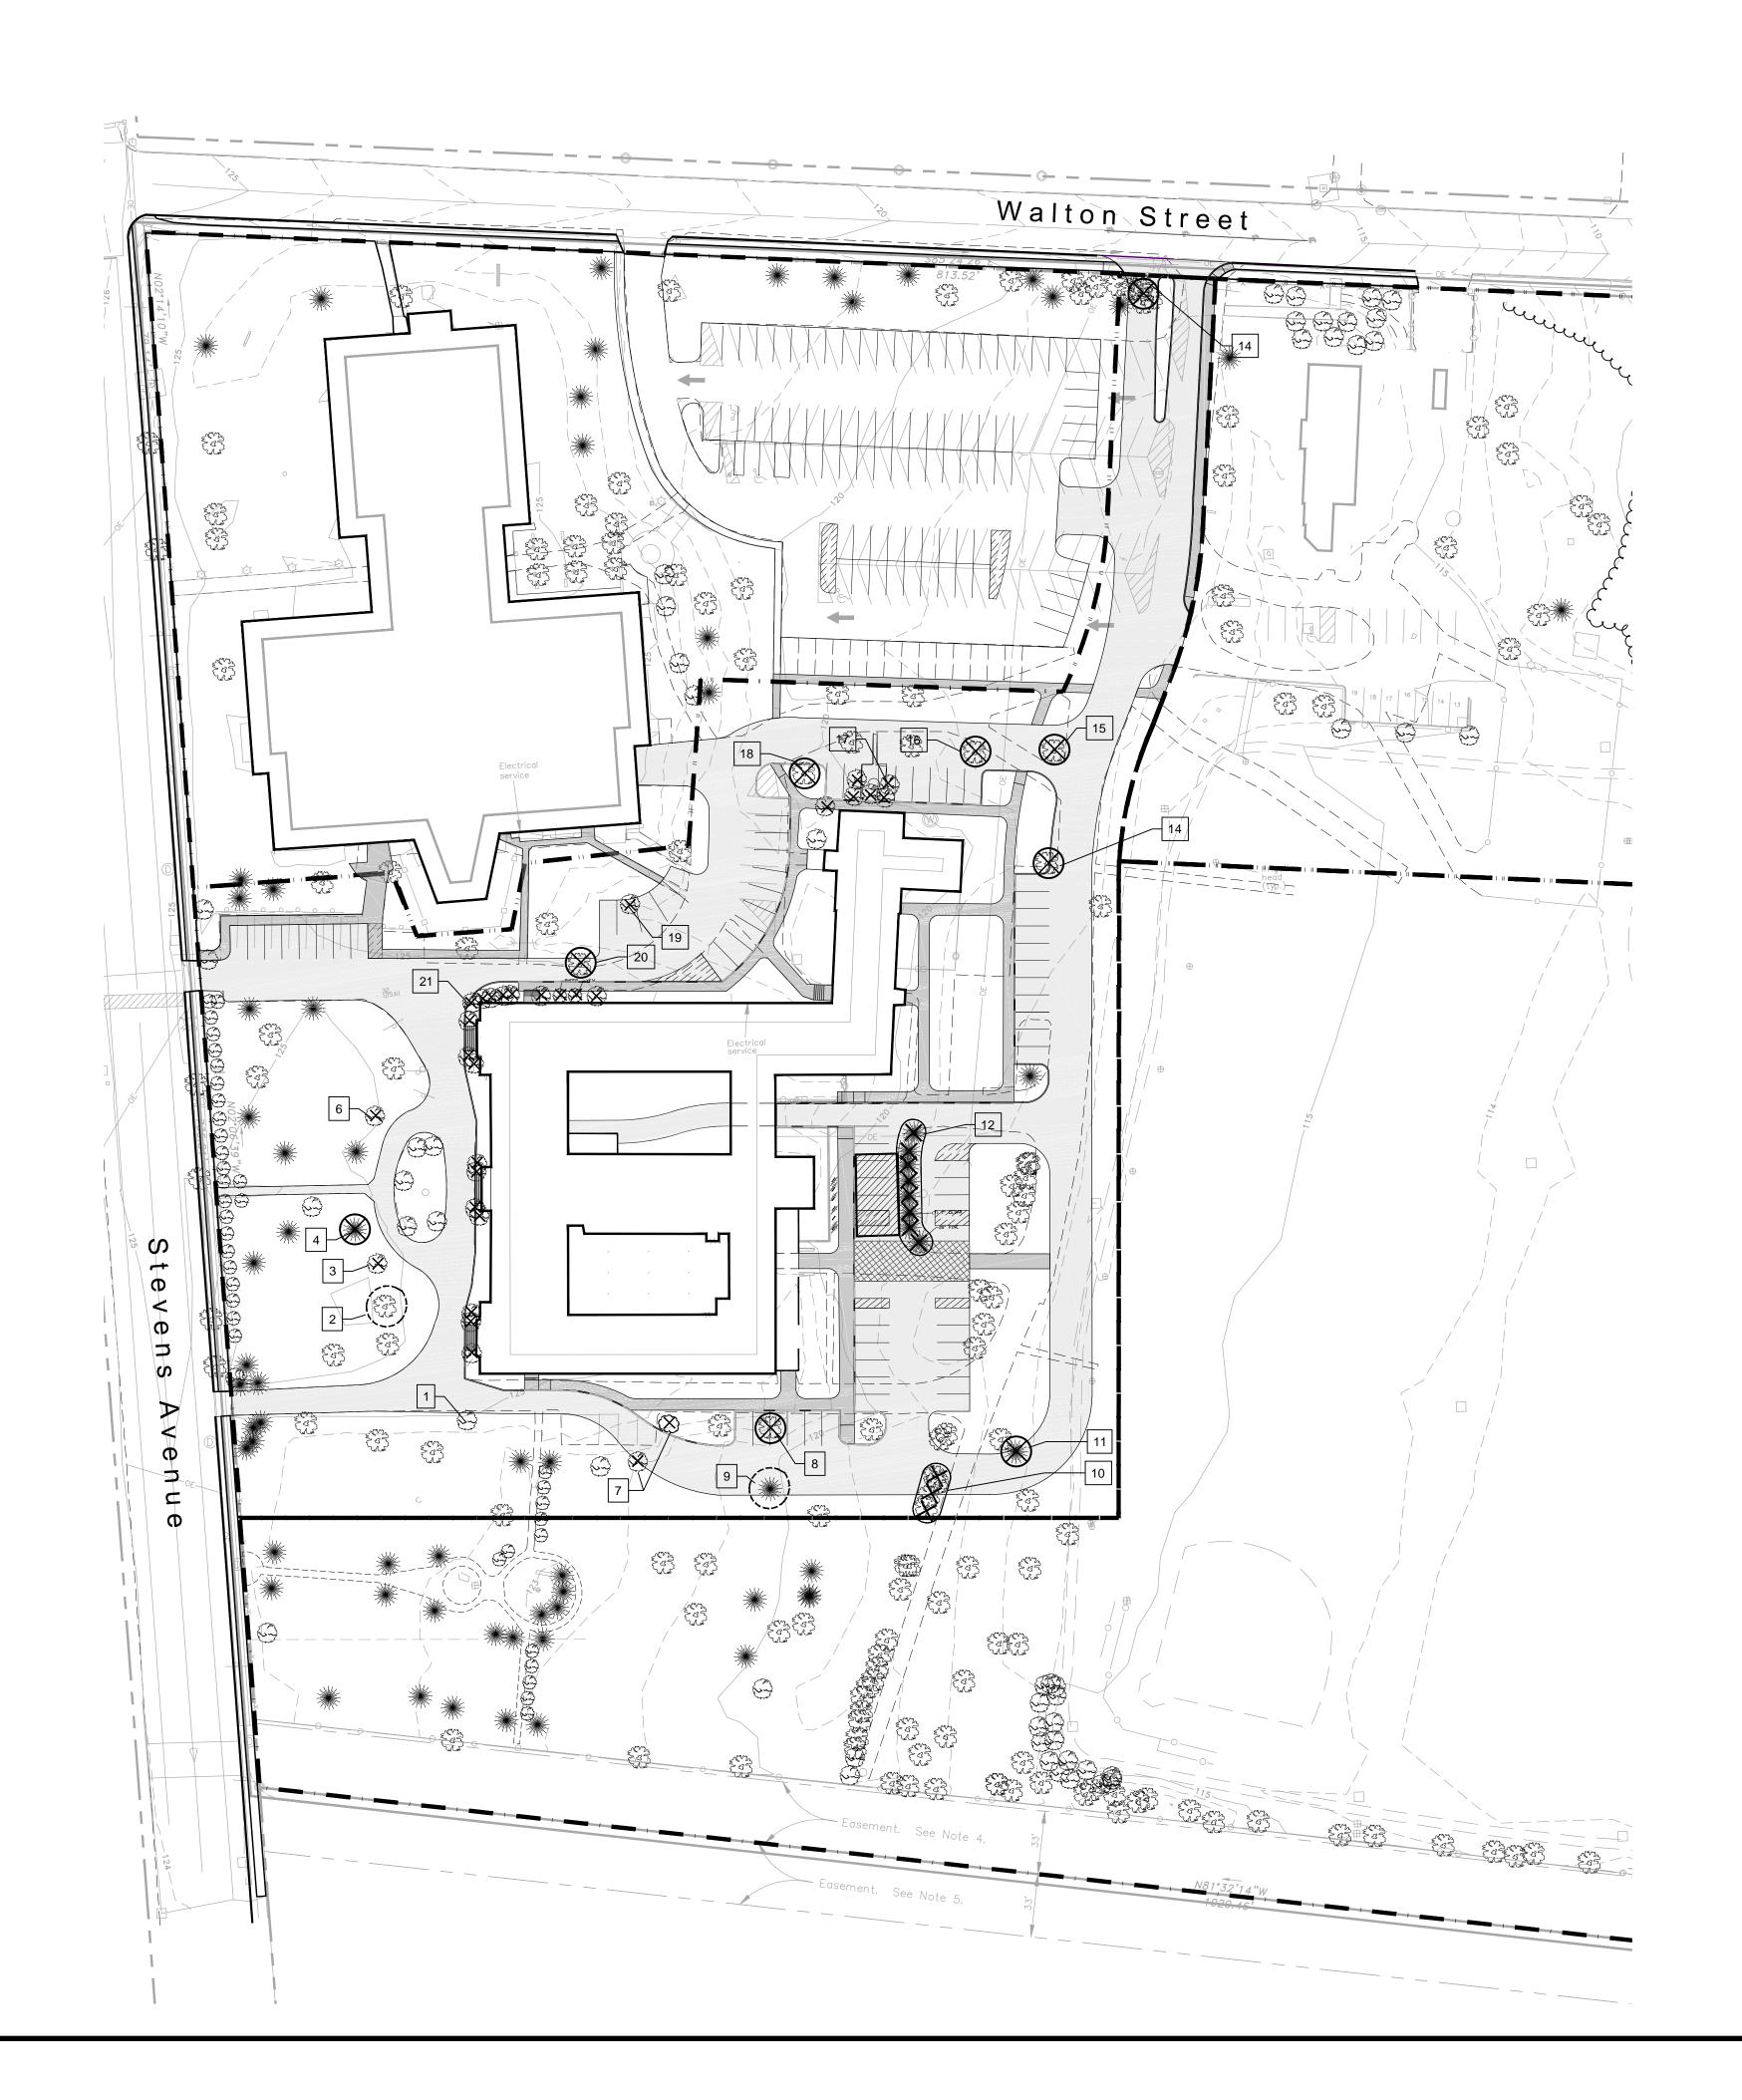

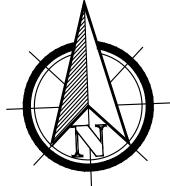

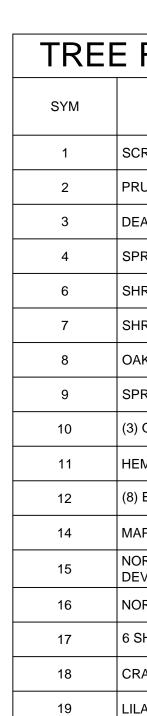




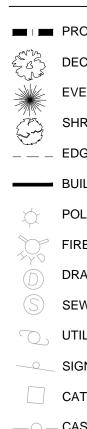

	SIZE / TYPE						
		REMOVE Y / N					
SCRAPPY HONEYSUCKLE - MAY WANT TO REMOVE	8" DEC	Y					
PRUNE	4" V	N			.		
DEAD SHRUB W/ INVASIVES GROWING IN IT	5" DEC	Y	A	PPLI		IT:	
SPRUCE IN BAD SHAPE	10" CON	Y	N	10TH	ERH	วบร	ЗЕ
SHRUB IN POOR CONDITION W/ INVASIVES GROWING IN IT	5" DEC	Y		SSO			
SHRUBS TO BE REMOVED	DEC	Y		00 COMM UITE 414		L STR	\EET
OAK TREE TO BE REMOVED FOR DEVELOPMENT	28" DEC	Y		ORTLAN 07.772.76		4101	
SPRUCE TO BE REMOVED AND RELOACATED	3" CON	Y					
(3) OAK TO BE REMOVED FOR DEVELOPMENT	18",18",12" DEC	Y				5	
HEMLOCK TO BE REMOVED FOR DEVELOPMENT	10"	Y				Ζ	
(8) EVERGREEN TREES TO BE REMOVED (1 PINE, 7 CEDAR)	(1) 20", (7) 7"	Y			$\dot{\mathbf{b}}$	ה	
MAPLE IN POOR SHAPE TO BE REMOVED FOR DEVELOPMENT	24" DEC	Y		Ē)]	Ď	
NORWAY MAPLE W/ SOME TRUNK ROT TO BE REMOVED FOR DEVELOPMENT	15" DEC	Y		Ĭ	É	C	
NORWAY MAPLE TO BE REMOVED	24" DEC	Y		Δ			
6 SHRUBS TO BE REMOVED (5 YEWS, 1 LILAC)	5' HT +/-	Y		Ш	ן ר	Y	
CRABAPPLE TO BE REMOVED	5" DEC	Y		그	- 7	5	
LILAC SHRUB TO BE RMOVED	5' HT +/-	Y					
PURPLE NORWAY MAPLE	26" DEC	Y			/ ▲ -		
(19 SHRUBS) REMOVE ALL FOUNDATION PLANTING SHRUBS, MOSTLY YEWS	3-4' HT	Y	Project:	2		N	
5 DECIDUOUS OAK TREES TO BE REMOVED	12", 12",12", 20",14"	Y	a a			-	<u> </u>
			Description				
			Date				
			Revisions				


LEGEND:	(PROP(OSED)	(TREE R	EMOVAL)		ERVAT
PROPERTY LINE DECIDUOUS TREE EVERGREEN TREE SHRUBS EDGE OF PAVING BUILDING OUTLINE POLE LIGHT FIRE HYDRANT D DRAIN MH S SEWER MH J SIGN CATCH BASIN CAST IRON FENCE X		PROPERTY LINE ZONE BOUNDARY DECIDUOUS TREE EVERGREEN TREE SHRUBS BIT CONC (ROADWAY) BIT CONC (SIDEWALK) SPECIAL PAVING RAINGARDEN GROUNDCOVER EDGE OF PAVING CURB CROSSWALK STRIPING POLE LIGHT TRAFFIC SIGNAGE		TREE TO BE REMOVED GROUP OF TREES TO BE REMOVED SHRUB TO BE REMOVED TREE TO BE PRUNED OR RELOCATE	Phase Proved B Lawn By: E.K. Approved B LAN 217	SE: PERMITTING SE: PERMITTING SE: PERMITTING SE: PERMITTING SE: SE: SE: SE: SE: SE: SE: SE: SE: SE:
500'	25' 0'	SCALE: 1"= 50' 50' 100		200'		UNE 24, 2015 et No:

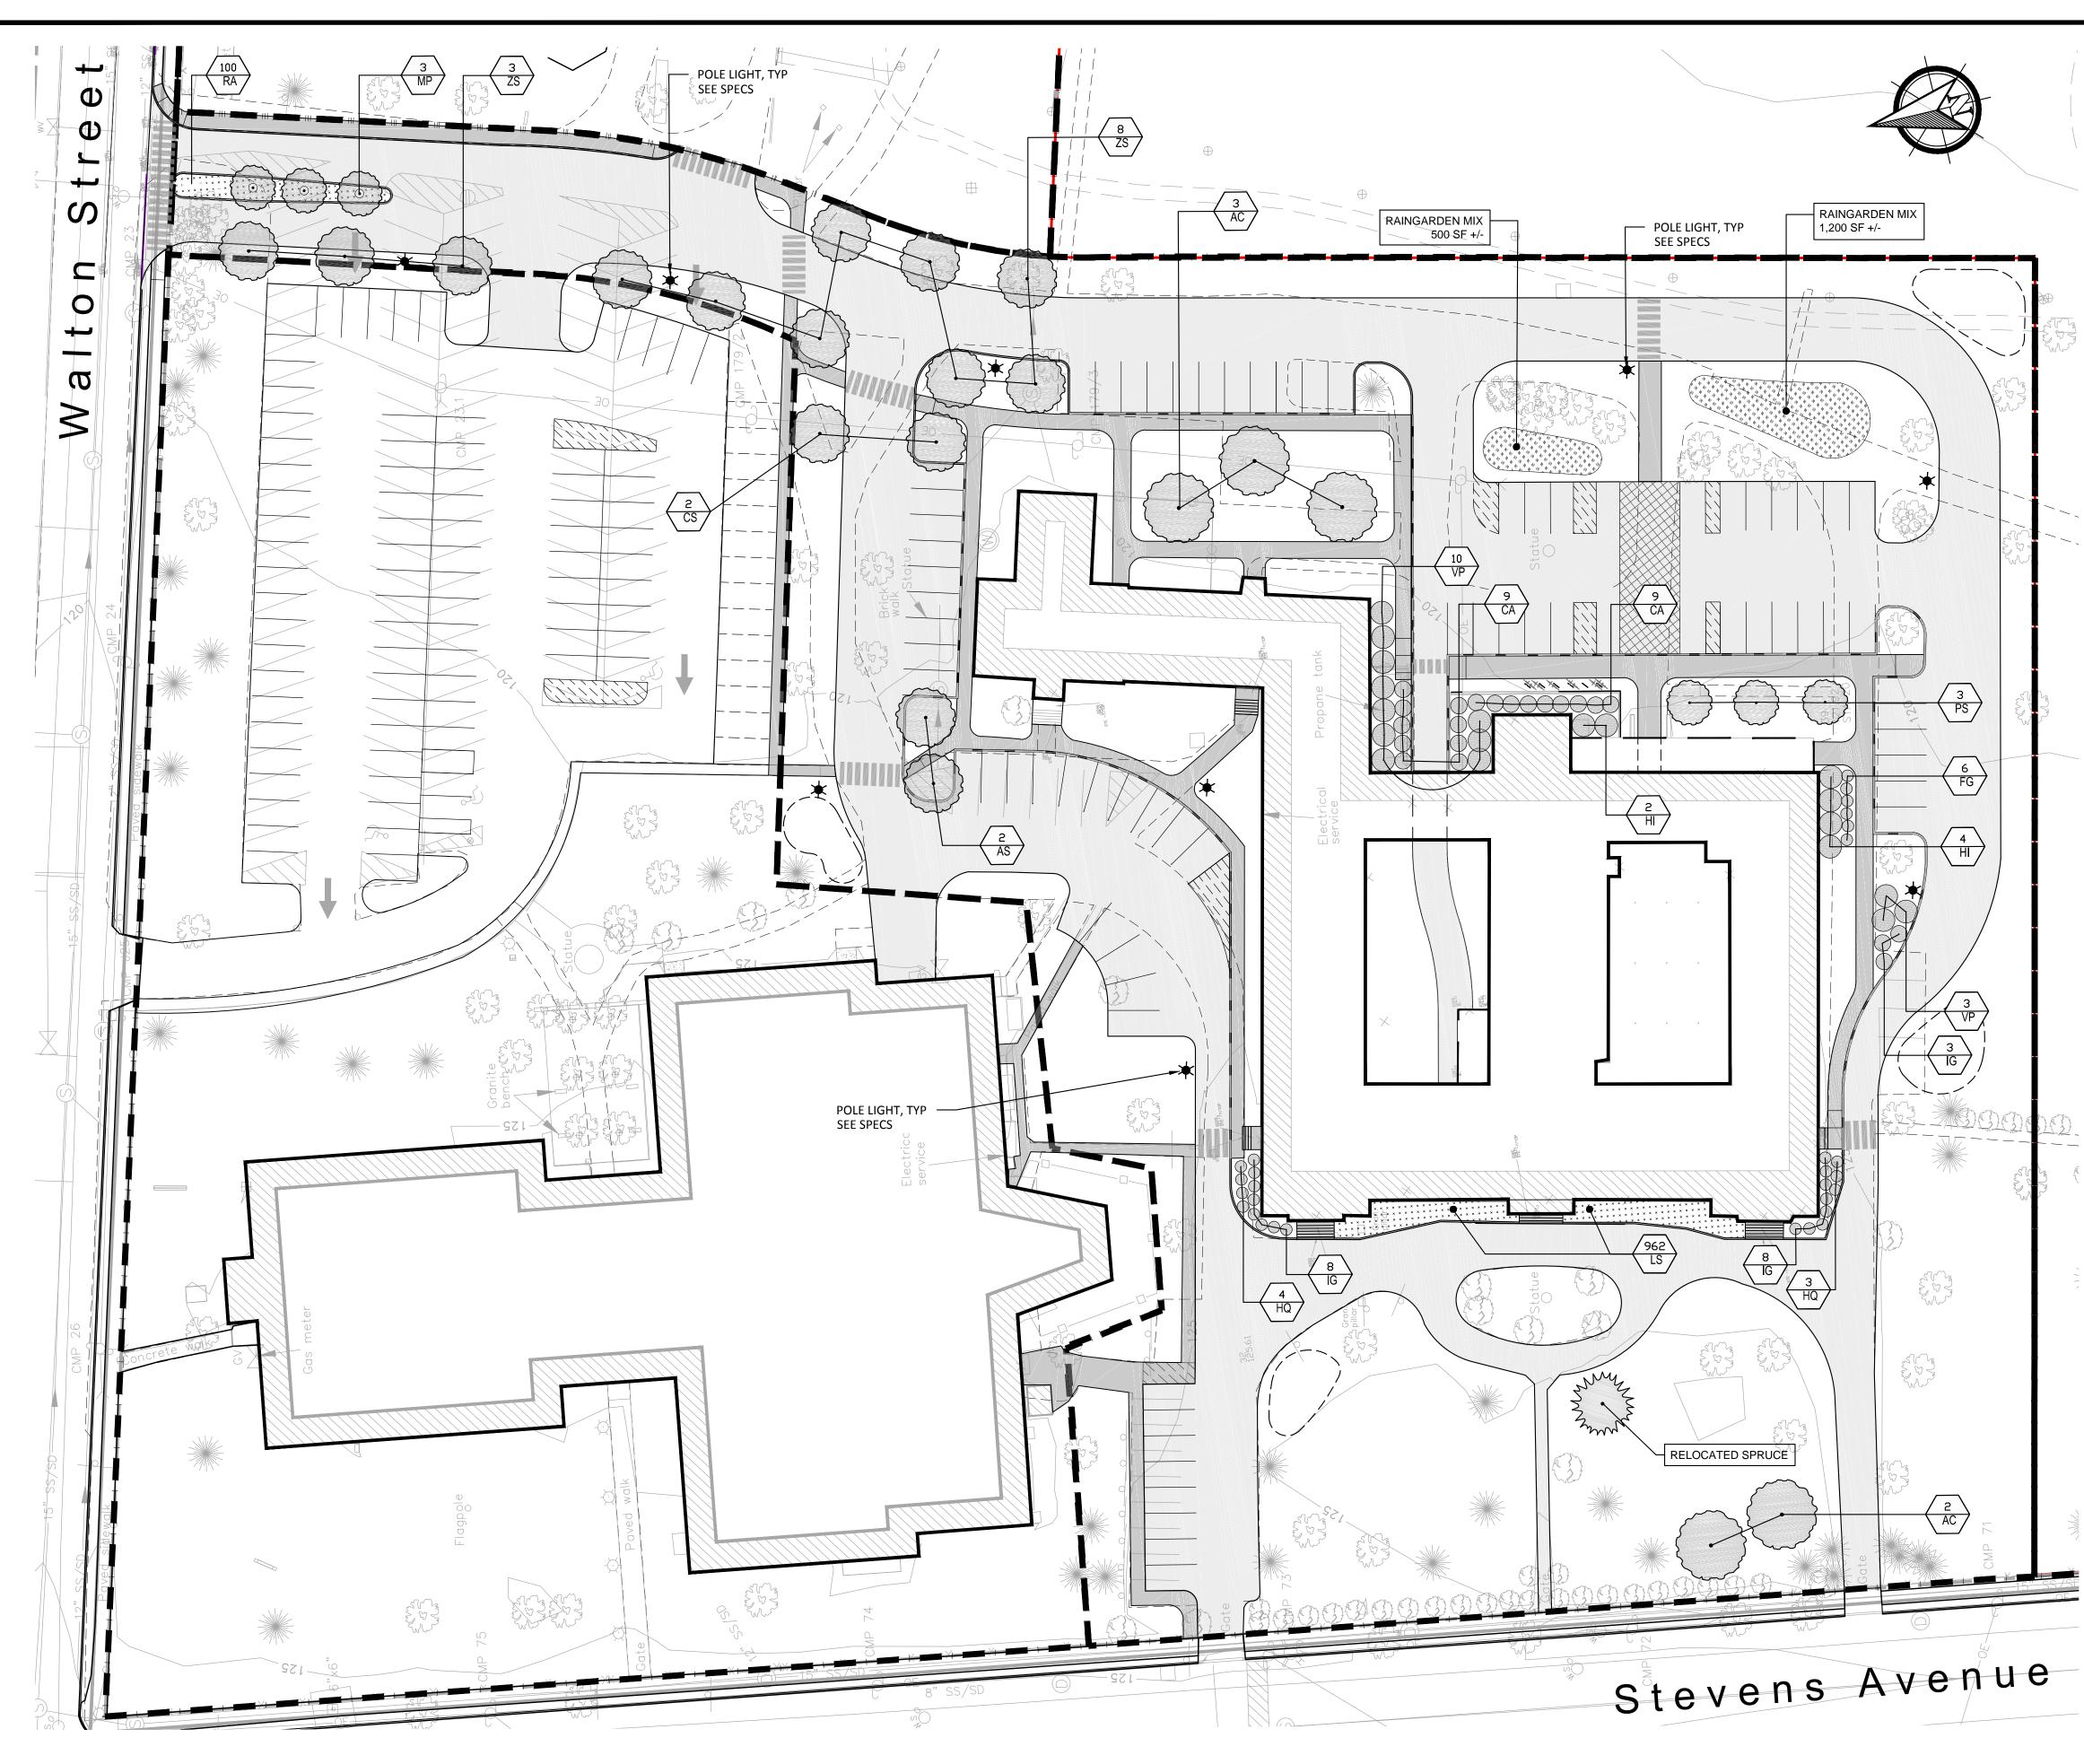


LANT	LIST - T	TREES				PLAN	IT LIST S	SHRUBS, GROUNDCOVERS, GRASSES				
	SYM	BOTANICAL NAME	COMMON NAME	SIZE	REMARKS	QT	Y SYN	BOTANICAL NAME	COMMON NAME	SIZE	REM	1AR
(AR	Acer rubrum	Red Maple	3" -3 ½" CAL.	B&B	X	CA	clethra alnifolia ' September Beauty'	Sweet Pepperbush	# 7	CON	١T
Х	AS	Acer saccharum 'Green Mountain'	Green Mountain Sugar Maple	3"-3 ½" CAL.	B&B	X	FG	Fothergilla gardenii	Dwarf Fothergilla	# 7	COI	NŢ
<	AC	Aesculus x carnea 'Briotii'	Red Horsechestnut	3"-3 ½" CAL.	B&B	X	HI	Hamamelis intermedia 'Arnold Promise'	Witchhazel	4-5'	B&B	}
Х	AG	Amelanchier x grandiflora 'Autumn Brilliance'	Serviceberry	6'-7' HT.	MULTI STEMMED CLUMP	X	HC	hydrangea quercifolia 'Ruby Slipper''	Oakleaf Hydrangea	# 5	CON	Τ
Х	CS	Catalpa speciosa	Northern Catalpa	3"-3 ½" CAL.	B&B	X	IG	Ilex Galabra 'Densa'	Densa Inkberry	# 7	CON	Γ
Х	MP	Malus 'Prairiefire'	Flowering Crabapple	2"-2 ½" CAL.	B&B	Х	LS	liriope spicata	Creeping Liriope	1 qt	CONT	Γ
Х	PA	Platanus x acerifolia	London Planetree	3"-3 ½" CAL.	B&B	X	M) microbiota decussata	Siberian Carpet Cypress	#3	CON	Г
Х	PS	Prunus sargentii	Sargent Cherry	2"-3" CAL.	B&B	X	RA	rhus aromatica 'Gro-Low'	Fragrant Sumac	#2	CON	Г
Х	ZS	Zelcova serrata ' Green Vase'	Zelcova	3"-3 1/2" CAL.	B&B	X	VP	Viburnum p.t. 'Shasta'	Shasta Doublefire Viburnum	4-5'	B&B	


PLANT LIST - RAIN GARDEN MIX							
QUANTITY	SYB.	BOTA					
36		andropogon scop					
26		deschampsia ces					
18		cornus sericea 'fa					
18		vaccinium corybo					
60		iris versicolor					
60		aster novae-anglia					
30		eupatorium fistulos					
60		rudbeckia fulgida					
60		echinacea purpure					

CONTINU MEANS A 2. CONTRAC SHOWN SCHEDU ADDITIO	CTOR SHALL BEGIN MAINTENAI JE UNTIL FINAL ACCEPTANCE. AND METHODS OF WATERING A CTOR SHALL SUPPLY PLANTS I ON THE PLAN. ANY DISCREPA LE AND THOSE REQUIRED ON NAL RENUMERATION. ANY DES APE ARCHITECT PRIOR TO ORI	CONTRACTOR AND MAINTENAN IN QUANTITIES S NCY BETWEEN T THE PLAN SHAL SCREPANCIES SI	SHALL BE R ICE. SUFFICIENT THE QUANTI IL NOT ENTI HALL BE CL	ESPONSIBLE FOR A TO COMPLETE WOF ITIES SHOWN IN THI TLE THE CONTRACT	LL RK E PLANT	-	
	ERIALS SHALL CONFORM TO SI			ERICAN STANDARDS	S FOR	AF	PLICANT:
NURSER 4. ALL PLAN	Y STOCK (LATEST EDITION) AS YMEN. ITS SHALL BEAR THE SAME RE BEFORE DIGGING.					AS	OTHERHOUSE SOCIATES LP
5. THE LANI YEAR FF	DSCAPE CONTRACTOR SHALL ROM DATE OF SUBSTANTIAL CO	OMPLETION.				SUIT POR	COMMERCIAL STREE TE 414 RTLAND, ME 04101 772.7673
7. ALL PLAN 8. NO PLAN	Y AND AT THE SITE. IT BEDS SHALL MEET MINIMUM T MATERIAL SHALL BE INSTALL	LED UNTIL GRUB	BING, BED I		,		В В С
 ALL PLAN DARK, 3 CONTRA PRIOR CONTR ROUGH PRIOR ALL PLA WRAPF REMOV ALL BRO BEGINN ALL PLA LANDSO REQUIF 	G HAS BEEN COMPLETED IN TH NTS BEDS AND TREE WELLS SI SHREDDED BARK MULCH. ACTOR SHALL SUBMIT SOIL SA TO INSTALLATION. SOIL ADMIX ACTOR) IF DEEMED NECESSA GRADING AND BED PREPARAT TO PLANT INSTALLATION. CON PRIOR TO REQUIRED SITE VIS NTS SHALL BE BALLED AND W PING AND CONTAINER MATERIA (ED AT THE TIME OF PLANTING DAD LEAF EVERGREEN PLANTS NING OF THEIR FIRST WINTER. NTS SHALL BE INSTALLED AS F CAPE CONTRACTOR SHALL RE REMENTS.	HALL HAVE A MI MPLE AND TEST XTURE SHALL BI RY BY SOIL TES TION SHALL BE A NTRACTOR SHA SIT. RAPPED OR COI AL MADE OF SYN S. S SHALL BE SPR PER DETAILS AN EFER TO THE CO	NIMUM OF 3 OF TOPSO E ADDED TO T RESULTS. APPROVED I LL NOTIFY L NTAINER GF NTHETICS O AYED WITH ID THE CON DNTRACT SF	IL TO LANDSCAPE A D EXISTING SOIL (B) BY LANDSCAPE ARC ANDSCAPE ARCHIT ROWN AS SPECIFIED R PLASTICS SHALL AN ANTIDESSICANT ITRACT SPECIFICAT PECIFICATIONS FOR	ARCHITECT CHITECT TECT 48 D. ALL ROOT BE TAT THE TONS. THE ADDITIONAL	Project:	MOTHERHOU SENIOR HOUS
16. THE LAN CONTR 17. THE LAN SPECIF	ACTOR SHALL STAKE TREES IF IDSCAPE CONTRACTOR SHALL ACT SPECIFICATIONS. IDSCAPE CONTRACTOR SHALL ICATIONS FOR SEASONAL REG ND SEASON OF PLANTING.	L PROVIDE PREF L REFER TO THE	PARED SOIL	PLANTING MIX AS	PER THE	ns Date Description	
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2 TREE PLANTING SCALE:1"=1'-0"

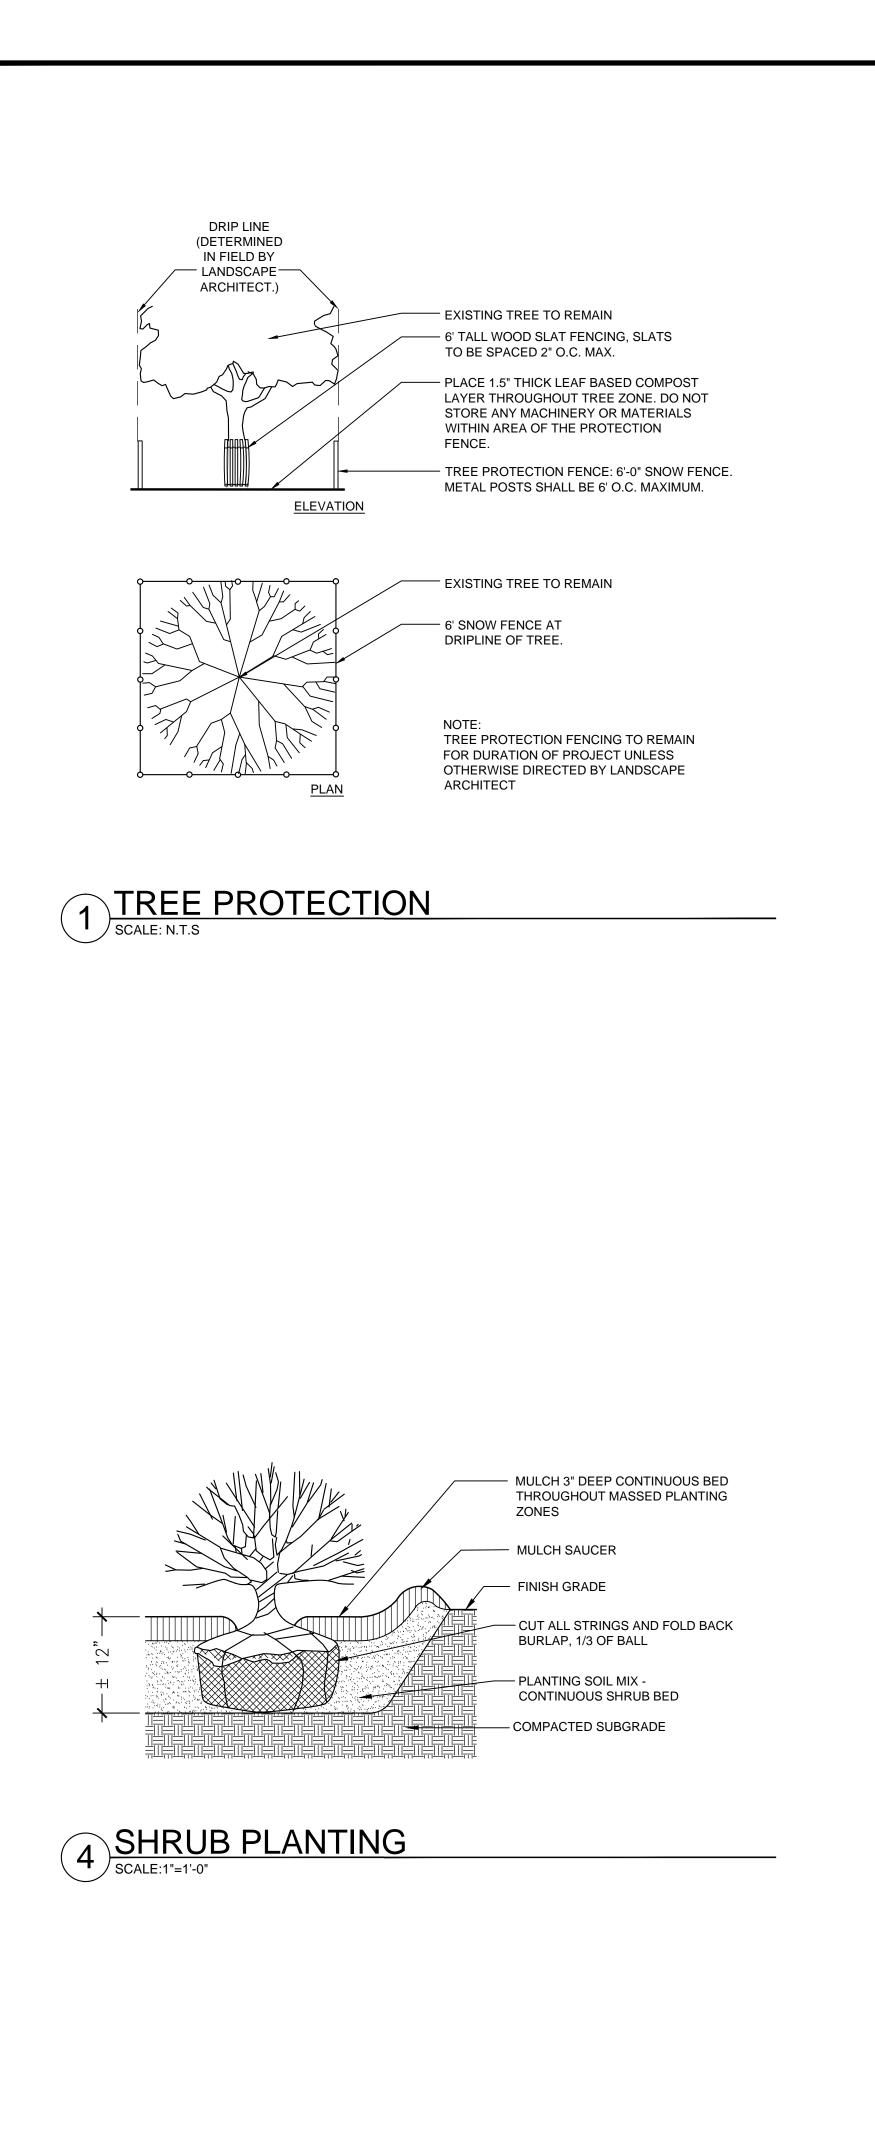


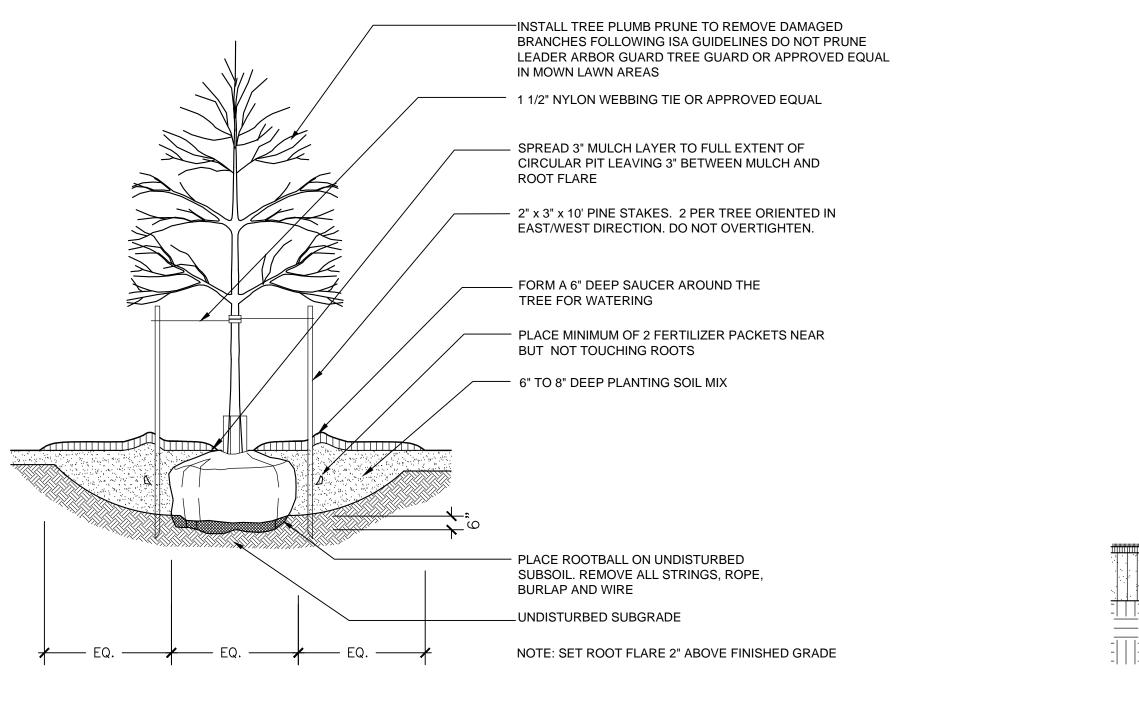 CONTINUOUS BED - 3" MULCH MULCH SAUCER


- BACKFILL MIXTURE

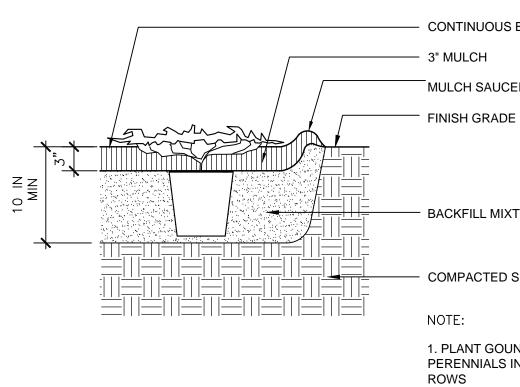
- COMPACTED SUBGRADE

1. PLANT GOUNDCOVER OR PERENNIALS IN STAGGERED ROWS

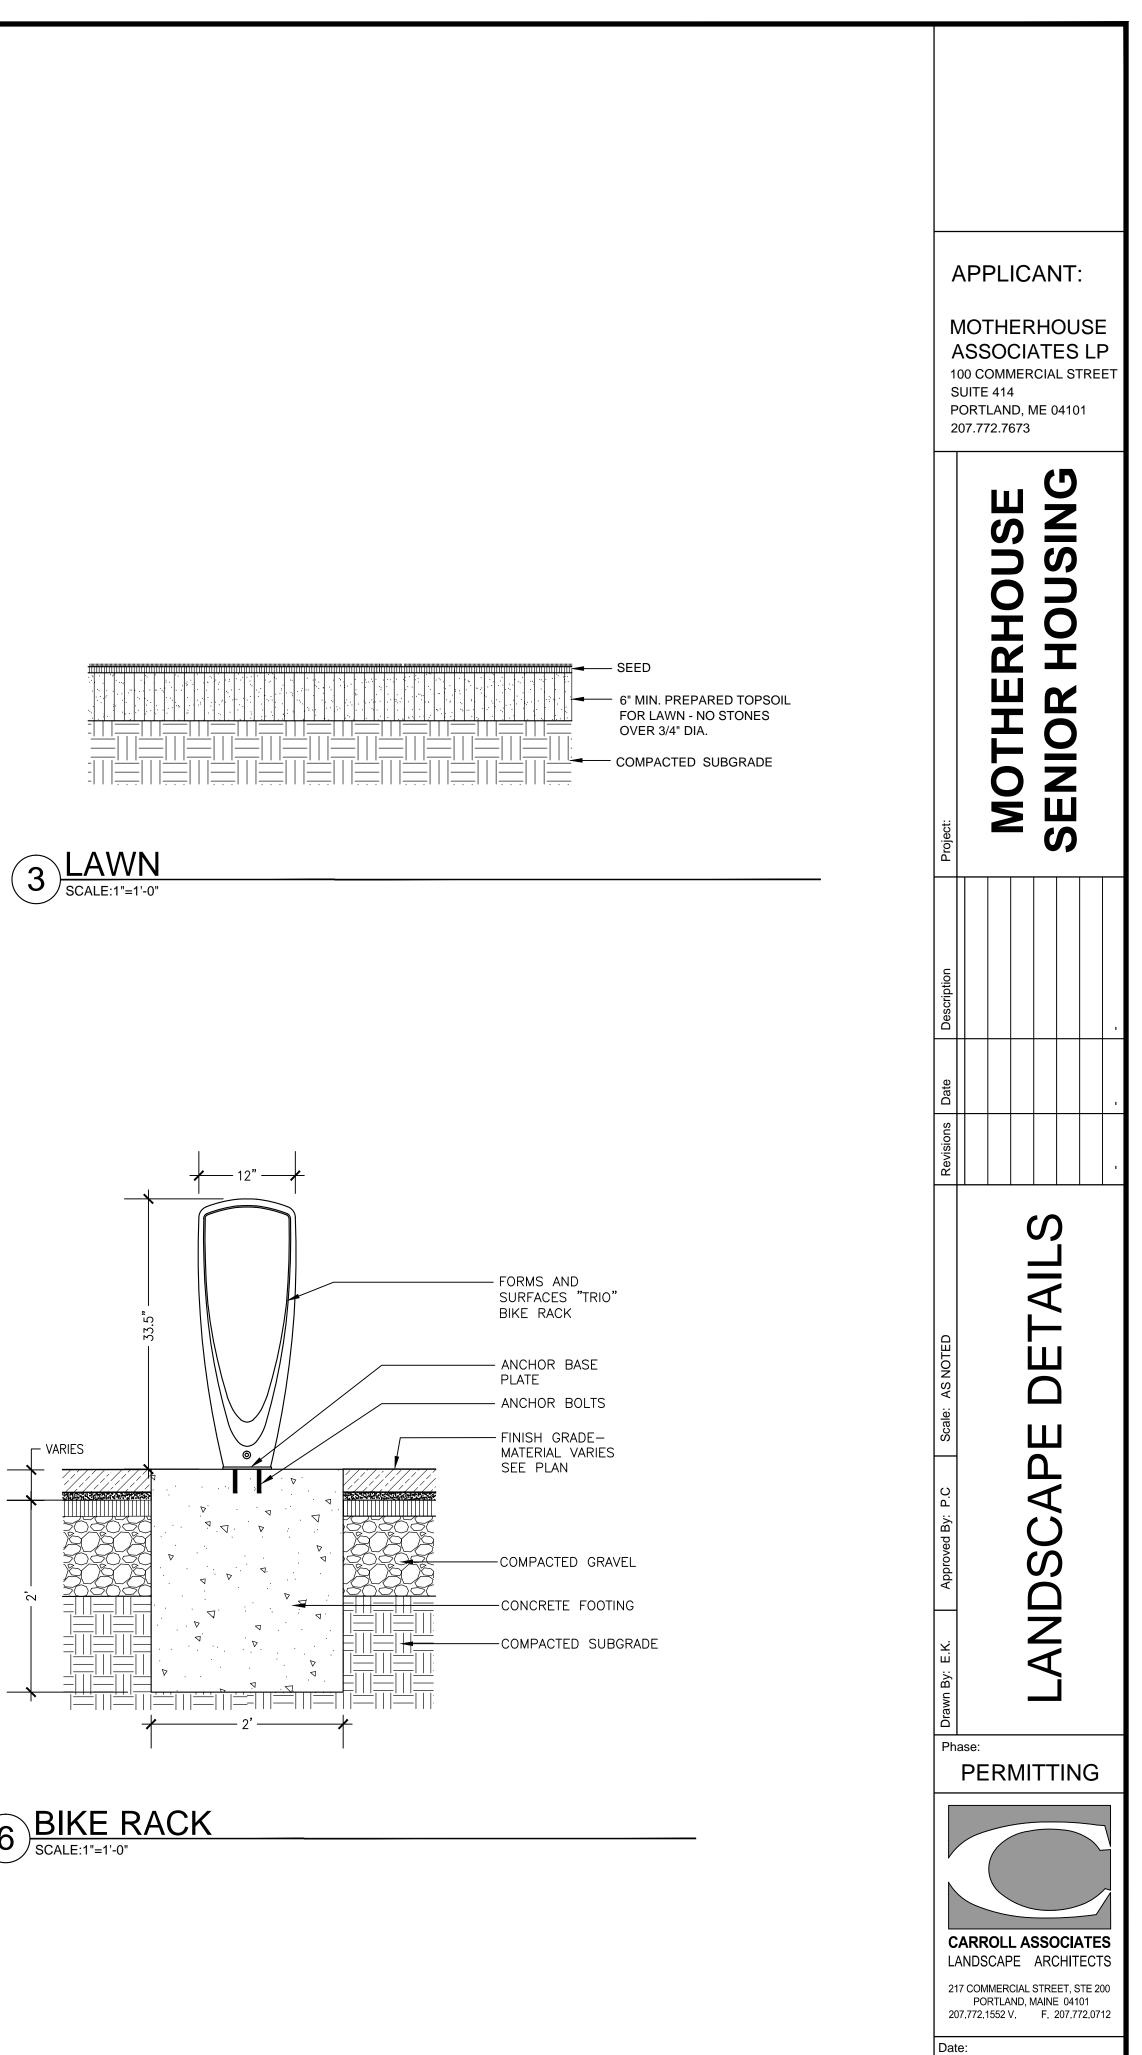



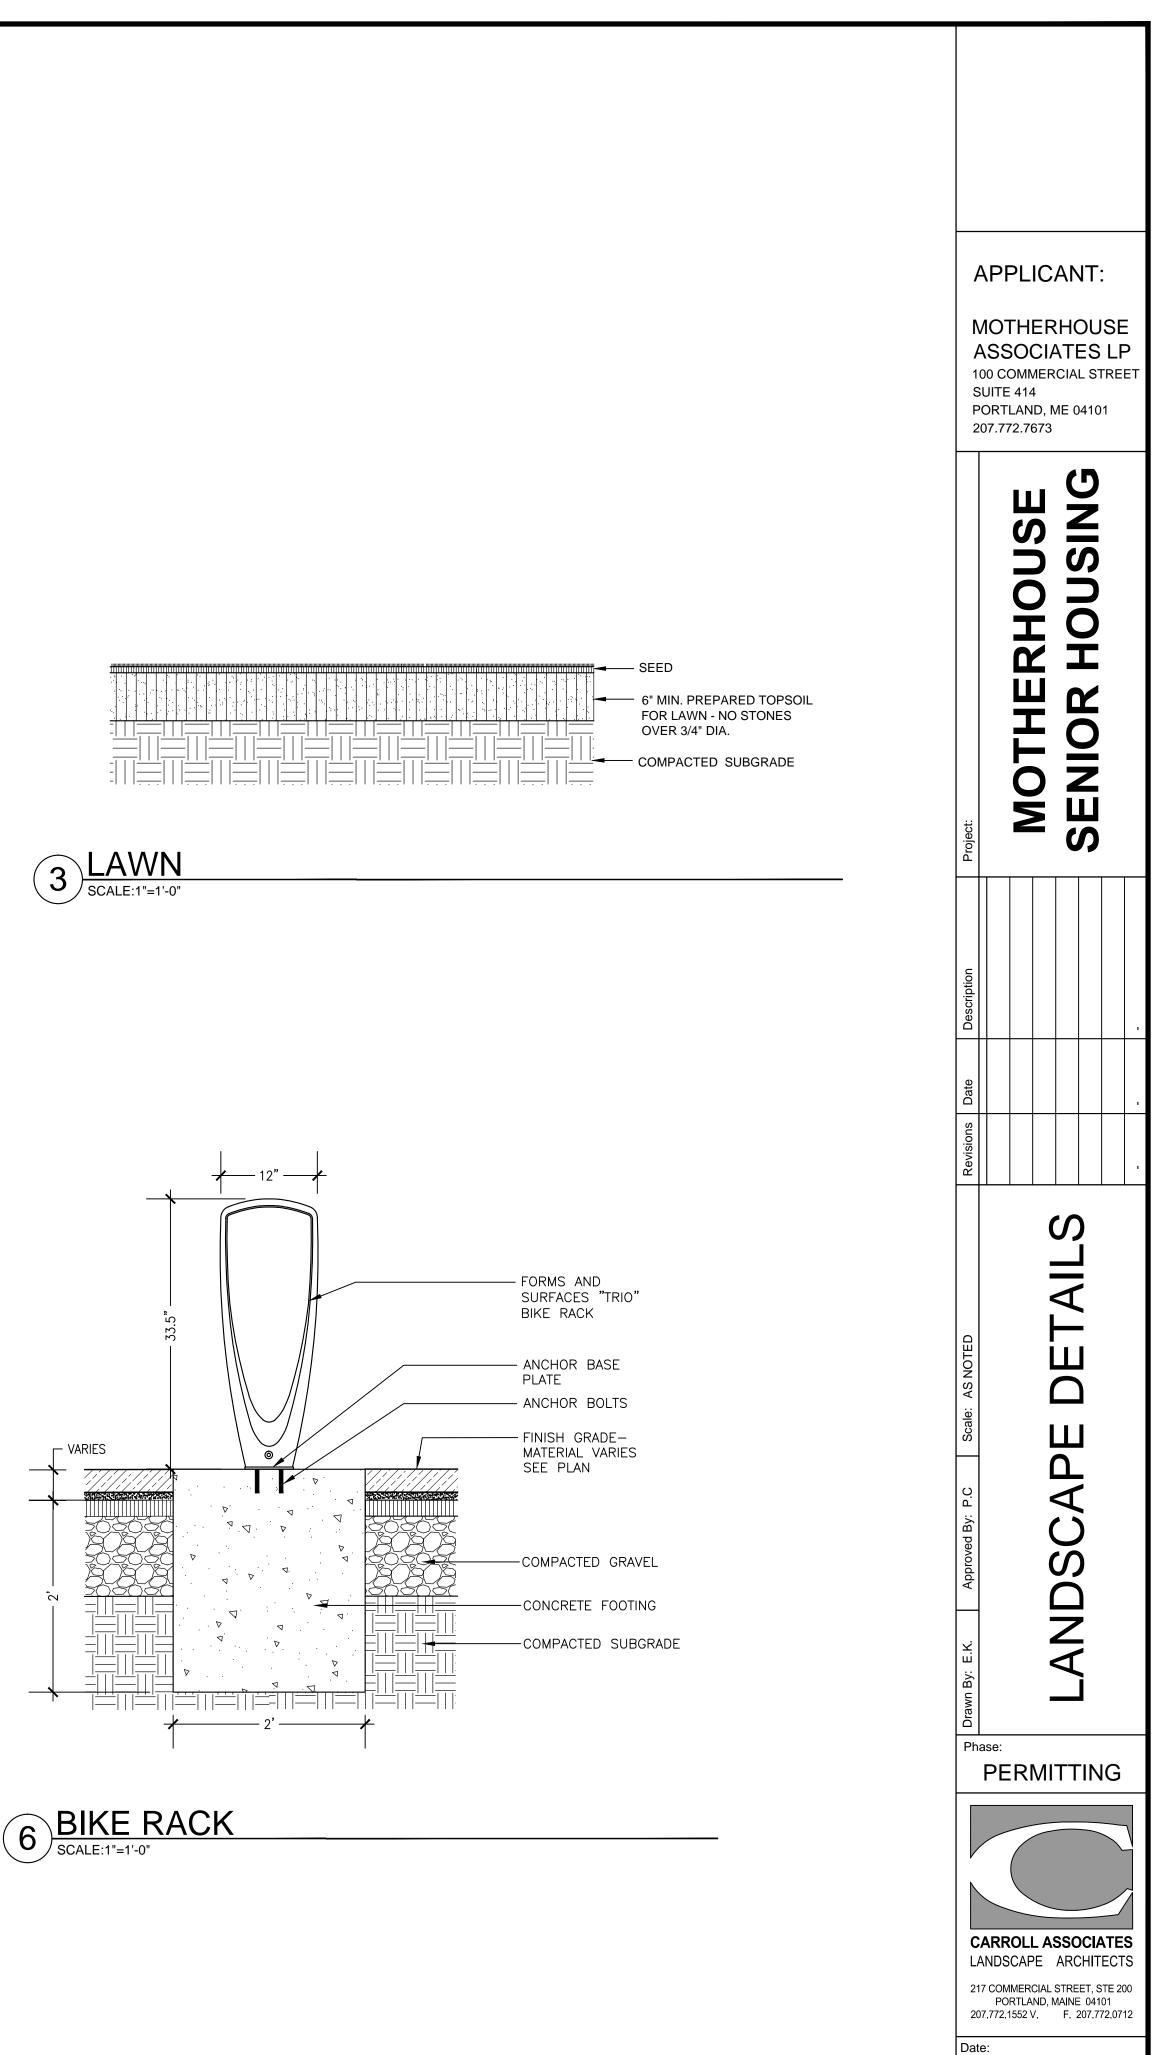


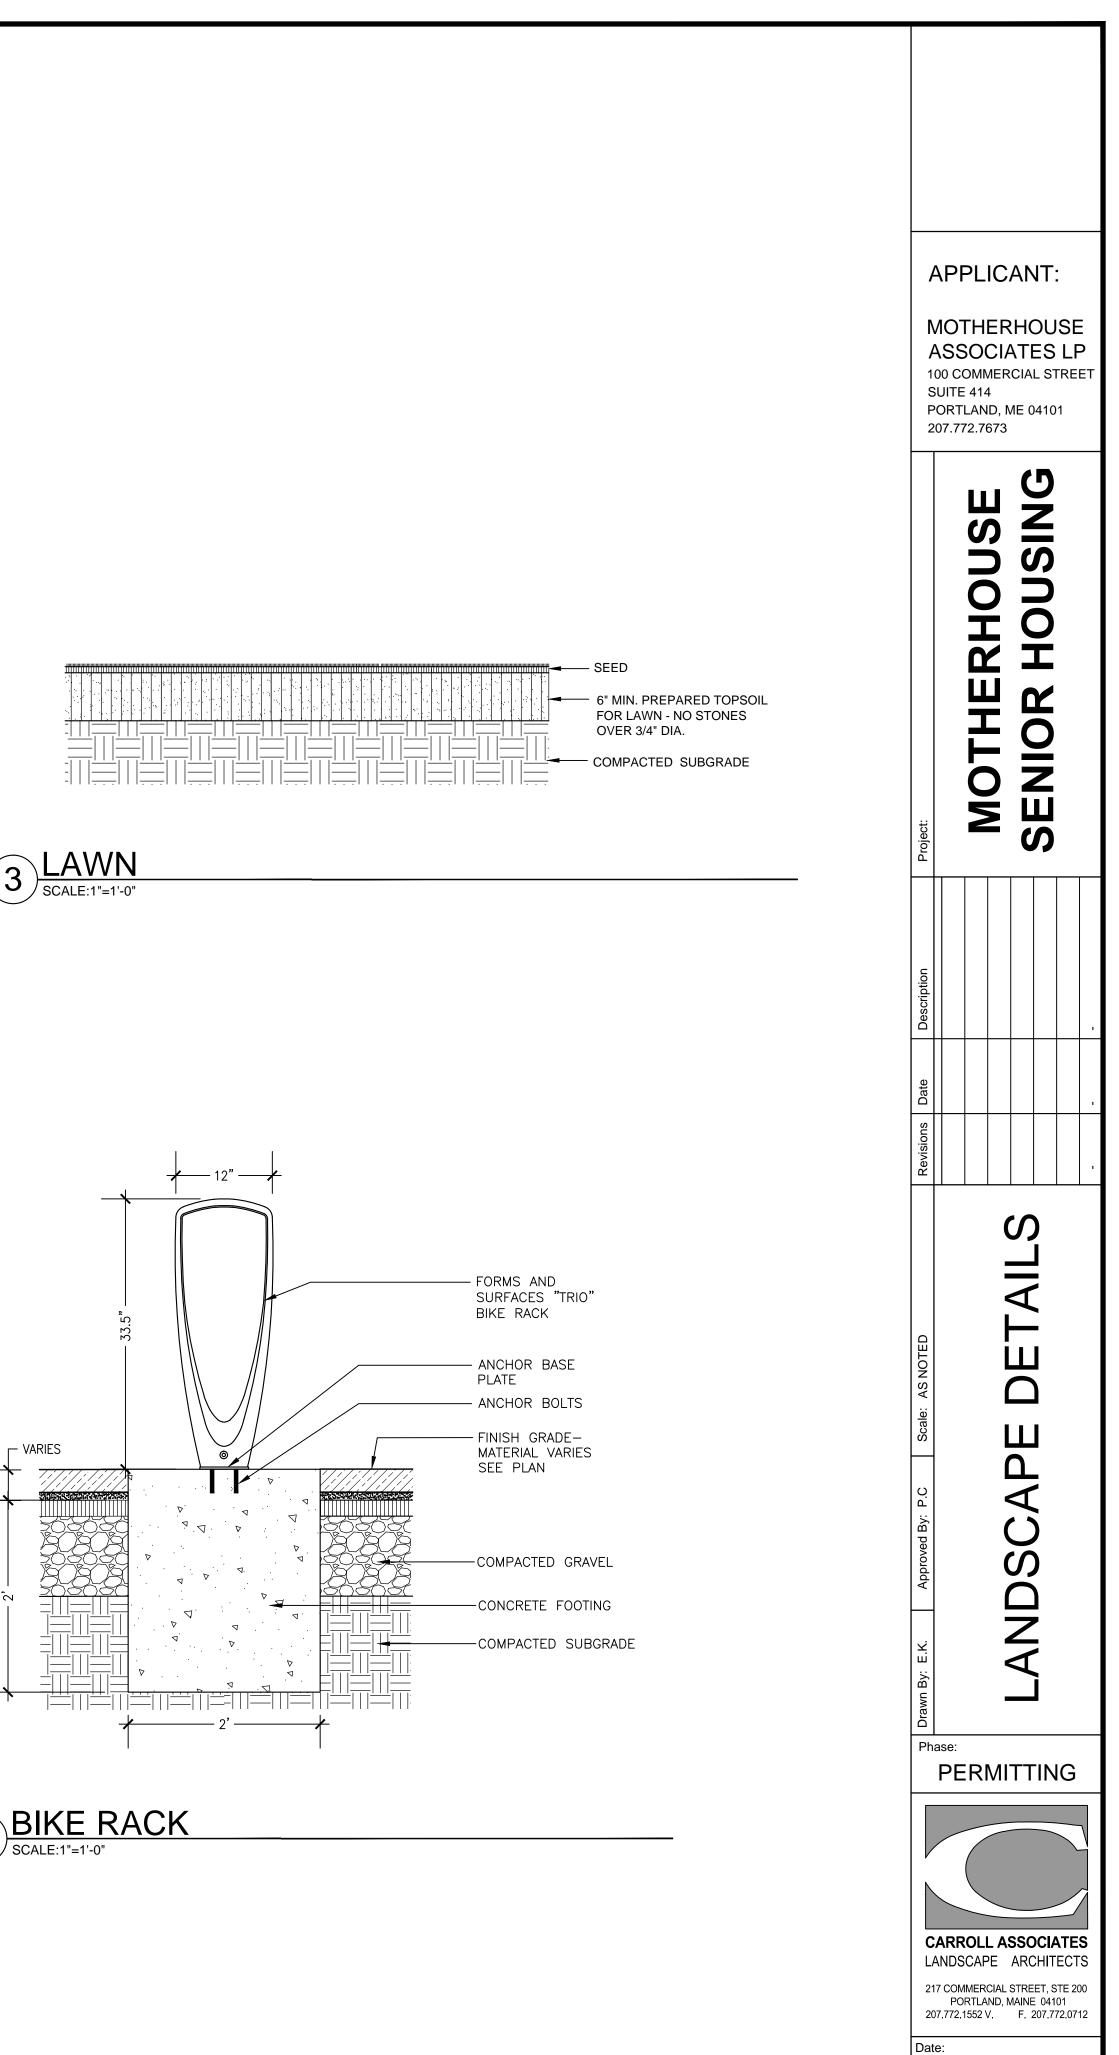

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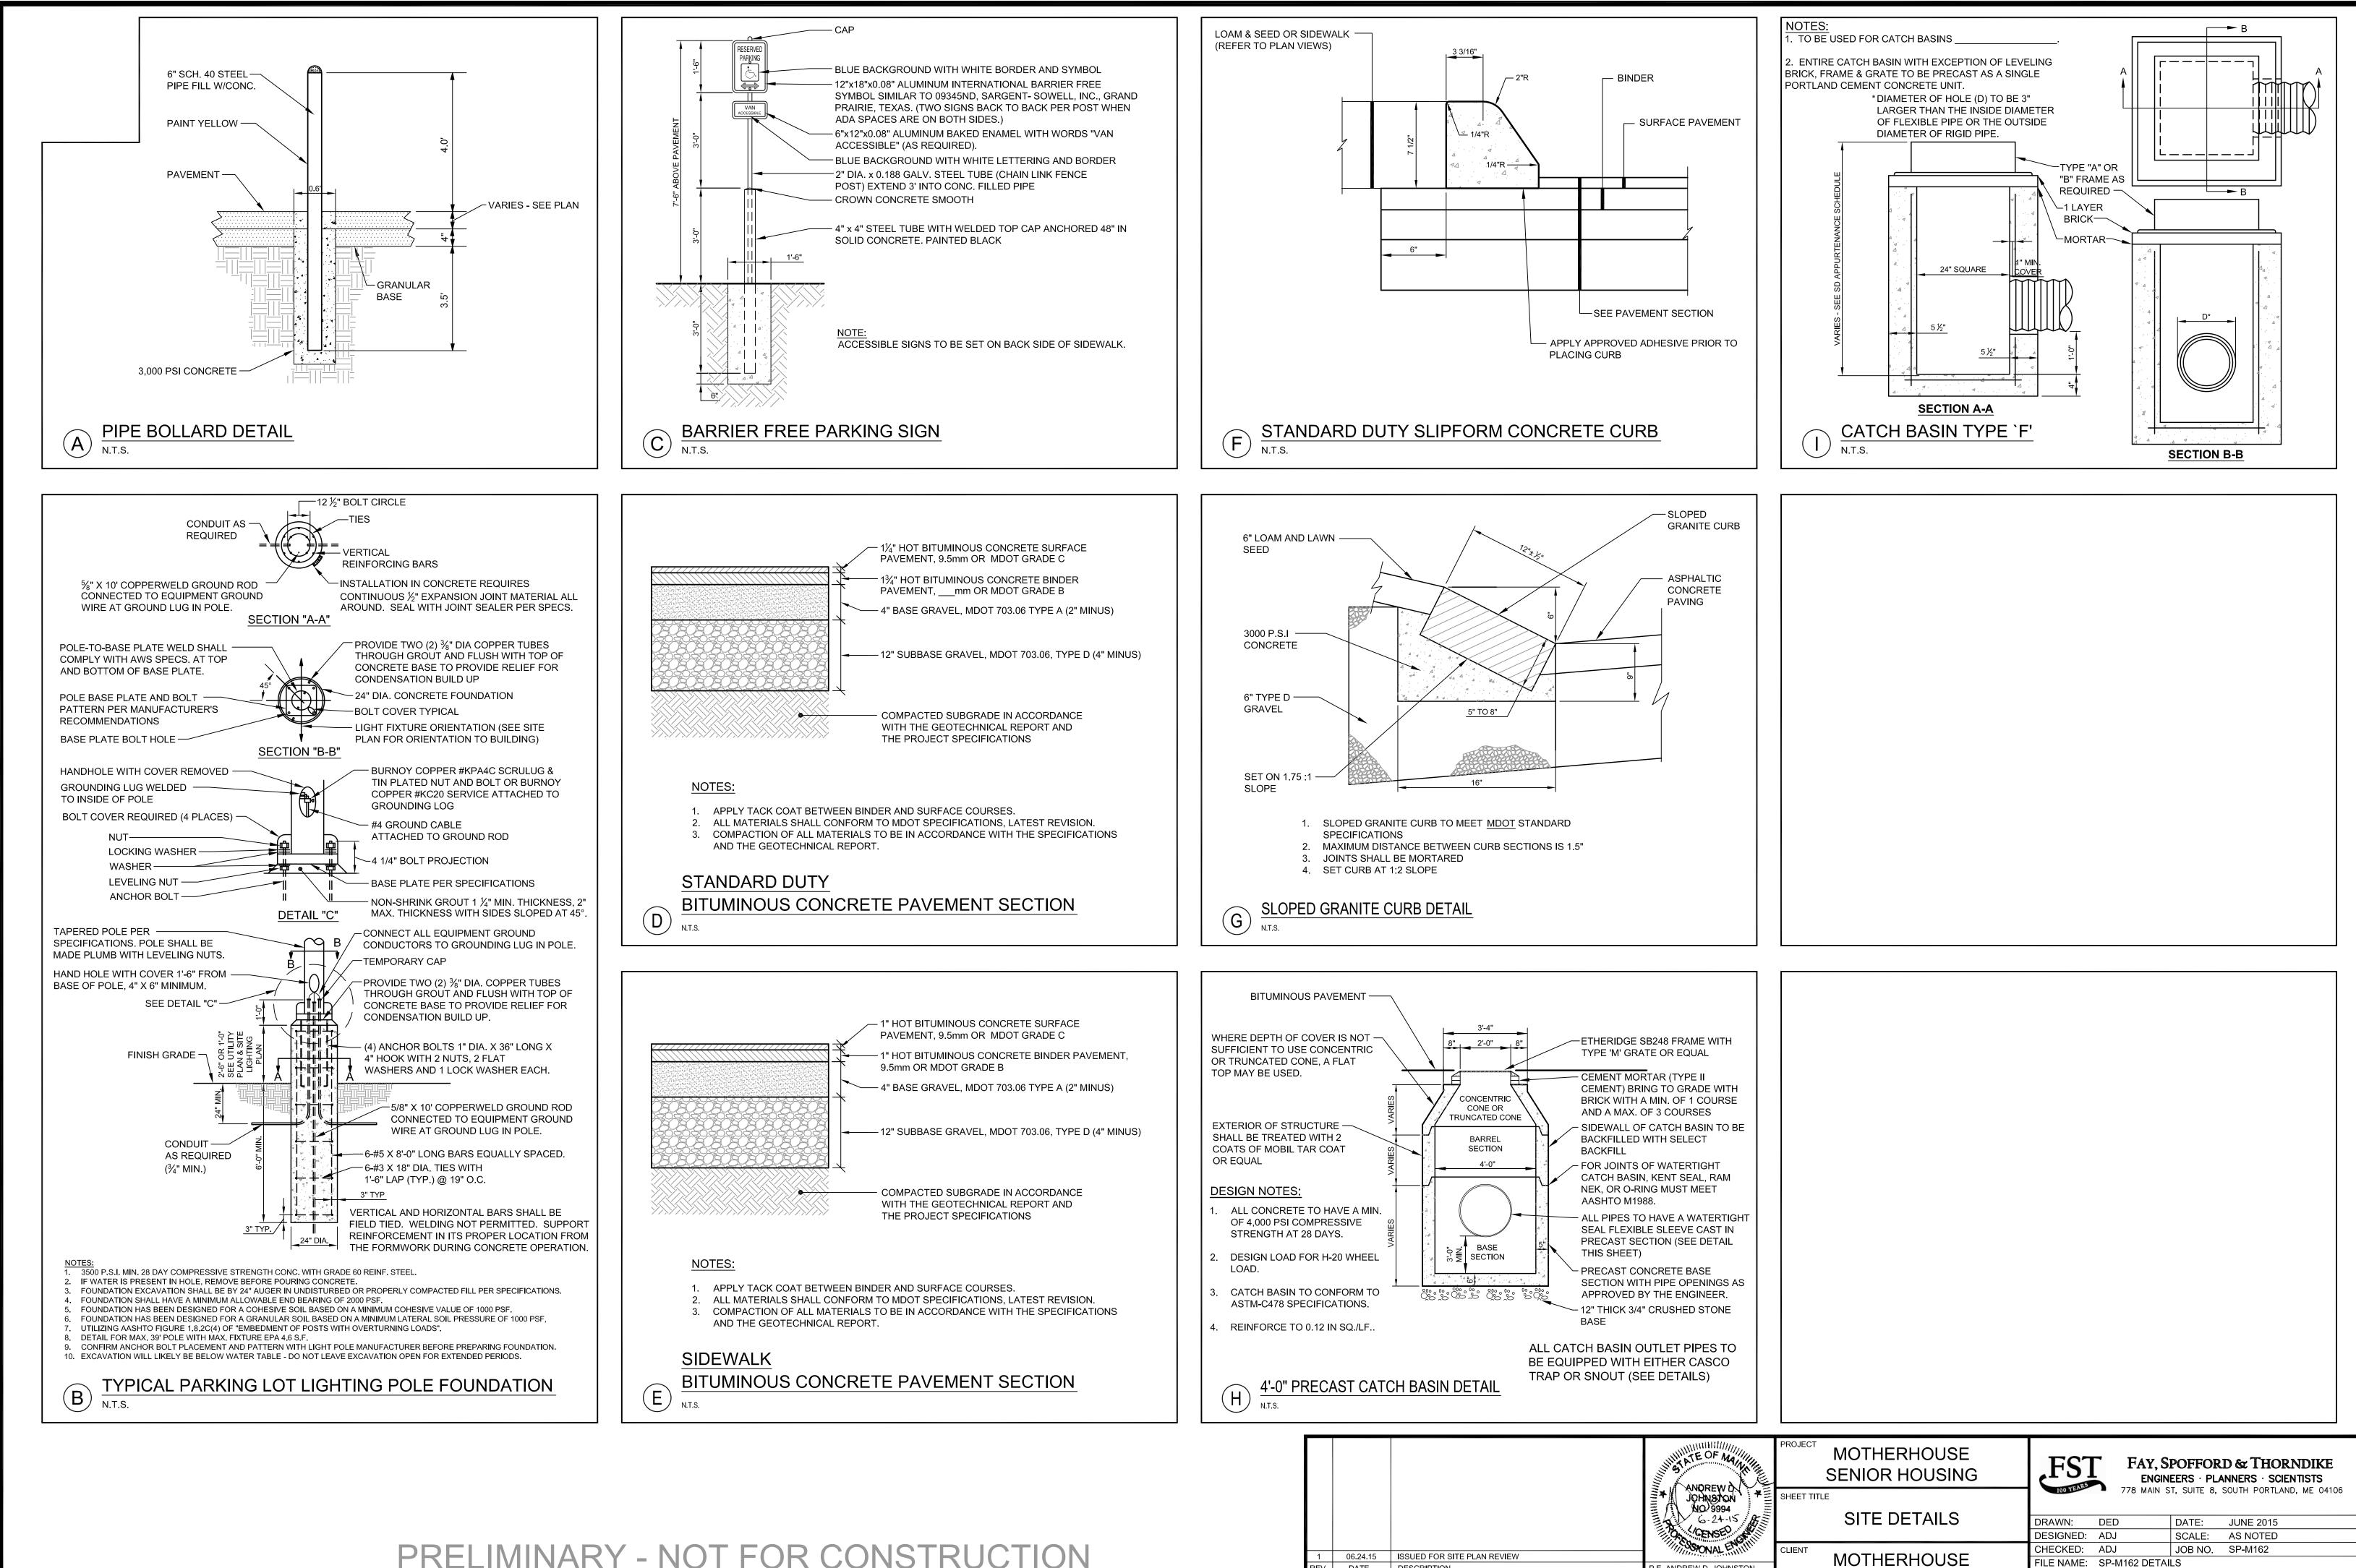


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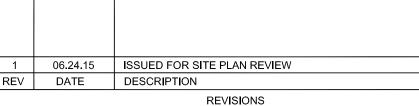
06.24.15 ISSUED FOR SITE PLAN REVIEW DATE DESCRIPTION

REVISIONS

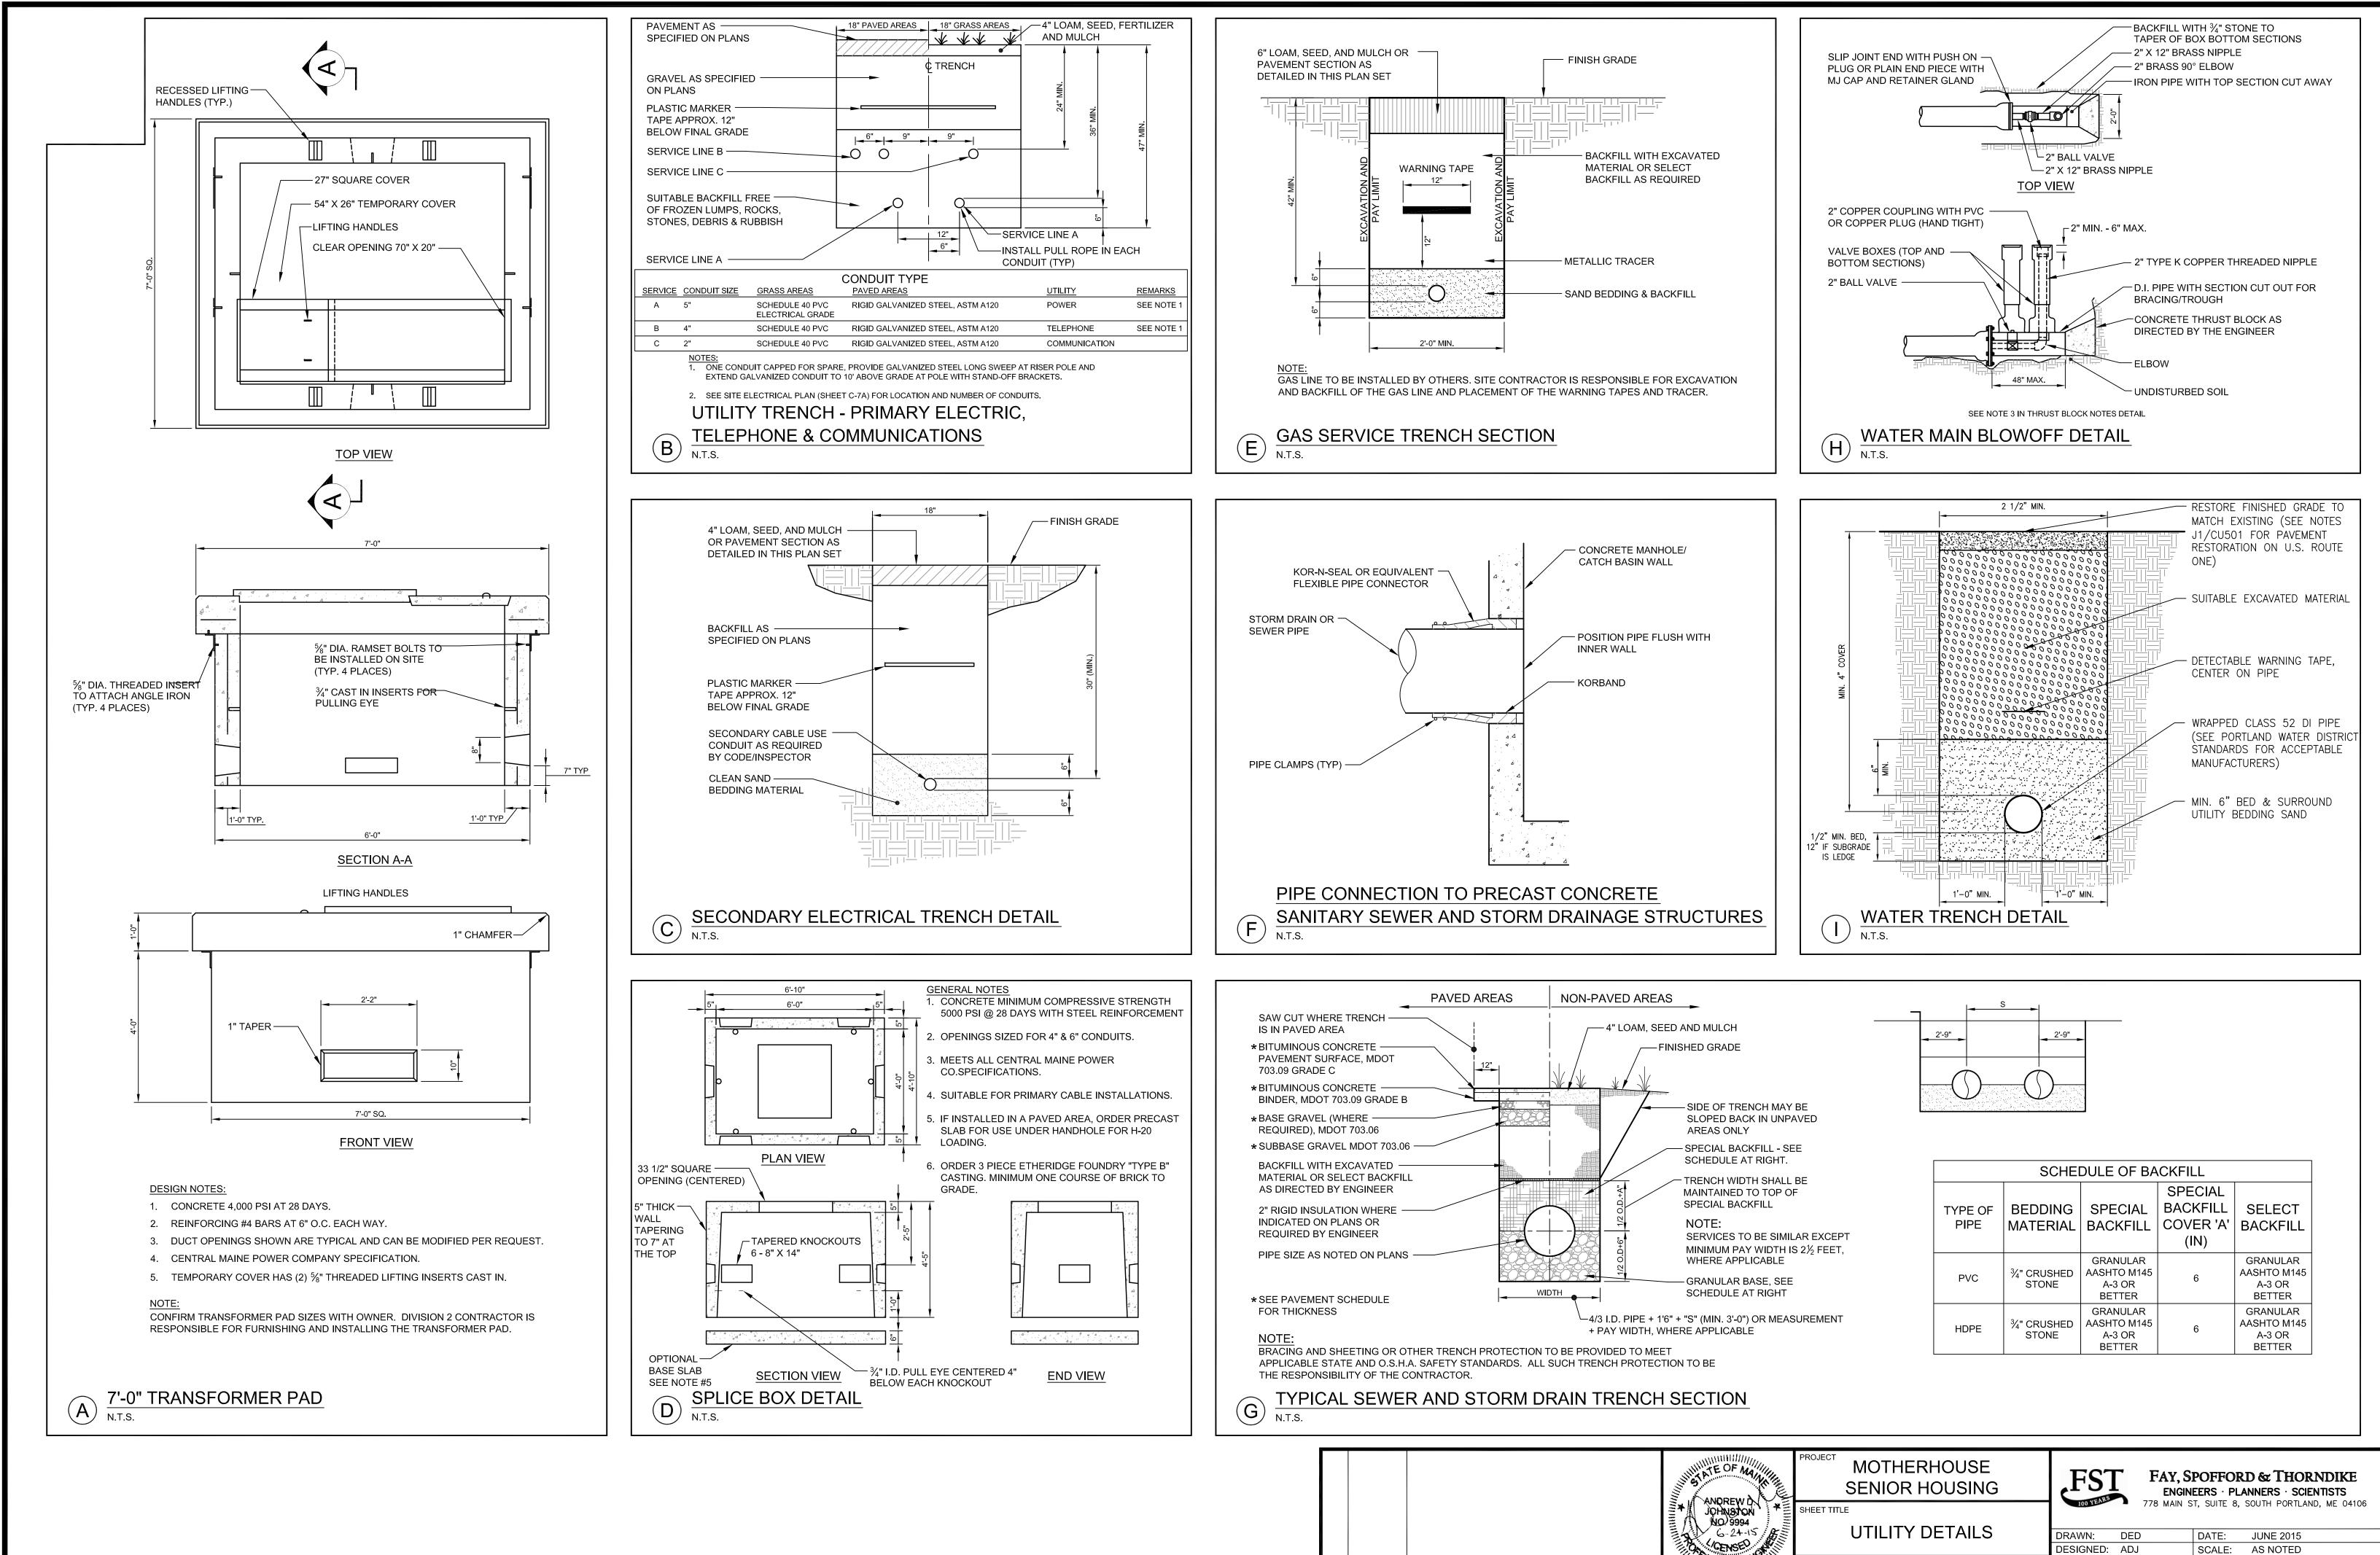TE OF MA	MOTHERHOUSE SENIOR HOUSING		Y, SPOFFORD & THORNDIKE ENGINEERS · PLANNERS · SCIENTISTS
		100 Year 7/8 K	MAIN ST, SUITE 8, SOUTH PORTLAND, ME 04106
6-24-15 6	UTILITY DETAILS	DRAWN: DED	DATE: JUNE 2015
CENSE		DESIGNED: ADJ	SCALE: AS NOTED
MINSONAL EMILIA		CHECKED: ADJ	JOB NO. SP-M162
P.E. ANDREW D. JOHNSTON	MOTHERHOUSE	FILE NAME: SP-M162	DETAILS
LIC. #9994	ASSOCIATES LP	SHEET	C7.0
	P.E. ANDREW D. JOHNSTON	ANDREW D. JOHNSTON P.E. ANDREW D. JOHNSTON MOTHERHOUSE SENIOR HOUSING MOTHERHOUSE SENIOR HOUSING UTILITY DETAILS CLIENT MOTHERHOUSE	MOTHERHOUSE ANDREW D. JOHNSTON JOHNSTON JOHNSTON G-24-15 UTILITY DETAILS DRAWN: DED DESIGNED: ANDREW D. JOHNSTON



PRELIMINARY - NOT FOR CONSTRUCTION



.E. ANDREW D. JOHNSTON


LIC. #9994

ASSOCIATES LP

FILE NAME: SP-M162 DETAILS

SHEET

C7.1

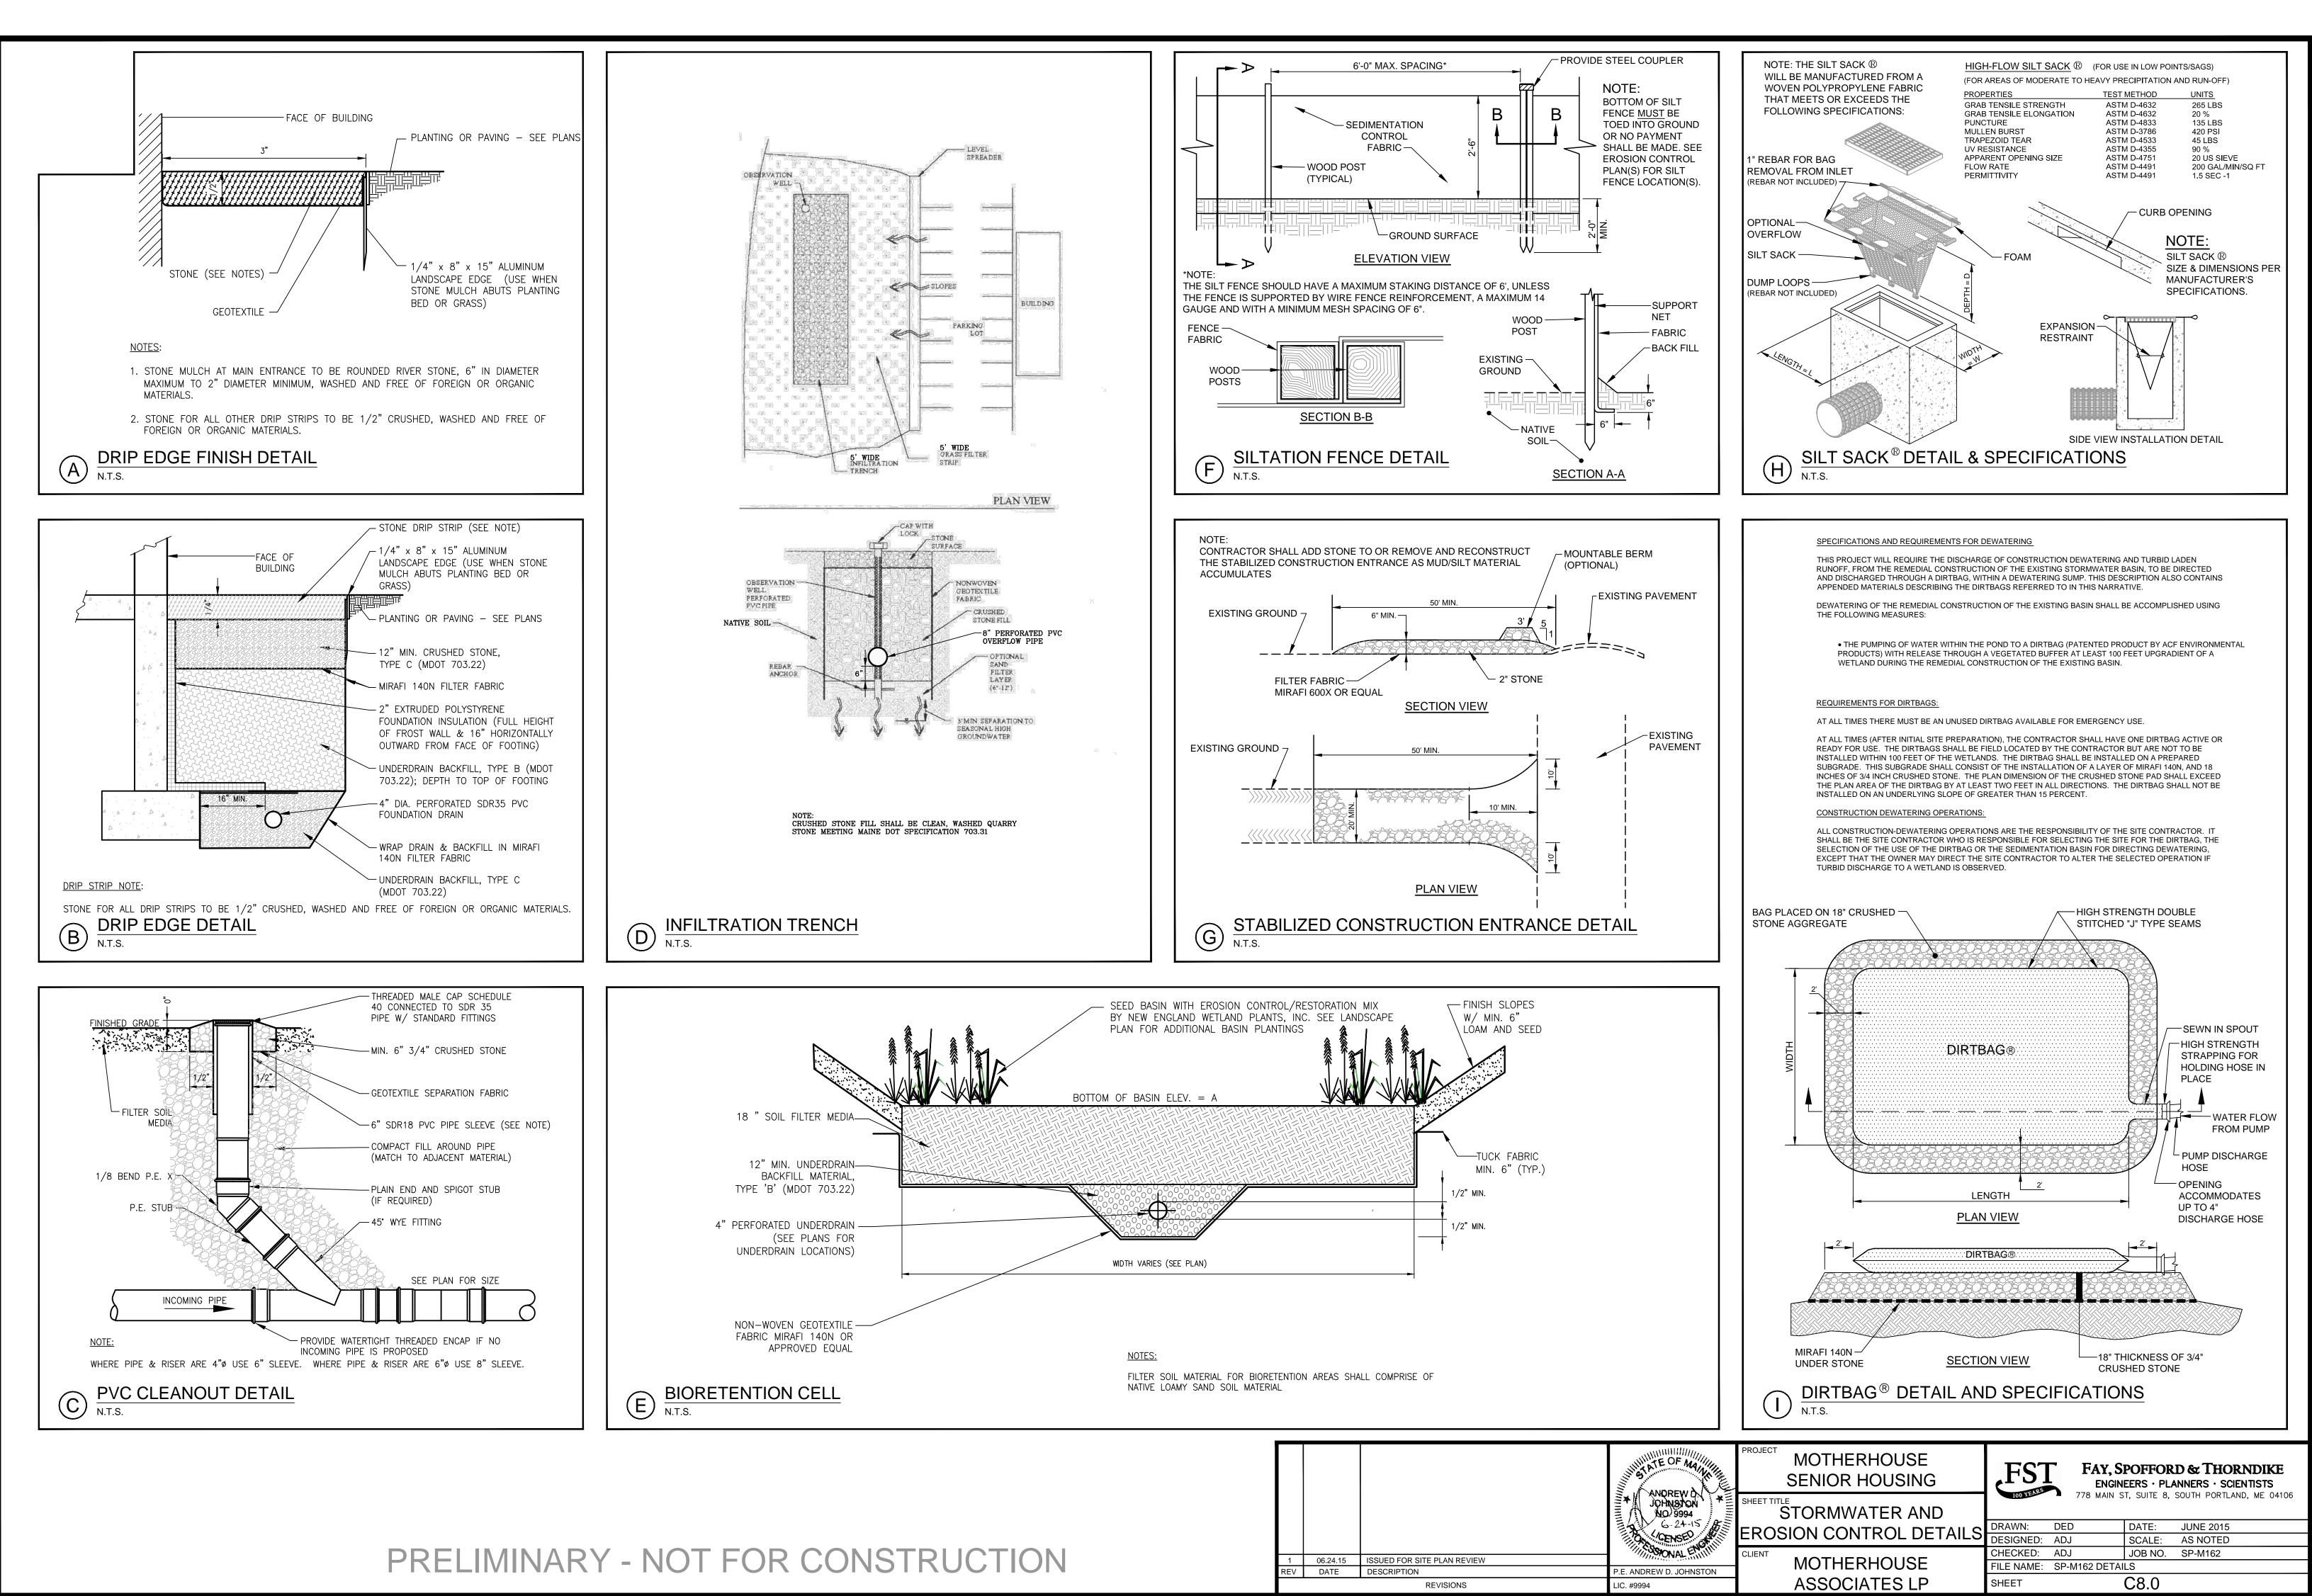

1	06.24.15	ISSUED FOR SITE PLAN REVIEW
REV	DATE	DESCRIPTION
		REVISIONS

TEMPORARY EROSION AND SEDIMENTATION CONTROL MEASURES INCLUDE THE USE OF STABILIZED CONSTRUCTION ENTRANCES, SILTATION FENCE, CATCH BASIN INLET BARRIERS, CATCH BASIN SEDIMENT COLLECTION BAGS, EROSION CONTROL BLANKET, AND TEMPORARY SEEDING AND MULCHING AS REQUIRED. PERMANENT DEVICES INCLUDE PAVEMENT AND PERMANENT VEGETATION.

GENERAL

- A. IT IS ANTICIPATED THAT CONSTRUCTION MAY BEGIN AS SOON AS POSSIBLE FOLLOWING RECEIPT OF NECESSARY PERMITS.
- 1. ALL SOIL EROSION AND SEDIMENT CONTROL MEASURES SHALL BE CONSTRUCTED AND MAINTAINED IN ACCORDANCE WITH THE MAINE EROSION AND SEDIMENT CONTROL HANDBOOK FOR CONSTRUCTION: BEST MANAGEMENT PRACTICES PUBLISHED BY THE CUMBERLAND COUNTY SOIL AND WATER CONSERVATION DISTRICT AND THE DEPARTMENT OF ENVIRONMENTAL PROTECTION, 2003, OR AS CURRENTLY REVISED OR U.S. ENVIRONMENTAL PROTECTION AGENCY PUBLICATION 832/R-92-005 (SEPTEMBER, 1992) STORM WATER MANAGEMENT FOR CONSTRUCTION, CHAPTER 3, WHICHEVER IS MORE STRINGENT.
- 2. ANY ADDITIONAL EROSION AND SEDIMENTATION CONTROL DEEMED NECESSARY BY THE OWNER'S REPRESENTATIVE, DEPARTMENT OF ENVIRONMENTAL PROTECTION (DEP) PERSONNEL AND/OR MUNICIPAL OFFICIALS SHALL BE INSTALLED BY THE CONTRACTOR.
- 3. THE CONTRACTOR IS RESPONSIBLE FOR ALL FINES RESULTING FROM EROSION OR SEDIMENTATION FROM THE SITE TO SURROUNDING PROPERTIES, WATER BODIES, OR WETLANDS AS A RESULT OF THIS PROJECT.
- 4. ANY SOIL OR DEBRIS TRACKED ONTO ABUTTING PAVED AREAS OR STREETS SHALL BE REMOVED IMMEDIATELY
- 5. THE CONTRACTOR SHALL BE RESPONSIBLE FOR THE REPAIR/ REPLACEMENT/ MAINTENANCE OF ALL EROSION CONTROL MEASURES UNTIL ALL DISTURBED AREAS ARE STABILIZED TO THE SATISFACTION OF THE ABOVE PERSONNEL. DESCRIPTIONS OF ACCEPTABLE PERMANENT STABILIZATION FOR VARIOUS COVER TYPES FOLLOWS:
- A. FOR SEEDED AREAS, PERMANENT STABILIZATION MEANS A 90% COVER OF THE DISTURBED AREA WITH MATURE, HEALTHY PLANTS WITH NO EVIDENCE OF WASHING OR RILLING OF THE TOPSOIL.
- B. FOR SODDED AREAS, PERMANENT STABILIZATION MEANS THE COMPLETE BINDING OF THE SOD ROOTS INTO THE UNDERLYING SOIL WITH NO SLUMPING OF THE SOD OR DIE-OFF.
- C. FOR MULCHED AREAS, PERMANENT MULCHING MEANS TOTAL COVERAGE OF THE EXPOSED AREA WITH AN APPROVED MULCH MATERIAL. EROSION CONTROL MIX MAY BE USED AS MULCH FOR PERMANENT STABILIZATION ACCORDING TO THE APPROVED APPLICATION RATES AND LIMITATIONS.
- D. PAVED AREAS: FOR PAVED AREAS, PERMANENT STABILIZATION MEANS THE PLACEMENT OF THE COMPACTED GRAVEL SUBBASE IS COMPLETED.
- B. EROSION AND SEDIMENTATION CONTROL MEASURES
- 1. PRIOR TO THE BEGINNING OF CONSTRUCTION, THE STABILIZED CONSTRUCTION ENTRANCE AND TEMPORARY SILT FENCE SHALL BE INSTALLED AS SHOWN ON THE PLANS OR AS DIRECTED BY THE OWNER'S REPRESENTATIVE. IT IS THE INTENT THAT SILT FENCE BE INSTALLED DOWN GRADIENT OF ALL DISTURBED AREAS OF THE SITE. SILT FENCE SHALL BE INSPECTED IMMEDIATELY AFTER EACH RAINFALL AND AT LEAST DAILY DURING PROLONGED RAINFALL. ANY REQUIRED REPAIRS WILL BE MADE IMMEDIATELY. SEDIMENT DEPOSITS SHALL BE PERIODICALLY REMOVED FROM THE UPSTREAM SIDE OF THE SILT BARRIERS. THIS SEDIMENT WILL BE SPREAD AND STABILIZED IN AREAS OF THE SITE NOT SUBJECT TO EROSION. SILT FENCE SHALL BE REPLACED AS NECESSARY TO PROVIDE PROPER FILTERING ACTION. IF THERE ARE SIGNS OF UNDERCUTTING AT THE CENTER OR THE EDGES, OR IMPOUNDING OF LARGE VOLUMES OF WATER BEHIND THEM, THEY WILL BE REPLACED WITH A TEMPORARY CRUSHED STONE CHECK DAM.
- 2. ALL CATCH BASINS, NEW OR EXISTING, THAT MAY RECEIVE RUNOFF FROM DISTURBED AREAS MUST BE PROTECTED DURING CONSTRUCTION.
- 3. REMOVAL OF SOD, TREES, BUSHES AND OTHER VEGETATION AND SOIL DISTURBANCE WILL BE KEPT TO A MINIMUM WHILE ALLOWING PROPER SITE DEVELOPMENT.
- 4. GRUBBINGS AND ANY UNUSABLE TOPSOIL SHALL BE STRIPPED AND REMOVED FROM THE PROJECT SITE AND DISPOSED OF IN AN APPROVED MANNER.
- 5. ANY SUITABLE TOPSOIL WILL BE STRIPPED AND STOCKPILED FOR REUSE IN FINAL GRADING. TOPSOIL WILL BE STOCKPILED IN A MANNER SUCH THAT NATURAL DRAINAGE IS NOT OBSTRUCTED AND NO OFF-SITE SEDIMENT DAMAGE WILL RESULT.
- 7. TEMPORARY STABILIZATION SHALL BE CONDUCTED WITHIN 7 DAYS OF INITIAL DISTURBANCE OF SOILS, PRIOR TO ANY RAIN EVENT, AND PRIOR TO ANY WORK SHUT DOWN LASTING MORE THAN ONE DAY. TEMPORARY STABILIZATION INCLUDES SEED, MULCH, OR OTHER NON-ERODABLE COVER.
- 8. PERMANENT SEEDING SPECIFICATION SHALL BE AS SHOWN ON THE LANDSCAPE PLAN. LATE SEASON SEEDING SHALL BE DONE BETWEEN AUGUST 15 AND SEPTEMBER 15. AREAS NOT SEEDED OR WHICH DO NOT OBTAIN A SATISFACTORY GROWTH BY OCTOBER 1SHALL BE SEEDED WITH AROOSTOOK RYE OR MULCHED AT RATES PREVIOUSLY SPECIFIED. SEE WINTER CONDITIONS NOTES FOR SEEDING STABILIZATION AFTER NOVEMBER 1.
- A. APPLY TOPSOIL TO A MINIMUM DEPTH OF 4 INCHES. MIX TOPSOIL WITH THE SUBSOIL TO A MINIMUM DEPTH OF 6 INCHES.
- B. APPLY LIMESTONE AND FERTILIZER ACCORDING TO SOIL TESTS. IN LIEU OF SOIL TESTS, APPLY GROUND LIMESTONE AT A RATE OF 3 TONS PER ACRE (138 LB. PER 1,000 SQUARE FEET) AND GRANULAR, COMMERCIAL-GRADE, 10-10-10 (N-P2O5-K2O) FERTILIZER AT A RATE OF 800 LBS PER ACRE (18.4 LBS PER 1,000 SQUARE FEET).
- C. UNIFORMLY APPLY SEED MIXTURE AT THE RECOMMENDED SEEDING RATES AND DATES, APPLY HAY OR STRAW MULCH AT A RATE OF 2 TONS PER ACRES, AND ANCHOR AS NECESSARY.
- 13. EROSION CONTROL BLANKET SHALL BE INSTALLED ON ALL PERMANENT SLOPES STEEPER THAN 15%. EROSION CONTROL BLANKET SHALL BE INSTALLED IN ACCORDANCE WITH MANUFACTURER'S **RECOMMENDATIONS.**
- 14. TEMPORARY CONTROL MEASURES, SUCH AS SILT FENCE, SHALL BE REMOVED WITHIN 30 DAYS AFTER PERMANENT STABILIZATION IS ATTAINED.
- C. WINTER CONDITIONS NO WINTER SITE CONSTRUCTION IS PROPOSED ON THIS PROJECT.
- D. HOUSEKEEPING
- 1. SPILL PREVENTION. CONTROLS MUST BE USED TO PREVENT POLLUTANTS FROM CONSTRUCTION AND WASTE MATERIALS STORED ON-SITE, INCLUDING STORAGE PRACTICES TO MINIMIZE EXPOSURE OF THE MATERIALS TO STORM WATER, AND APPROPRIATE SPILL PREVENTION, CONTAINMENT, AND **RESPONSE PLANNING AND IMPLEMENTATION.**
- 2. GROUNDWATER PROTECTION. DURING CONSTRUCTION, LIQUID PETROLEUM PRODUCTS AND OTHER HAZARDOUS MATERIALS WITH THE POTENTIAL TO CONTAMINATE GROUNDWATER MAY NOT BE STORED OR HANDLED IN AREAS OF THE SITE DRAINING TO AN INFILTRATION AREA. AN "INFILTRATION AREA" IS ANY AREA OF THE SITE THAT BY DESIGN OR AS A RESULT OF SOILS, TOPOGRAPHY AND OTHER RELEVANT FACTORS, ACCUMULATES RUNOFF THAT INFILTRATES INTO THE SOIL. DIKES, BERMS, SUMPS, AND OTHER FORMS OF SECONDARY CONTAINMENT THAT PREVENT DISCHARGE TO GROUNDWATER MAY BE USED TO ISOLATE PORTIONS OF THE SITE FOR THE PURPOSES OF STORAGE AND HANDLING OF THESE MATERIALS.
- 3. FUGITIVE SEDIMENT AND DUST. ACTIONS MUST BE TAKEN TO ENSURE THAT ACTIVITIES DO NOT RESULT IN NOTICEABLE EROSION OF SOILS OR FUGITIVE DUST EMISSIONS DURING OR AFTER CONSTRUCTION. OIL MAY NOT BE USED FOR DUST CONTROL.

4. DEBRIS AND OTHER MATERIAL. LITTER, CONSTRUCTION DEBRIS, AND CONSTRUCTION CHEMICALS EXPOSED TO STORM WATER, MUST BE PREVENTED FROM BECOMING A POLLUTANT SOURCE.

- 5. COMPLY WITH THE REQUIREMENTS OF SECTION 01570, CONSTRUCTION WASTE MANAGEMENT, FOR REMOVAL AND DISPOSAL OF CONSTRUCTION DEBRIS AND WASTE.
- 6. TRENCH OR FOUNDATION DE-WATERING. THE COLLECTED WATER REMOVED FROM THE PONDED AREA, EITHER THROUGH GRAVITY OR PUMPING, MUST BE SPREAD THROUGH NATURAL WOODED BUFFERS OR REMOVED AREAS THAT ARE SPECIFICALLY DESIGNATED TO COLLECT THE MAXIMUM AMOUNT OF SEDIMENT POSSIBLE, LIKE A COFFER DAM SEDIMENTATION BASIN. AVOID ALLOWING THE WATER TO FLOW OVER DISTURBED AREAS OF THE SITE.

E. INSPECTION AND MAINTENANCE


- 1. INSPECT DISTURBED AND IMPERVIOUS AREAS, EROSION AND STORM WATER CONTROL MEASURES, AREAS USED FOR STORAGE THAT ARE EXPOSED TO PRECIPITATION, AND LOCATIONS WHERE VEHICLES ENTER OR EXIT THE SITE AT LEAST ONCE A WEEK AND BEFORE AND AFTER A STORM EVENT, PRIOR TO COMPLETION OF PERMANENT STABILIZATION. A PERSON WITH KNOWLEDGE OF EROSION AND STORM WATER CONTROLS, INCLUDING THE STANDARDS IN THE MAINE CONSTRUCTION GENERAL PERMIT AND ANY DEP OR MUNICIPAL COMPANION DOCUMENTS, MUST CONDUCT THE INSPECTION. THIS PERSON MUST BE IDENTIFIED IN THE INSPECTION LOG. IF BEST MANAGEMENT PRACTICES (BMPS) NEED TO BE MODIFIED OF IF ADDITIONAL BMPS ARE NECESSARY, IMPLEMENTATION MUST BE COMPLETED WITHIN 7 CALENDAR DAYS AND PRIOR TO ANY STORM EVENT (RAINFALL). ALL MEASURES MUST BE MAINTAINED IN EFFECTIVE OPERATING CONDITION UNTIL AREAS ARE PERMANENTLY STABILIZED.
- 2. AN INSPECTION AND MAINTENANCE LOG MUST BE KEPT SUMMARIZING THE SCOPE OF THE INSPECTION, NAME AND QUALIFICATIONS OF THE PERSON PERFORMING THE INSPECTION, DATE, AND MAJOR OBSERVATIONS RELATING TO OPERATION OF EROSION AND SEDIMENTATION CONTROLS AND POLLUTION PREVENTION MEASURES. MAJOR OBSERVATIONS MUST INCLUDE: BMPS THAT NEED TO BE MAINTAINED, LOCATION(S) OF BMPS THAT FAILED TO OPERATE AS DESIGNED OR PROVED INADEQUATE FOR A PARTICULAR LOCATION, AND LOCATION(S) WHERE ADDITIONAL BMPS ARE NEEDED THAT DID NOT EXIST AT THE TIME OF THE INSPECTION. FOLLOW-UP TO CORRECT DEFICIENCIES OR ENHANCE CONTROLS MUST ALSO BE INDICATED IN THE LOG AND DATED, INCLUDING WHAT ACTION WAS TAKEN AND WHEN.


F. CONSTRUCTION SCHEDULE & SEQUENCE


- 1. INSTALL TEMPORARY EROSION CONTROL MEASURES IN THE VICINITY OF THE CONSTRUCTION AREA, INCLUDING A STABILIZED CONSTRUCTION ENTRANCE AT LOCATIONS DEEMED NECESSARY BY THE OWNER'S REPRESENTATIVE, SEDIMENT BARRIERS, AND SILT FENCE.
- 2. REMOVE EXISTING PAVEMENT AND STRUCTURES AS SHOWN, STOCKPILE REUSABLE MATERIAL, AND DISPOSE OF UNUSABLE AND/OR SURPLUS MATERIAL. INSTALL UNDERGROUND UTILITIES AND INSTALL NEW BASE GRAVEL IN PARKING AREAS AND DRIVES.
- 3. EXCAVATE AROUND FOUNDATIONS FOR BUILDING IMPROVEMENTS AND DRIP EDGE INSTALLATION.
- 4. CONSTRUCT OTHER SITE IMPROVEMENTS, INCLUDING PAVEMENT, SIDEWALKS.
- 5. INSTALL LANDSCAPING AND HARDSCAPE AROUND BUILDINGS.
- 6. FOLLOWING PERMANENT STABILIZATION OF THE SITE, REMOVE TEMPORARY EROSION CONTROL MEASURES.


1	06.24.15	ISSUED FOR SITE PLAN REVIEW
REV	DATE	DESCRIPTION
		REVISIONS

ANDREW D	MOTHERHOUSE SENIOR HOUSING	FAY, SPOFFORD & THORNDIKE ENGINEERS · PLANNERS · SCIENTISTS 778 MAIN ST, SUITE 8, SOUTH PORTLAND, ME 04106			NNERS · SCIENTISTS
ANDREW DI		- 776 MAIN ST, SUITE 8, SOUTH PORTLAND, ME 04106			
E-24-15 AE	EROSION CONTROL NOTES	DRAWN:	DED	DATE:	JUNE 2015
O CENSE		DESIGNED:	ADJ	SCALE:	AS NOTED
 MINSONAL EMILIA		CHECKED:	ADJ	JOB NO.	SP-M162
 P.E. ANDREW D. JOHNSTON	MOTHERHOUSE	FILE NAME:	SP-M162 DETAI	LS	
LIC. #9994	ASSOCIATES LP	SHEET		C8.1	

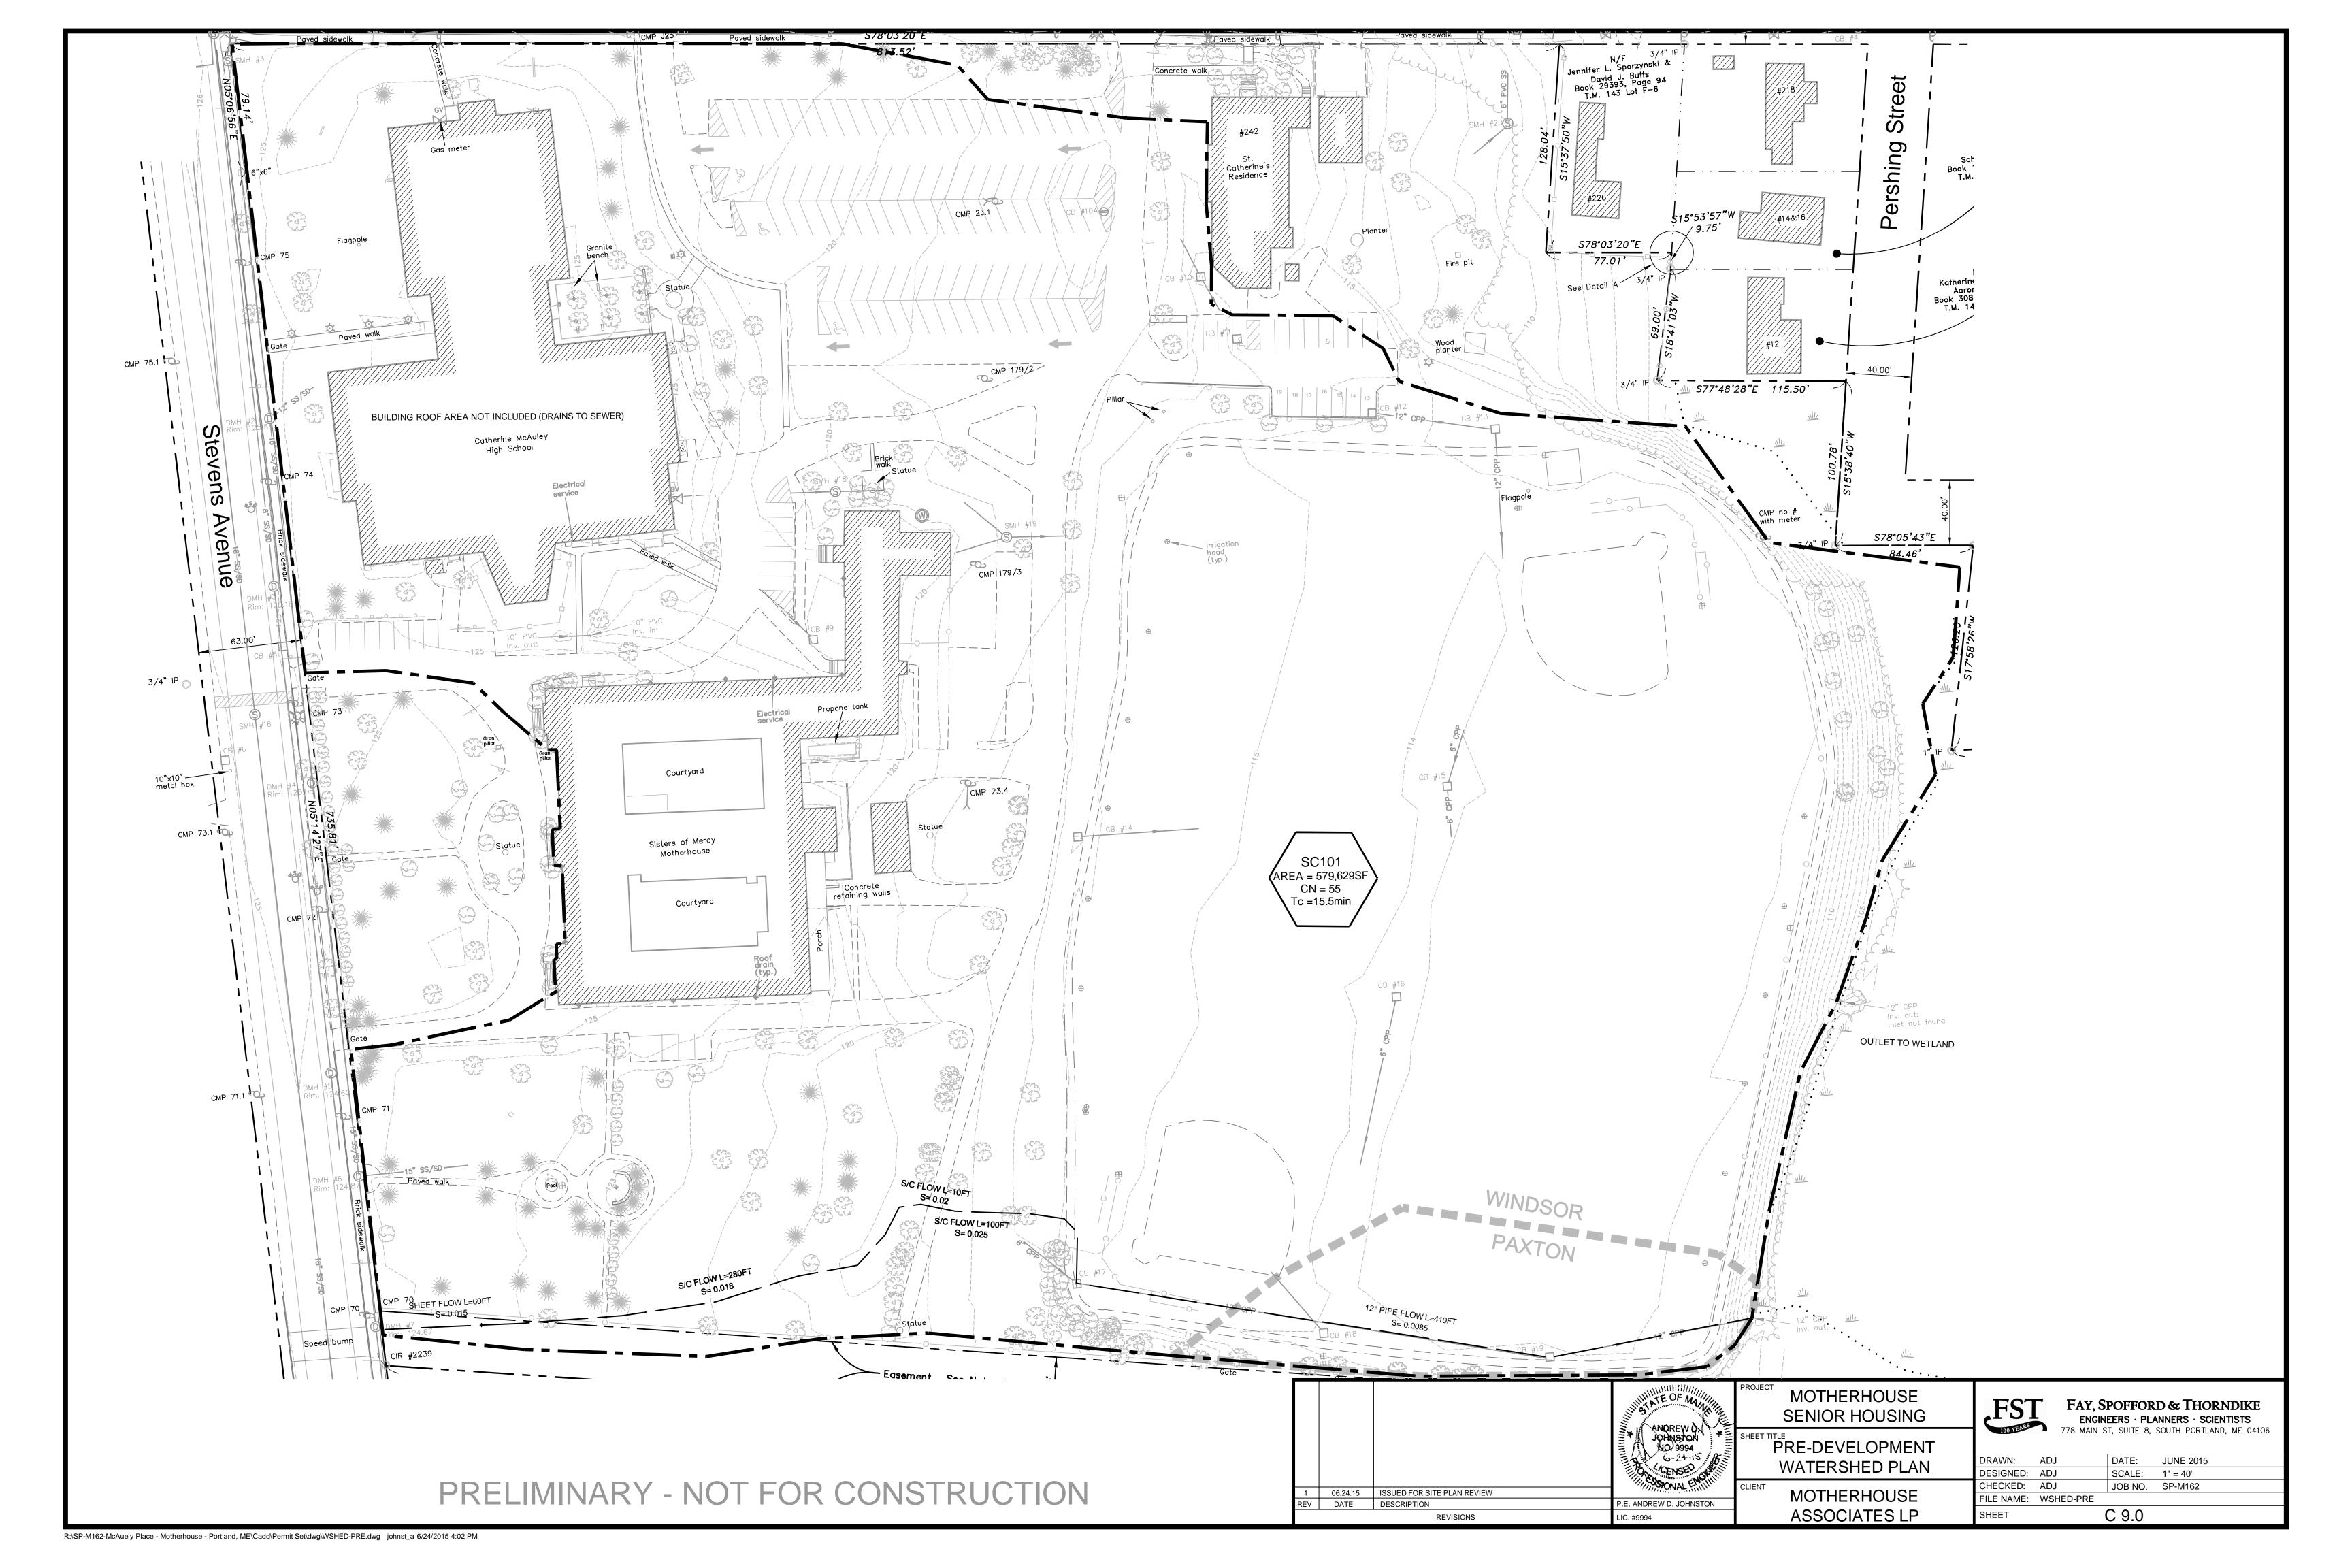

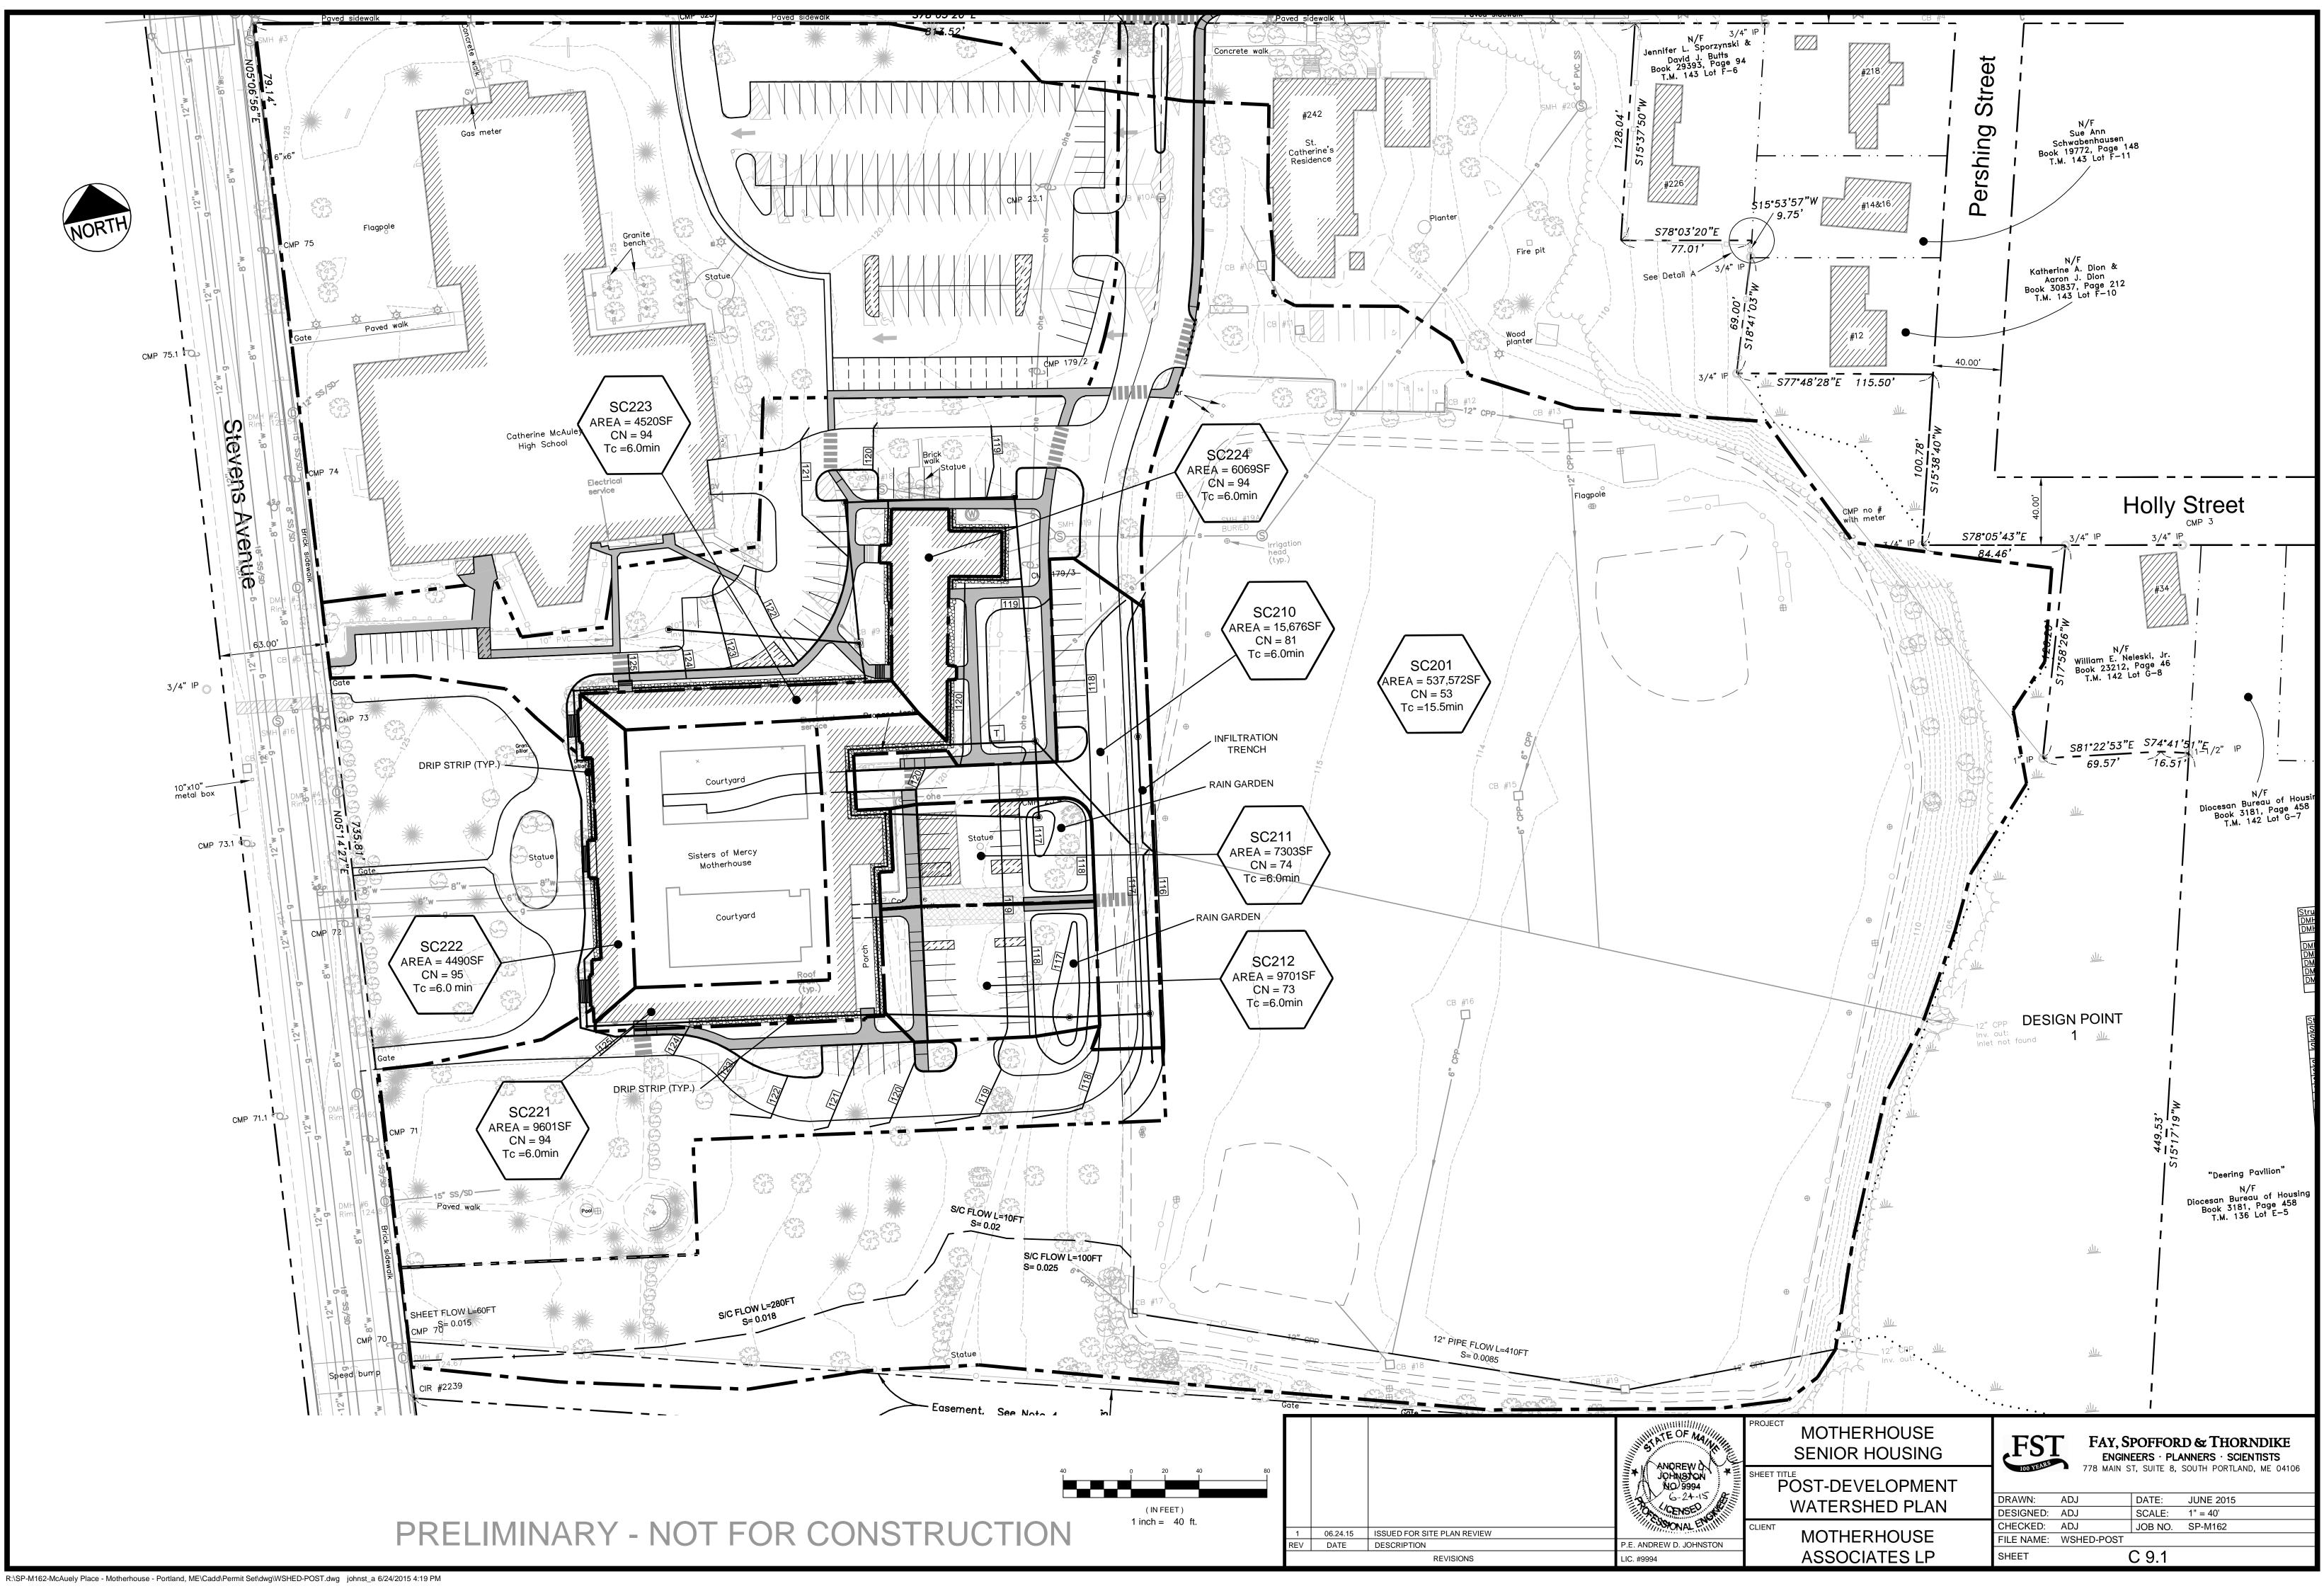


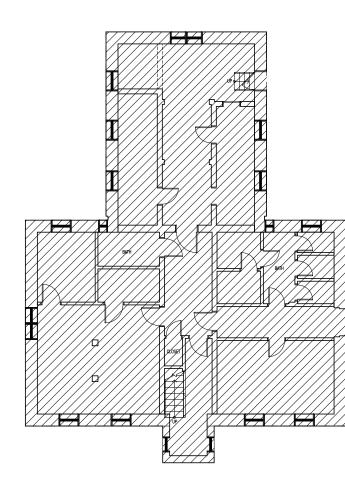


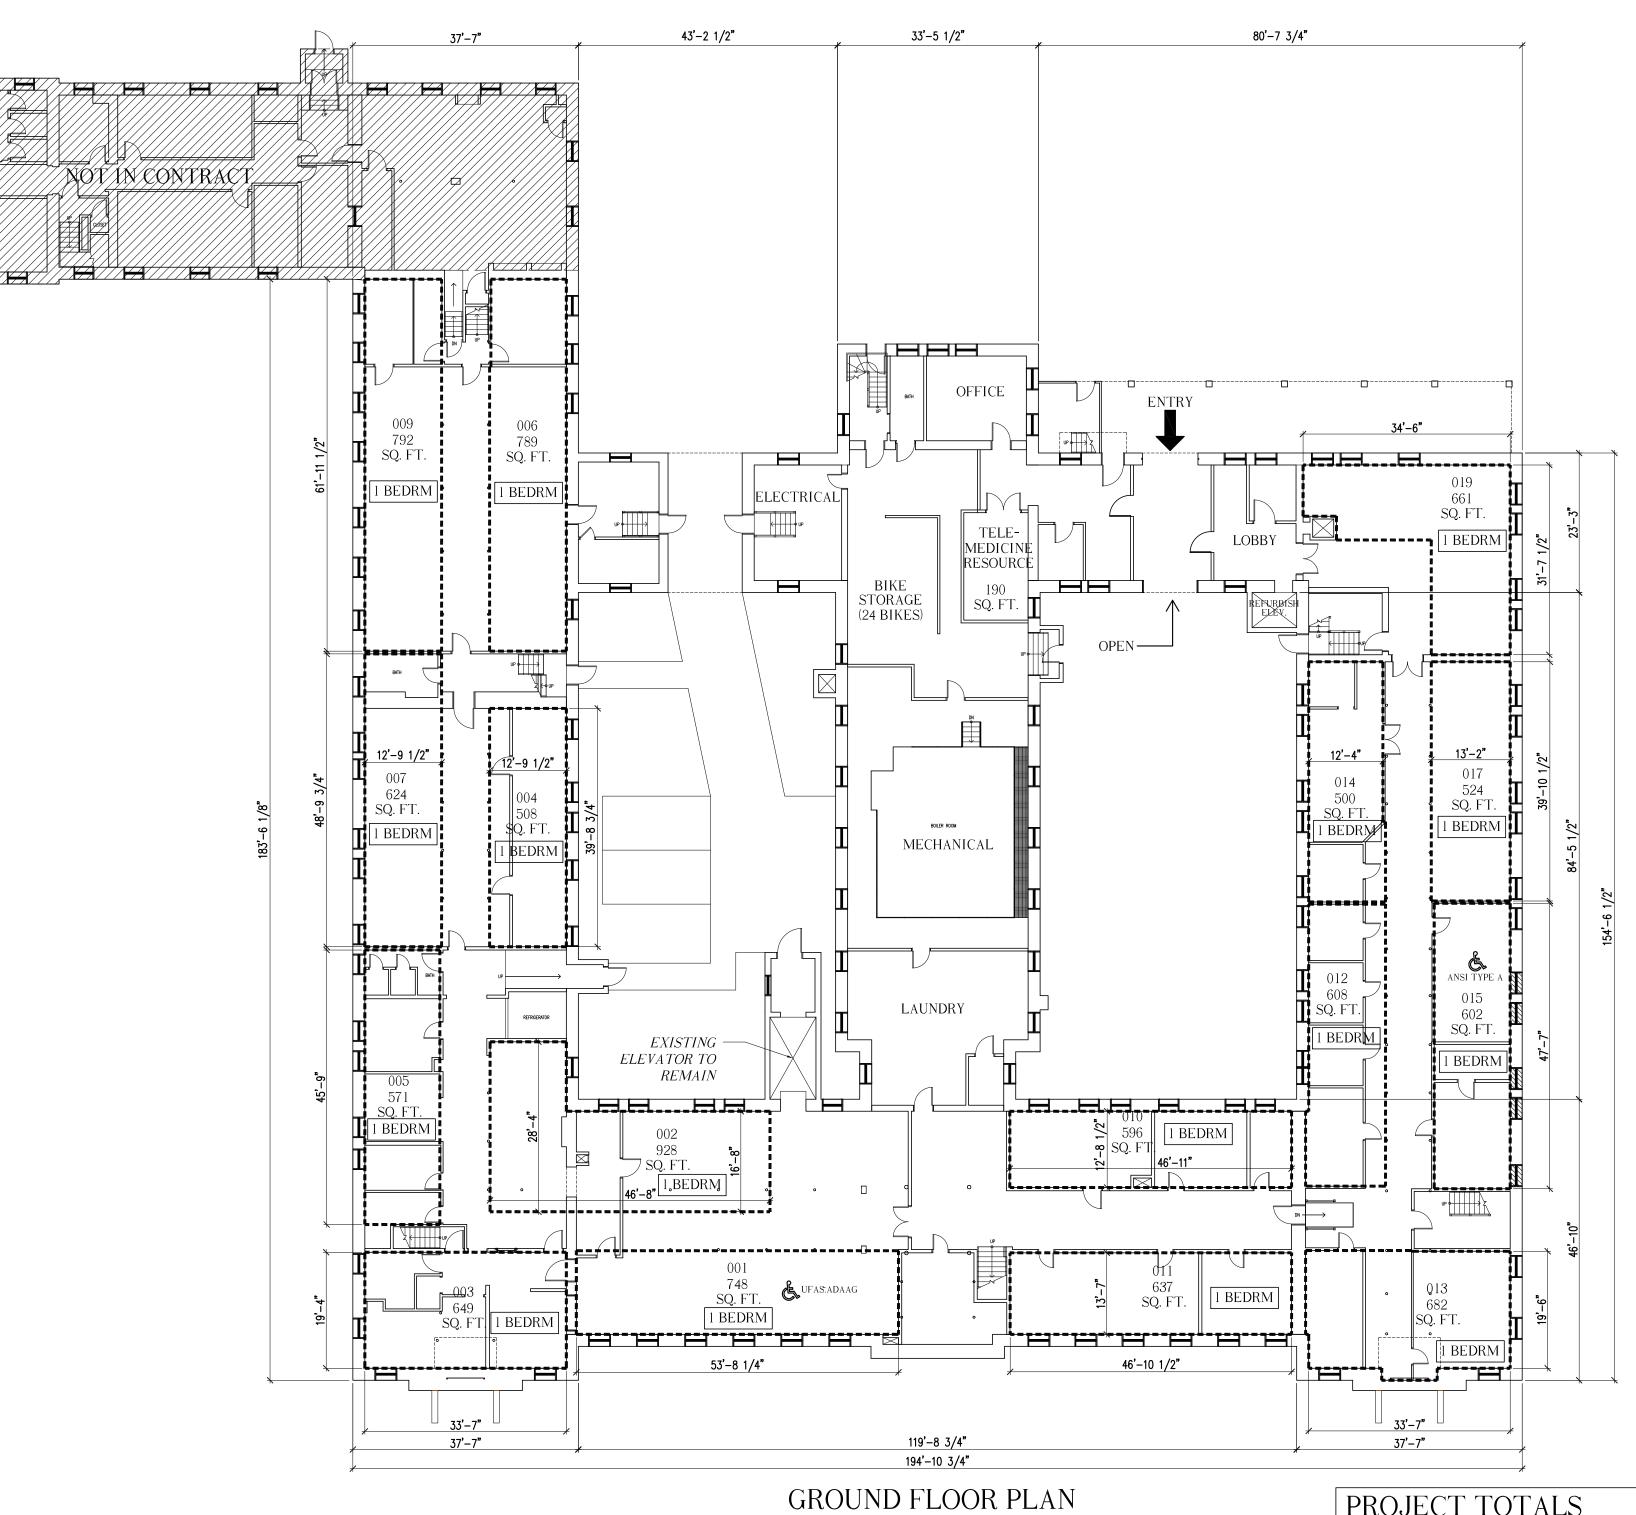


16 UNITS 16 1 BEDROOM UNITS GROSS AREA = 24, 065 SQ. FT APARTMENTS NET AREA = 10,419 SQ. FT

PROJECT TOTALS 88 UNITS 20 STUDIO UNITS, 68 1 BEDROOM UNITS

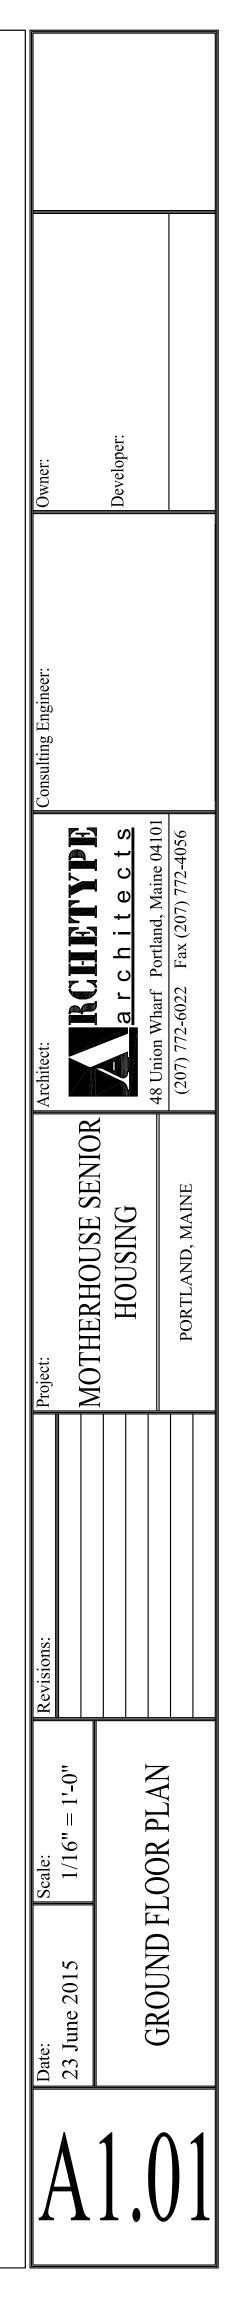


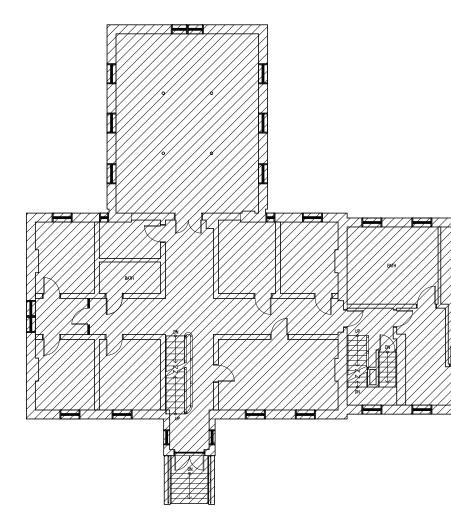

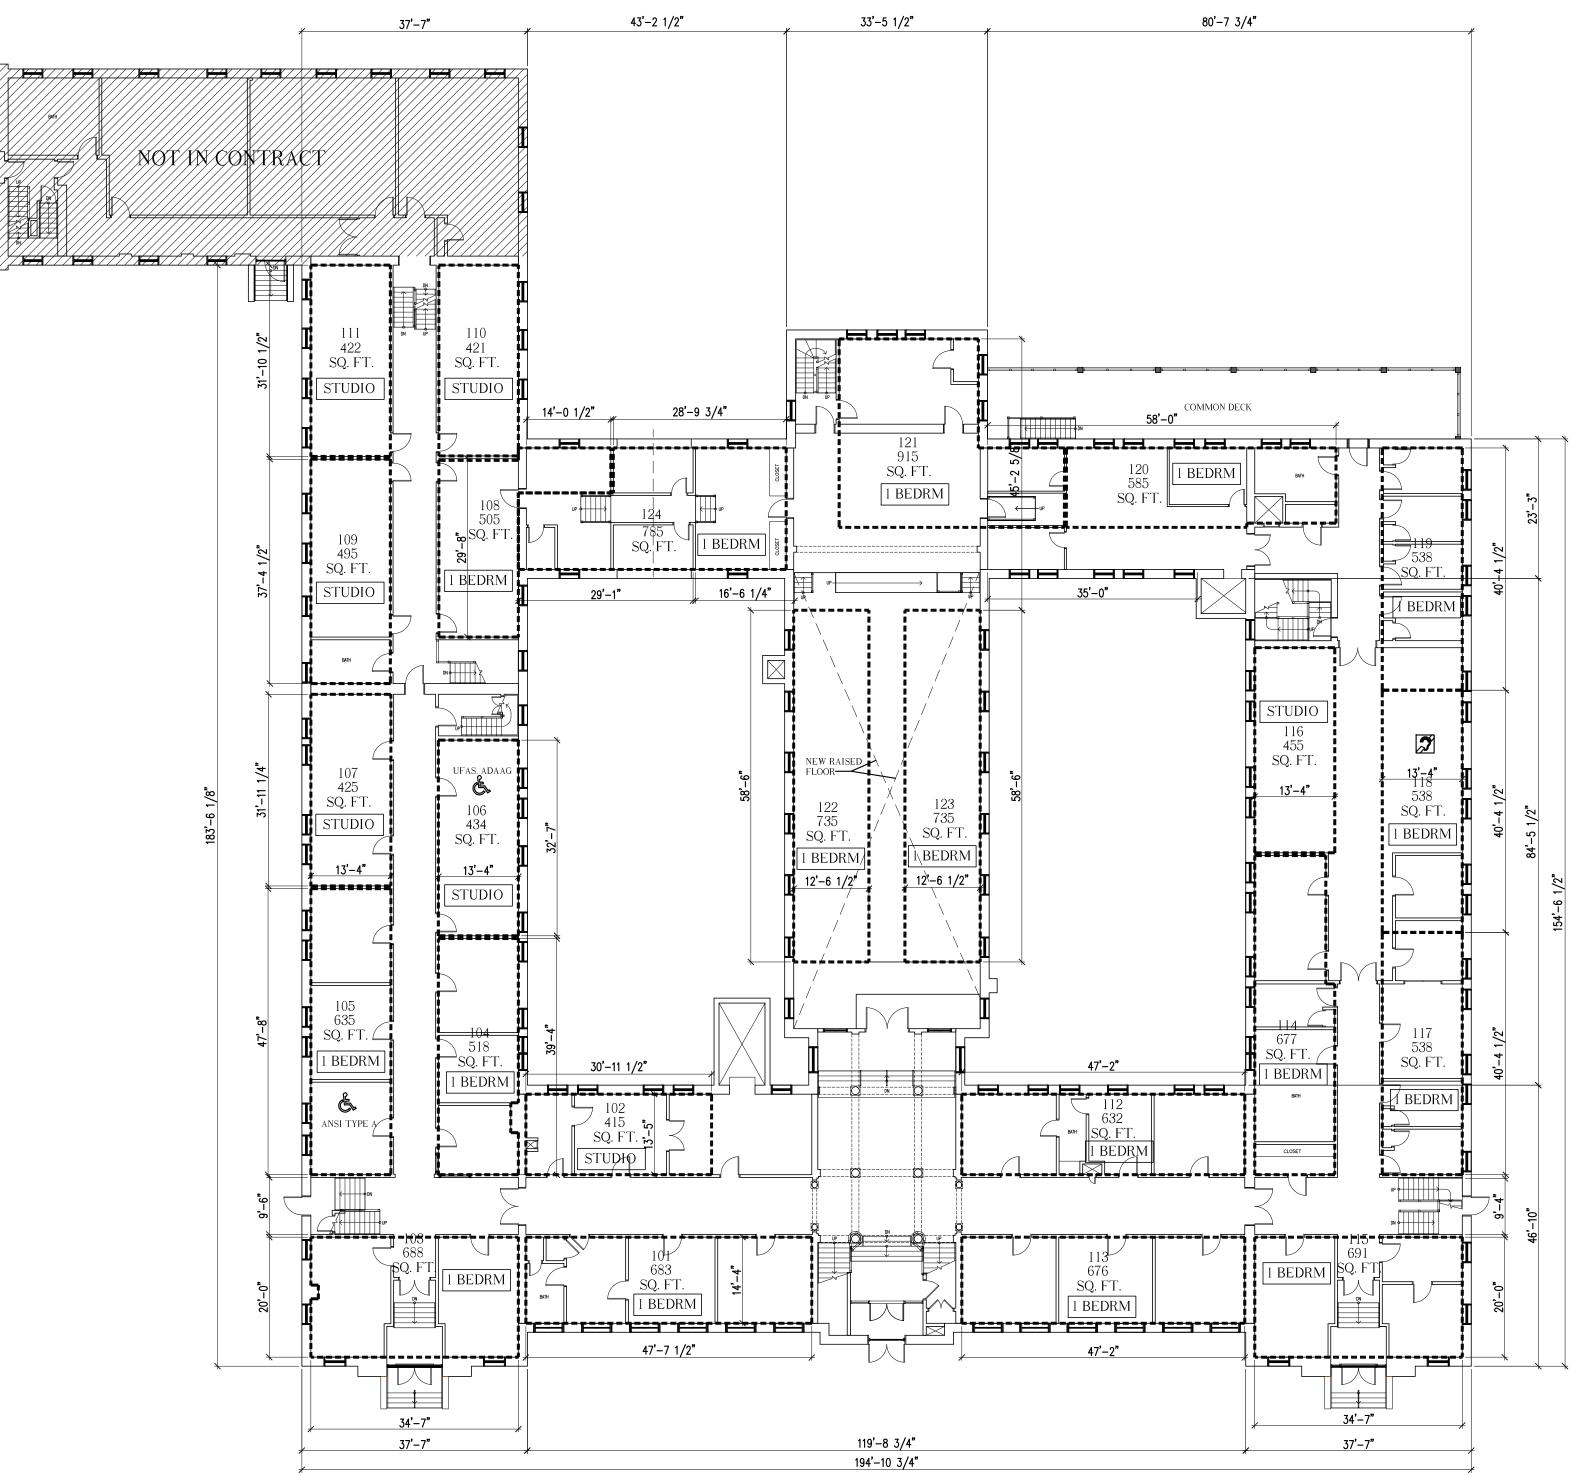


FIRST FLOOR PLAN 24 UNITS 7 STUDIO UNITS, 17 1 BEDROOM UNITS GROSS AREA = 24, 212 SQ. FT APARTMENTS NET AREA = 14,659 SQ. FT

		er:				
Owner:		Developer:	-			
Consulting Engineer:						
Architect:				48 Union Wharf Portland, Maine 04101	(207) 772-6022 Fax (207) 772-4056	
Project:	MOTHERHOUSE SENIOR		DNICODI		PORTLAND, MAINE	`
Revisions:						
ate: Scale:	23 June 2015 $1/16" = 1'-0"$			FIRST FLOOR PLAN		
		1	•	$\left(\begin{array}{c} \\ \end{array} \right)$		

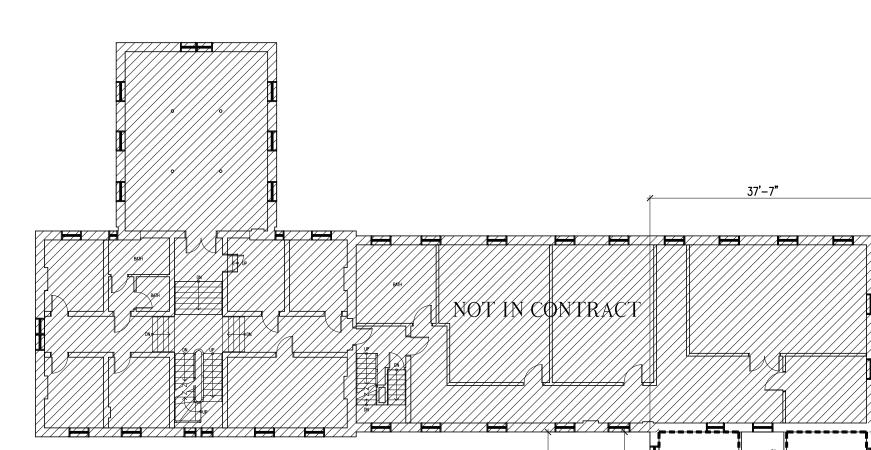

SECOND FLOOR PLAN 21 UNITS 7 STUDIO UNITS, 14 1 BEDROOM UNITS GROSS AREA (INCL. CHAPEL) = 24, 153 SQ. FT GROSS AREA (NOT INCL. CHAPEL) = 18, 333 SQ. FT APARTMENTS NET AREA = 10,604 SQ. FT

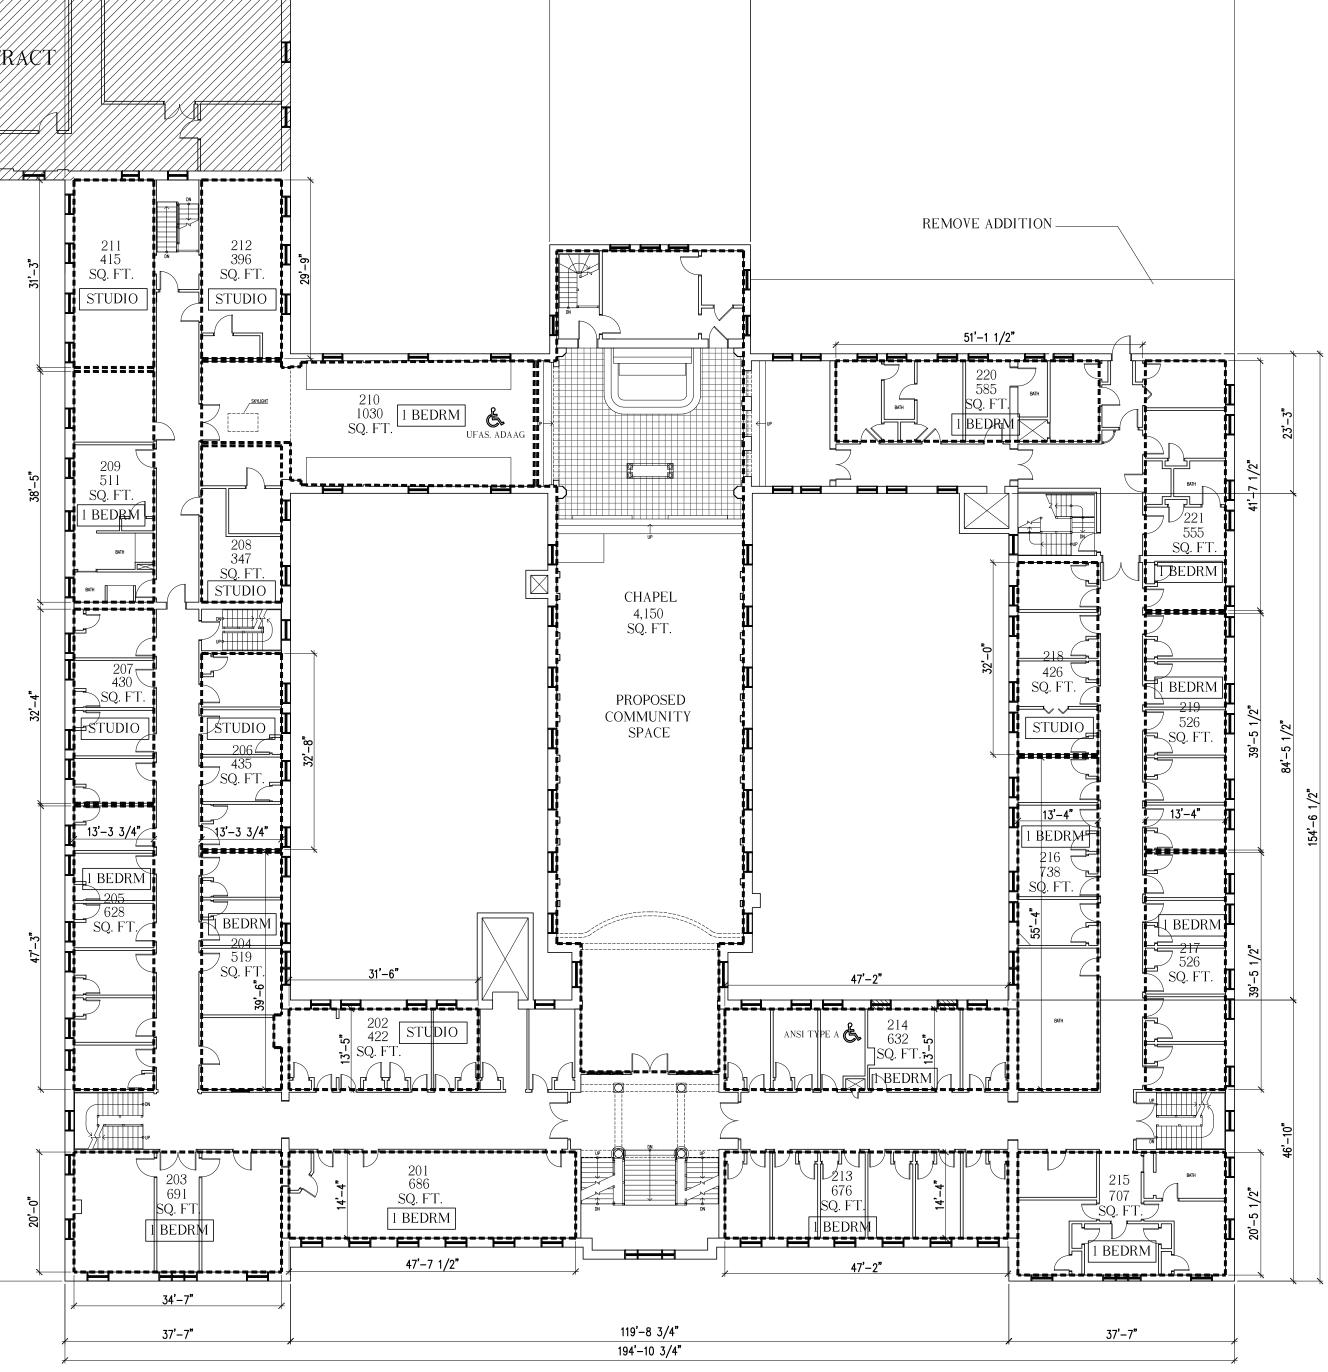


33'-5 1/2"


43'-2 1/2"

37'–7"

80'-7 3/4"


Date:	Scale:	Revisions:	Project:	Architect:	Consulting Engineer:	Owner:	
23 June 2015	1/16" = 1'-0"		MOTHERHOUSE SENIOR				
1						Develoner:	
			DNICUUH				
				48 Union Wharf Portland, Maine 04101			
			PORTLAND, MAINE	(207) 772-6022 Fax (207) 772-4056			
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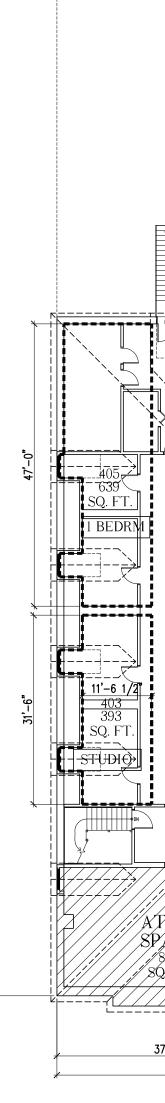


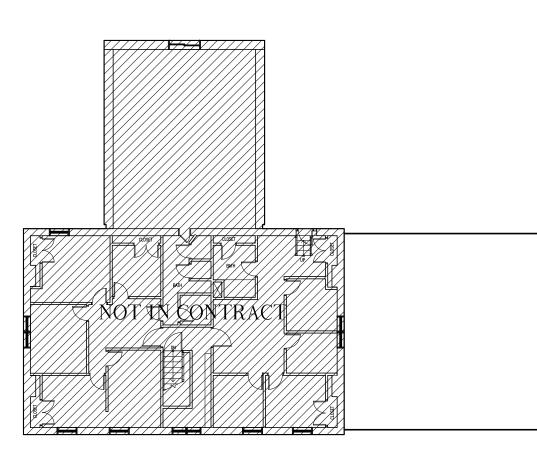
THIRD FLOOR PLAN

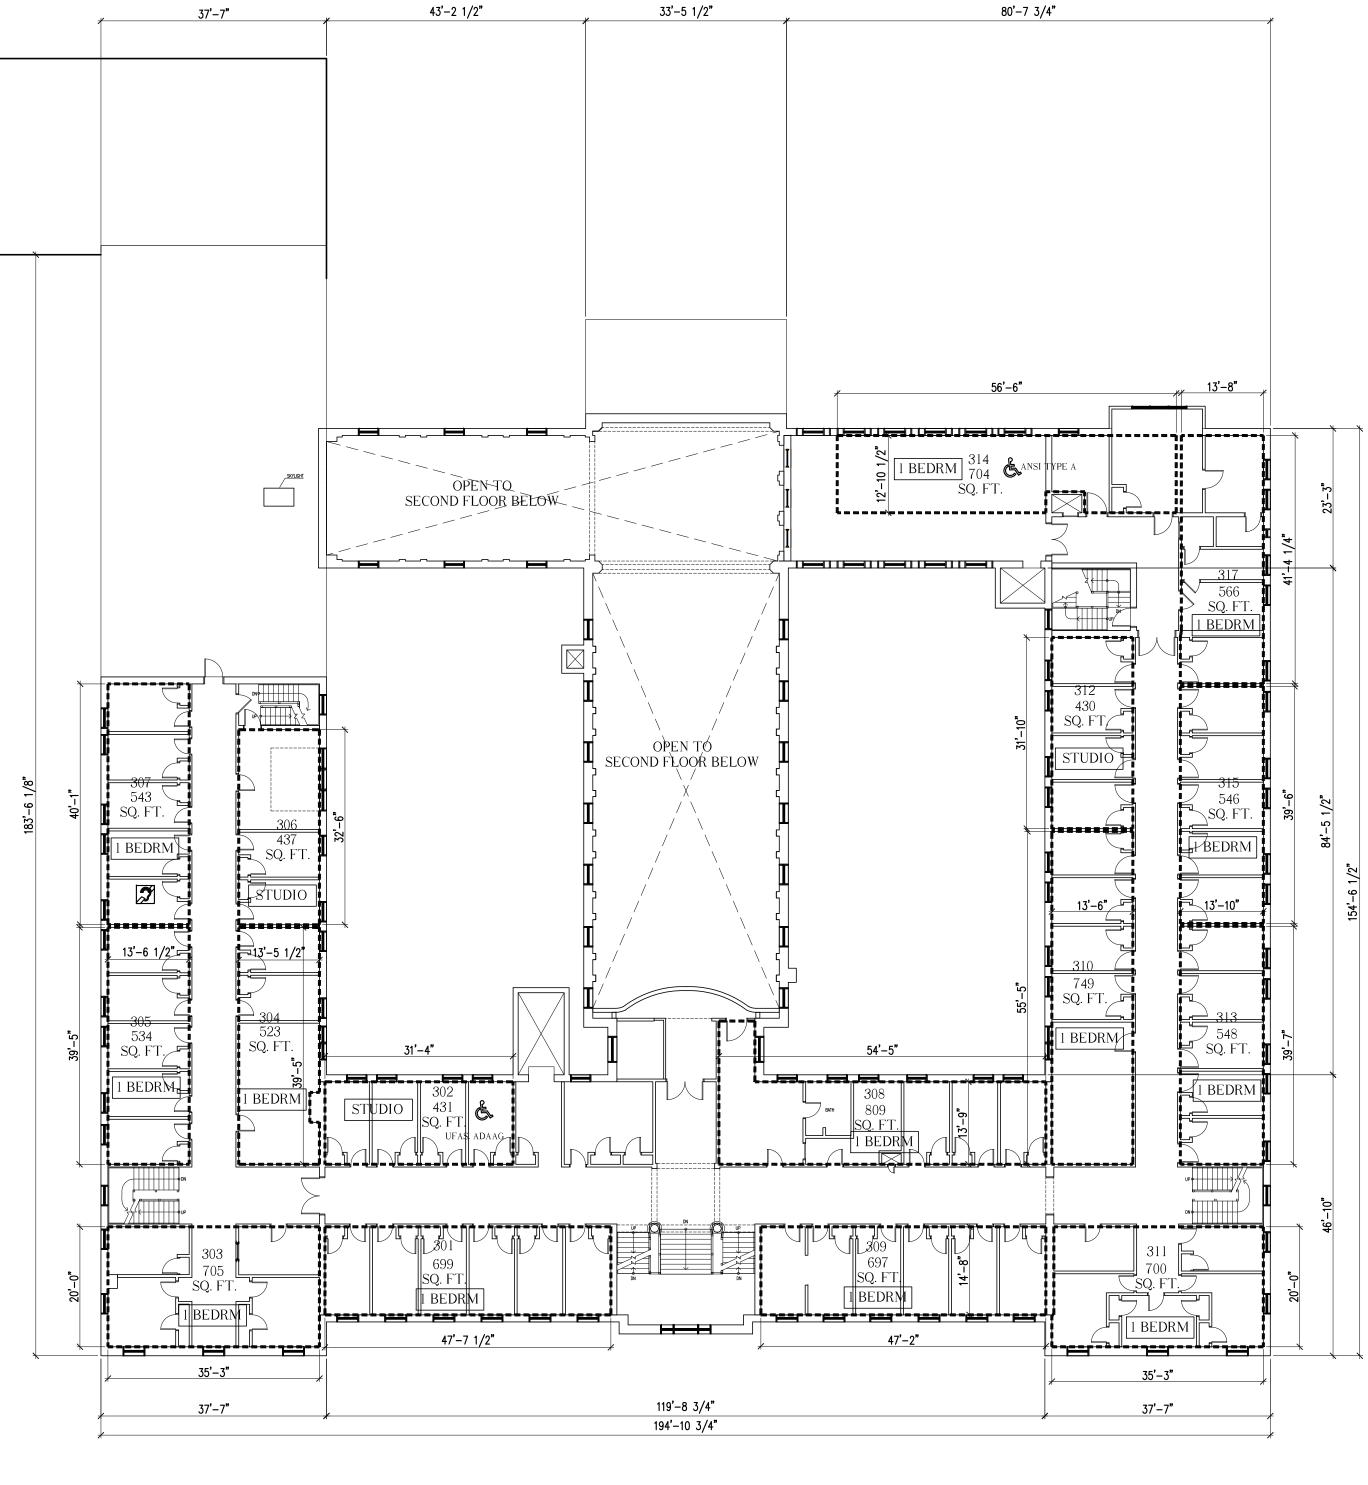16 UNITS 3 STUDIO UNITS, 13 1 BEDROOM UNITS GROSS AREA (INCL. CHAPEL) = 21, 018 SQ. FT GROSS AREA (NOT INCL. CHAPEL) = 16, 538 SQ. FT APARTMENTS NET AREA = 9,621 SQ. FT



1 BEDRM STUDIO

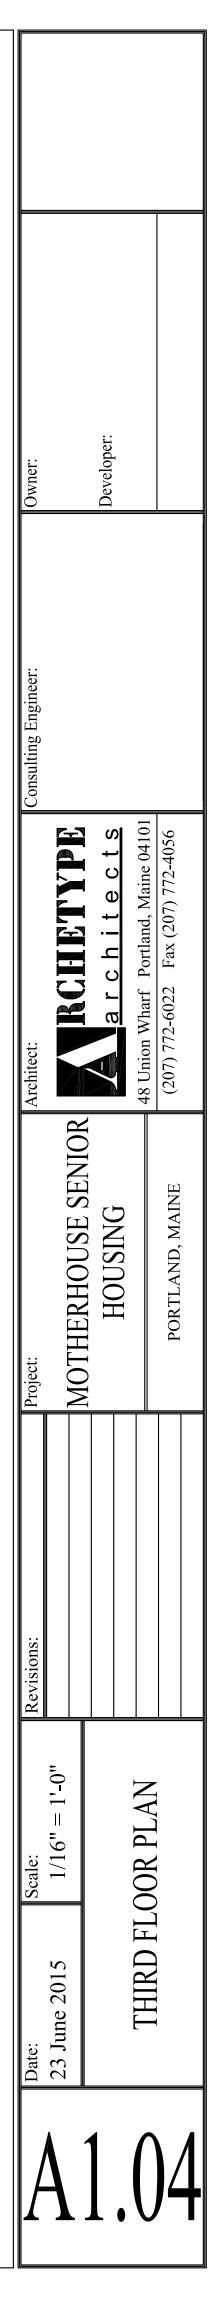


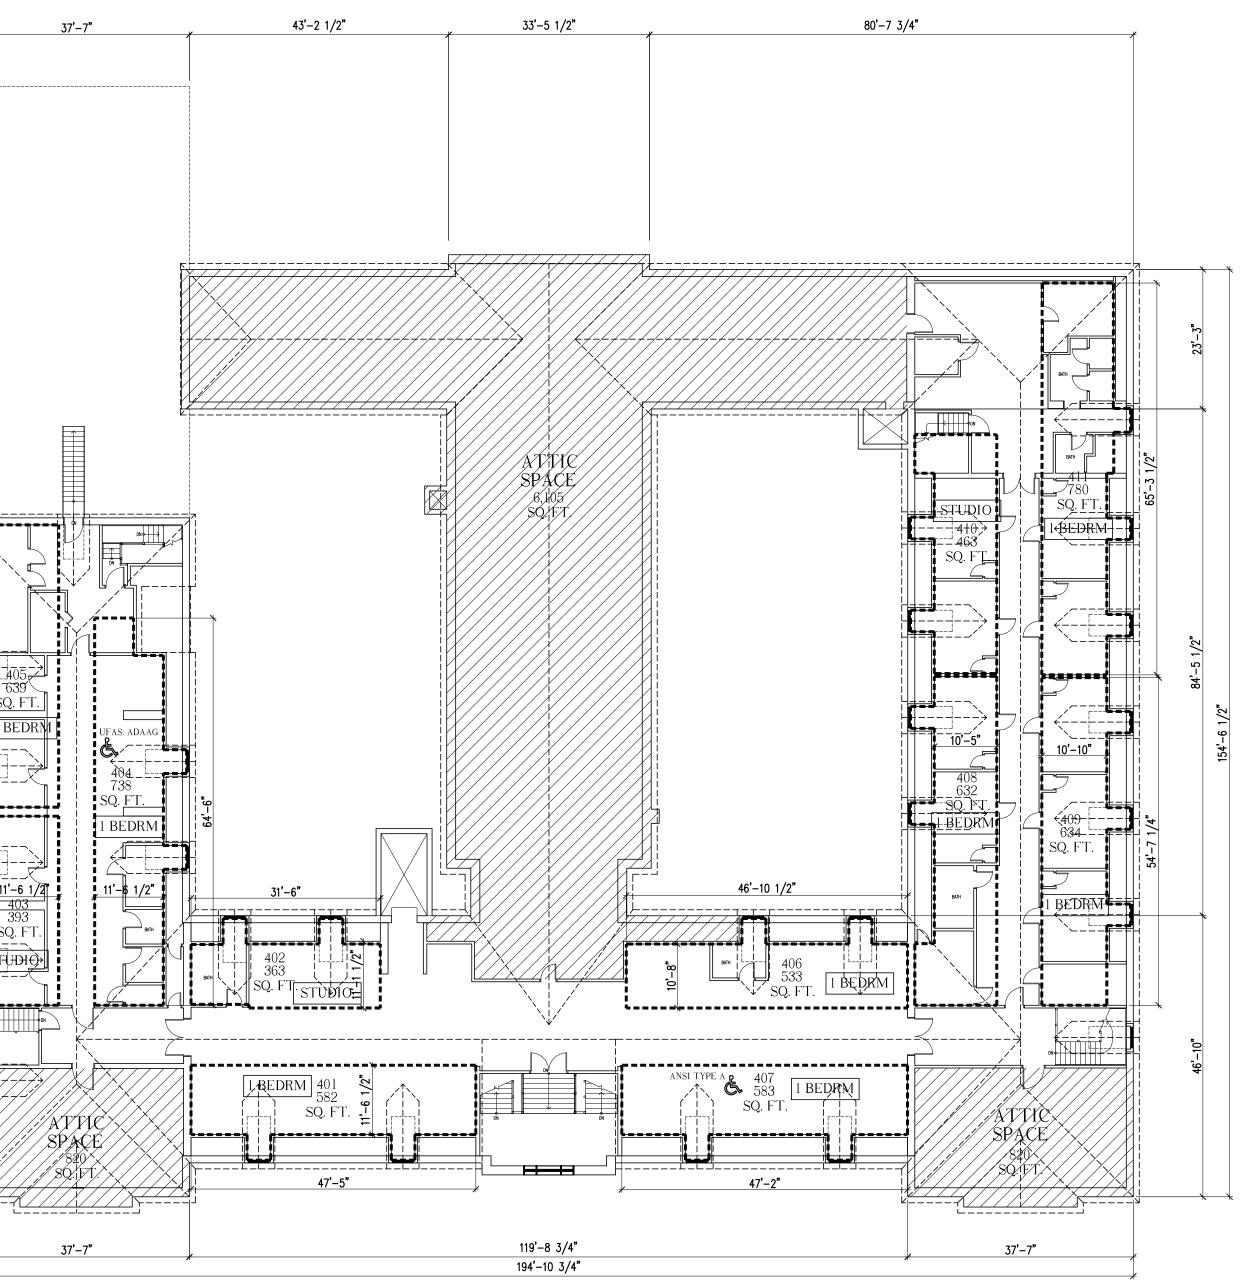


FOURTH FLOOR PLAN


11 UNITS 3 STUDIO UNITS, 8 1 BEDROOM UNITS GROSS AREA (INCL. ATTIC) = 21, 018 SQ. FT GROSS AREA (NOT INCL. ATTIC) = 13, 273 SQ. FT APARTMENTS NET AREA = 6,340 SQ. FT


ŀ	Date: 3	Scale:	Revisions:	Project:	Architect:	Consulting Engineer:	Owner:	
	23 June 2015	1/16" = 1'-0"						
				INUTHERHUUDE DEINIUK				
				JUISTICH			Developer:	
•	ľ			DNIGODI				
	FOURTH FLOOR PLA				48 Union Wharf Portland Maine 04101			
)	I UUNIII L							
				PORTLAND, MAINE	(207) 772-6022 Fax (207) 772-4056			
)								

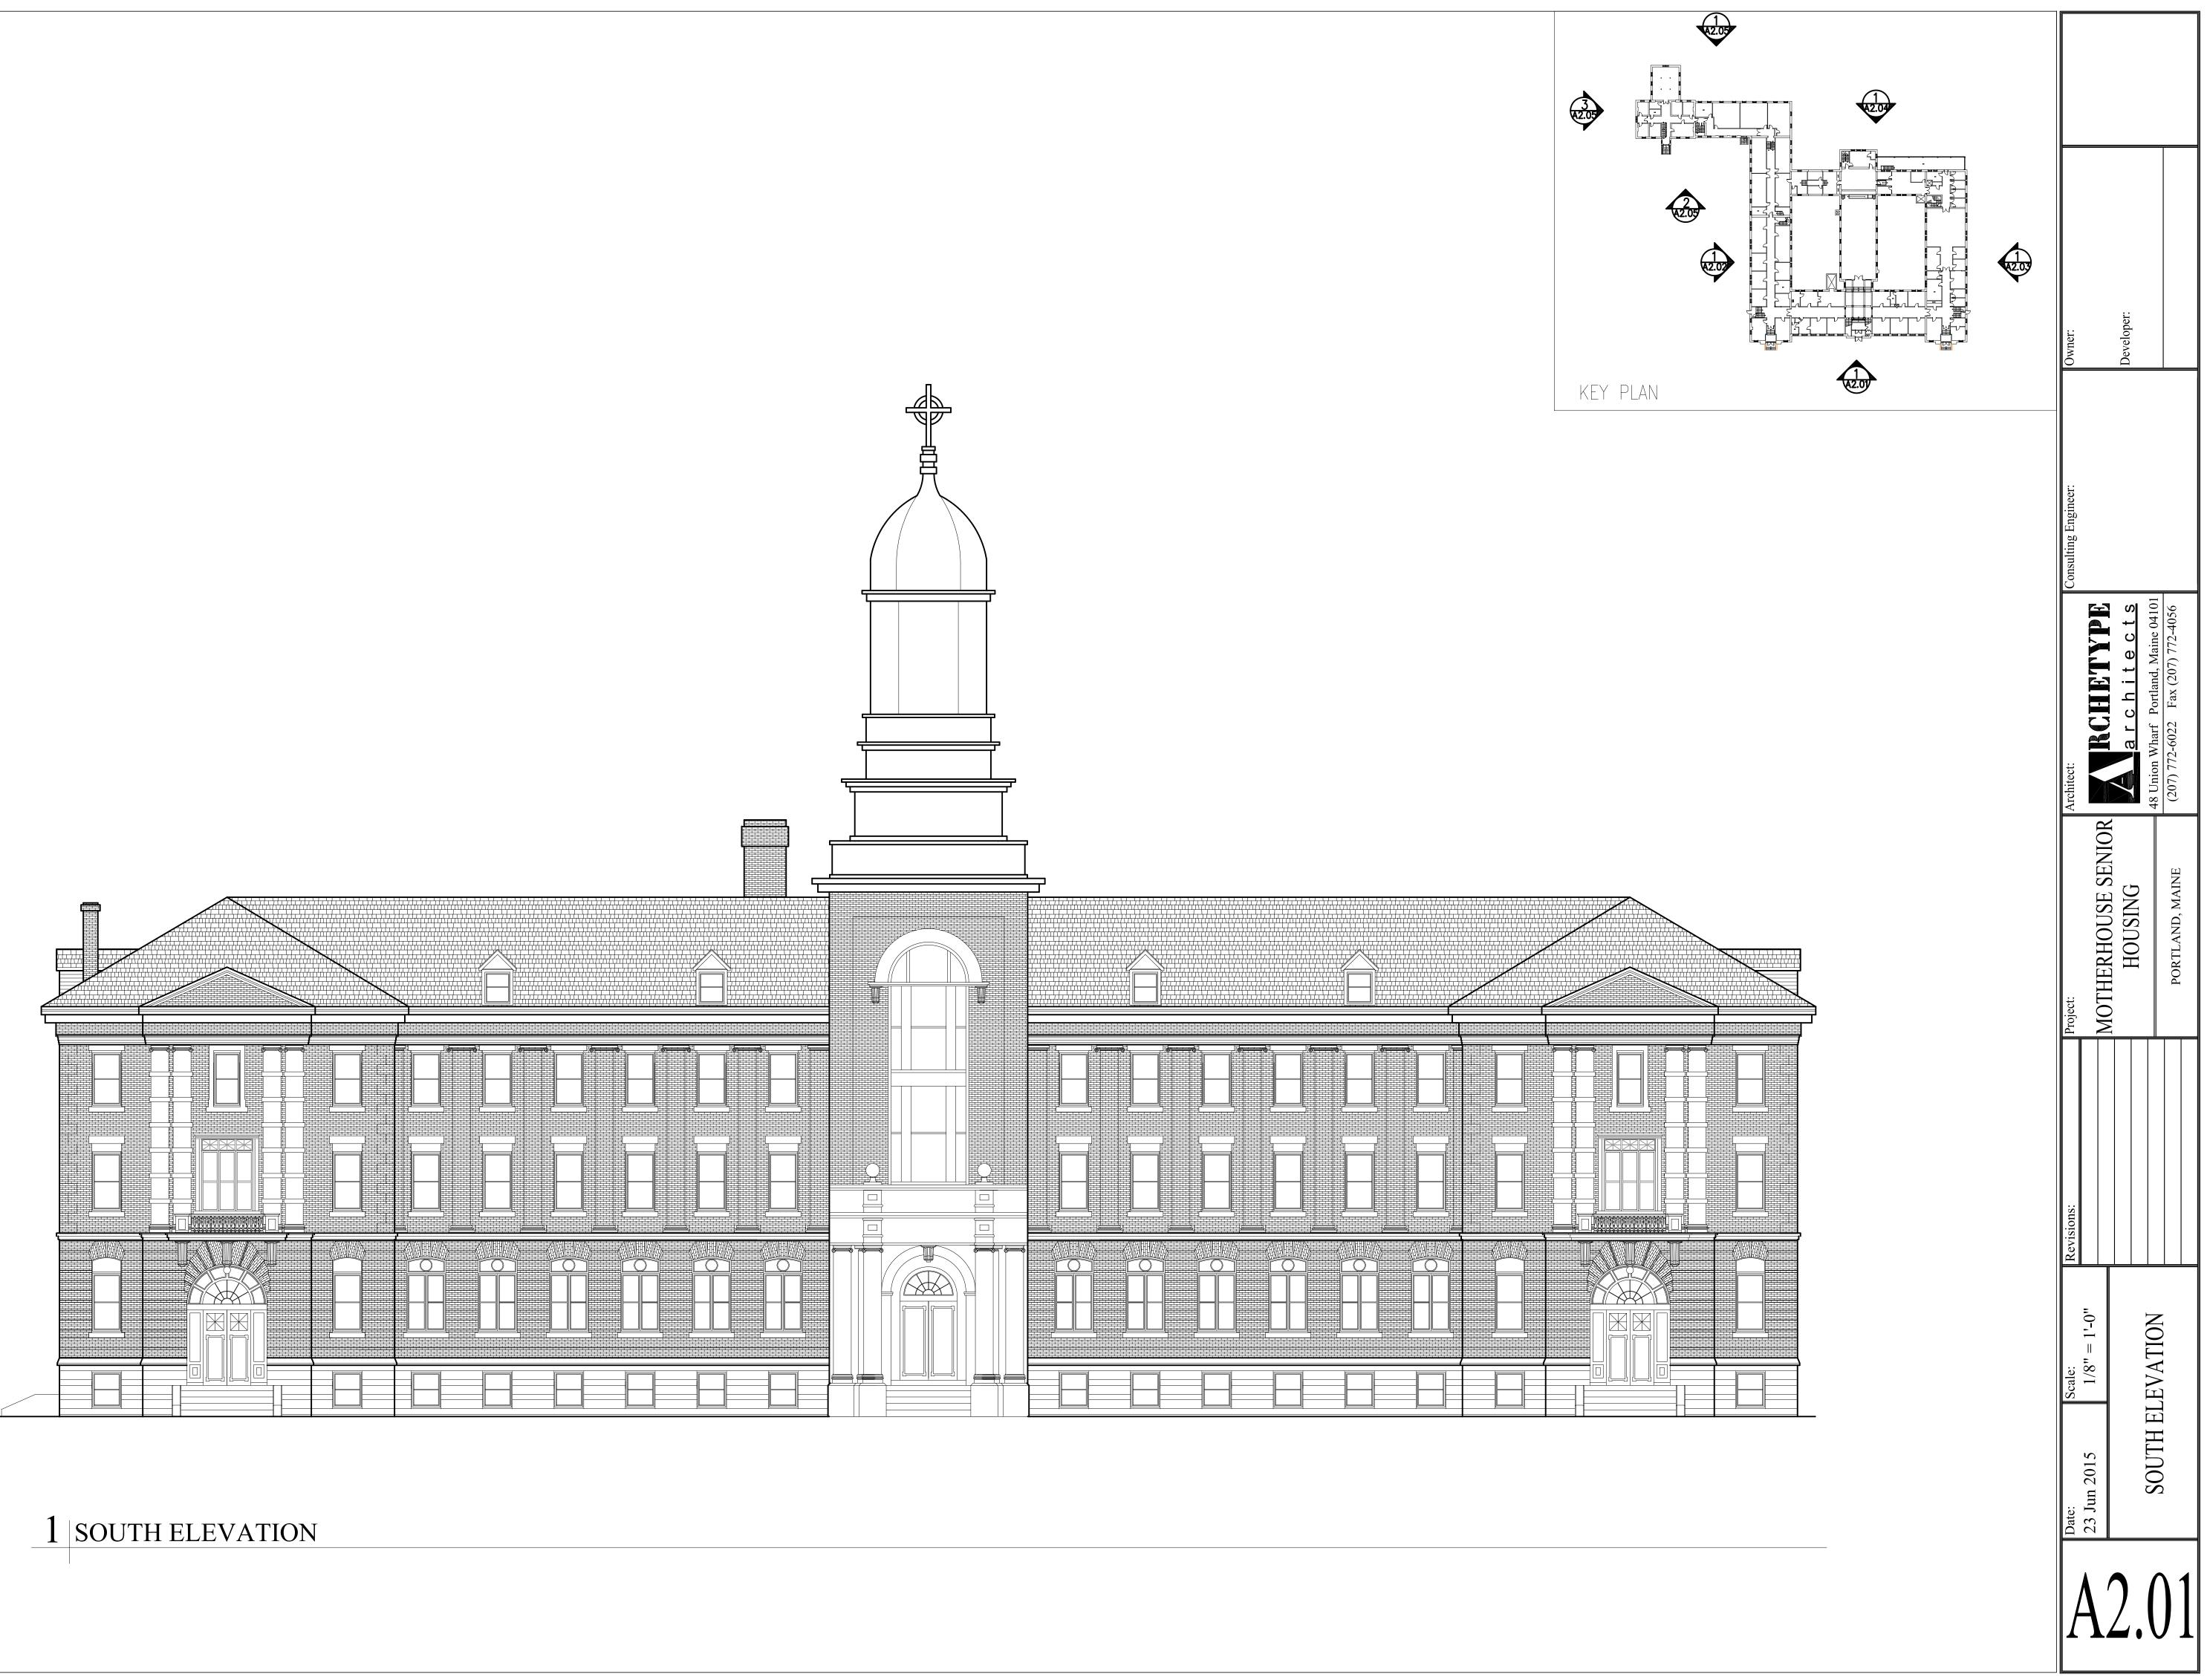


1 WEST ELEVATION

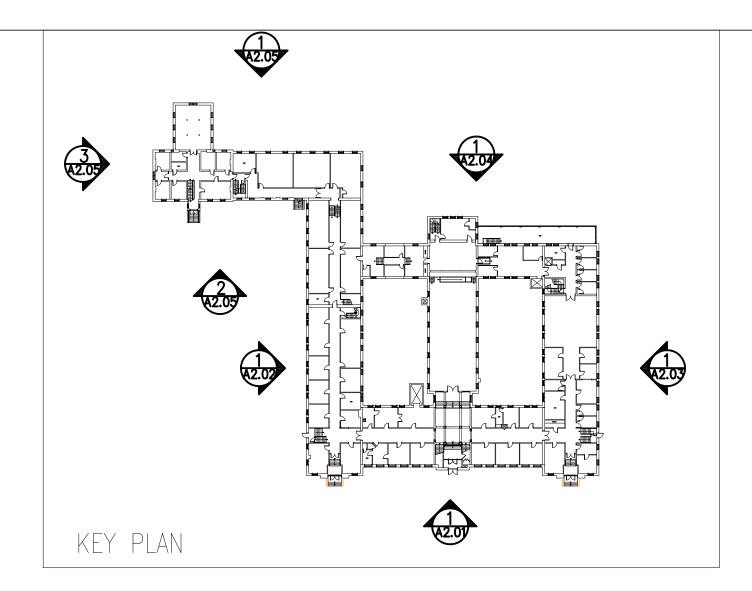


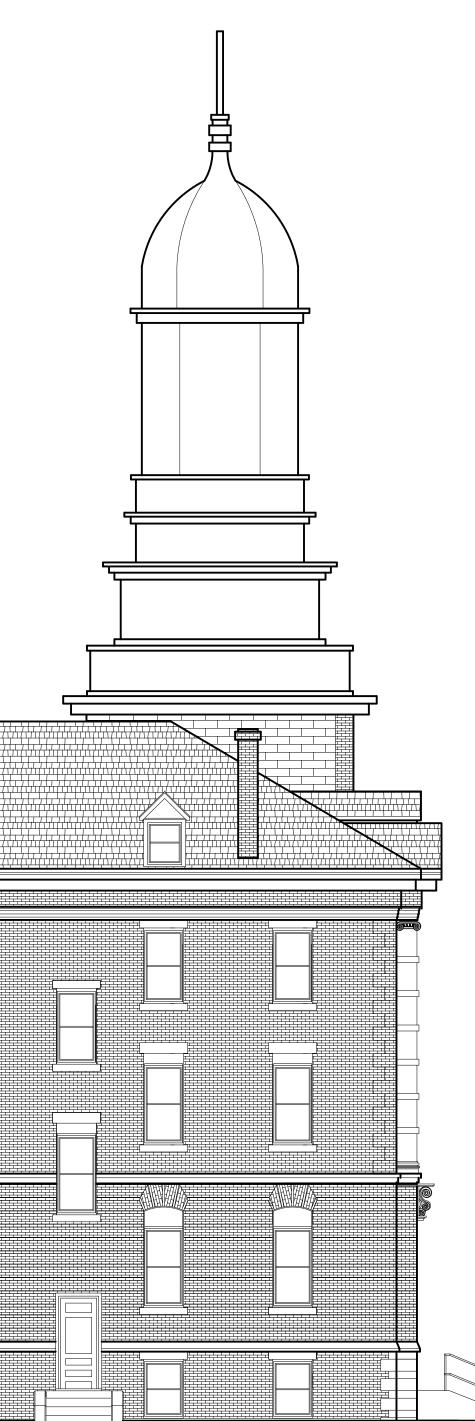

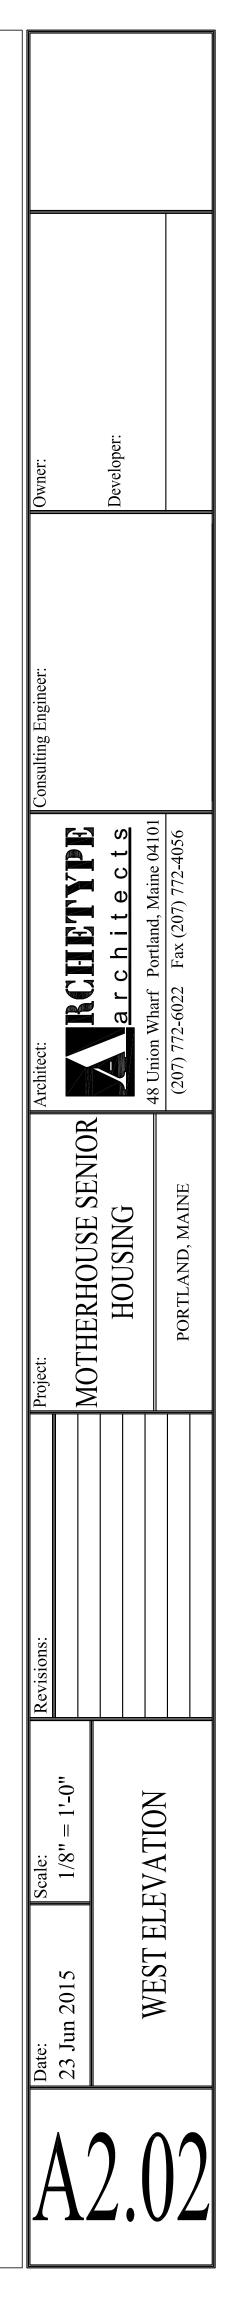

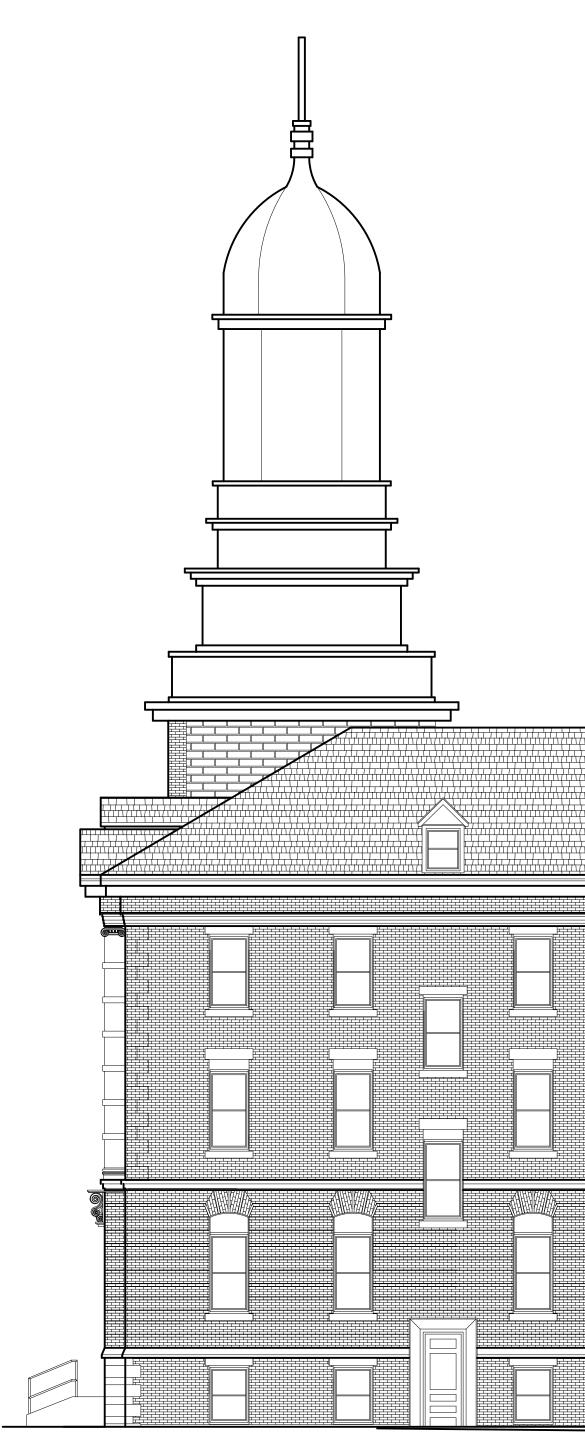


1 EAST ELEVATION

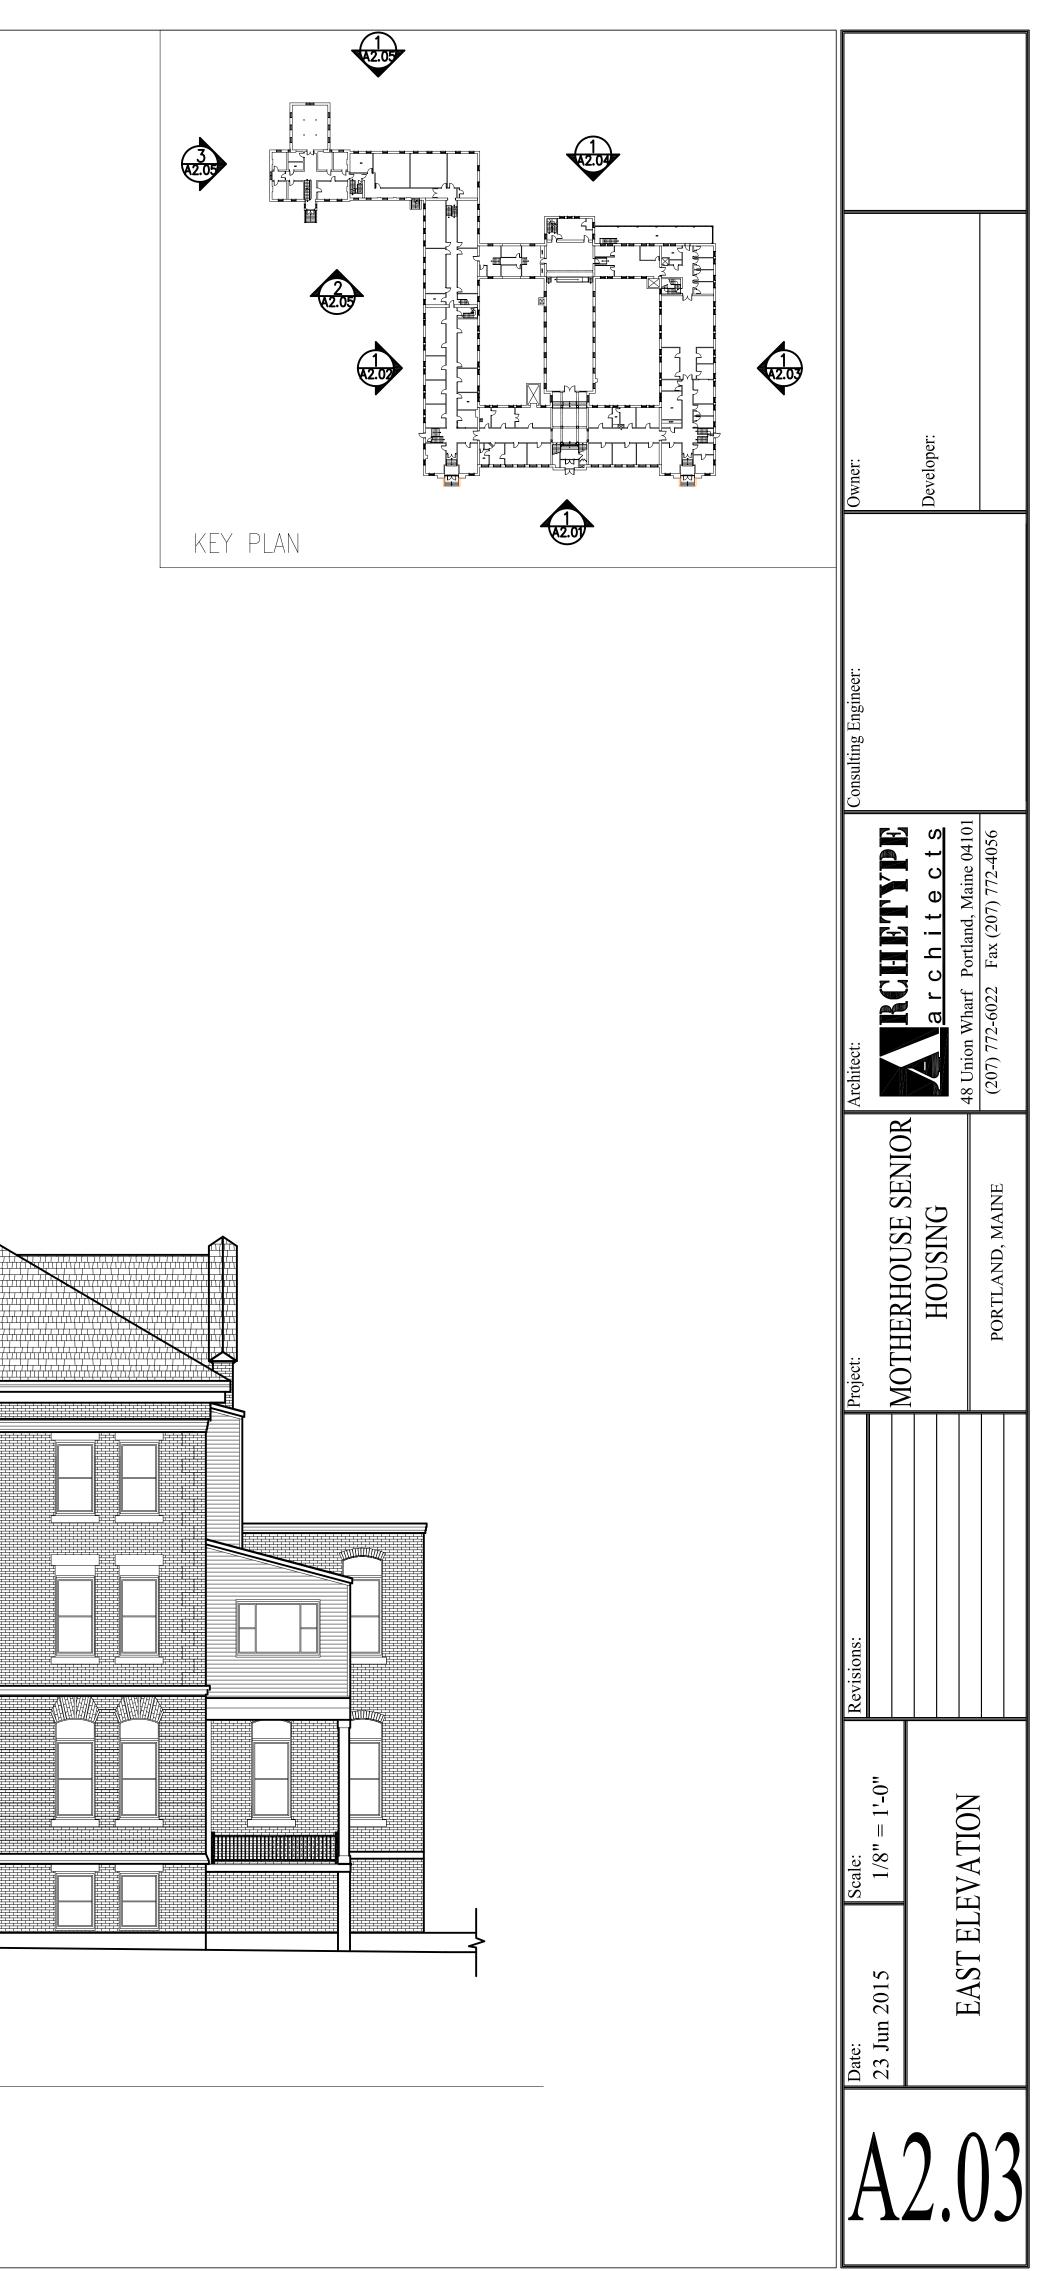





1 NORTH ELEVATION 1

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2 WEST ELEVATION

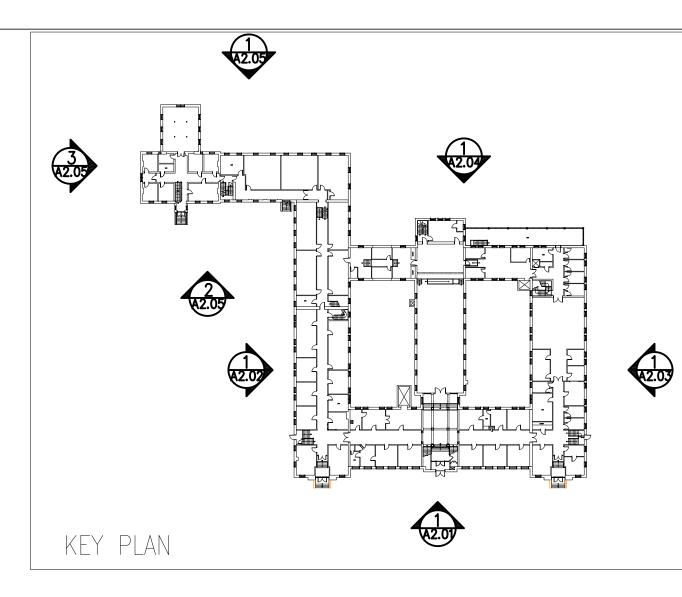

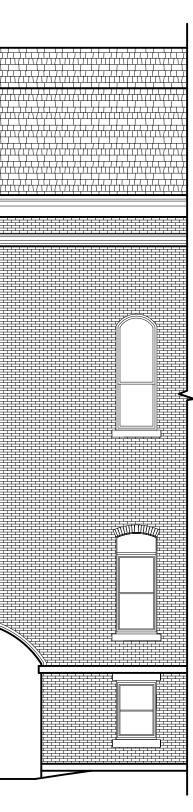1 NORTH ELEVATION 2

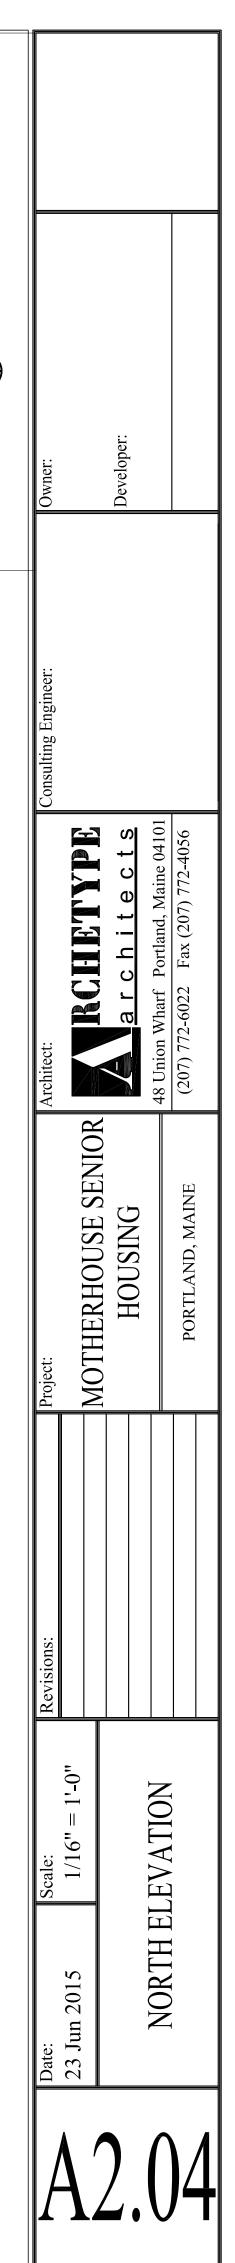

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3 SOUTH ELEVATION

