






Reviewed for Code Compliance Permitting and Inspections Department Approved with Conditions

04/26/2018

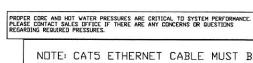

NDTE: CATS ETHERNET CABLE MUST BE RUN TO THE CORE HODD FOR CONNECTING CASLINK MONITORING SYSTEM, ADDITIONAL CHARGES WILL APPLY IF THIS CATS ETHERNET CONNECTION IS NOT PROVIDED IN THE FIELD, THESE CHARGES
WILL BE INVOICED AFTER THE FACTORY
COMMISSIONING OF SYSTEM IF THE CATS
CONNECTION IS NOT PRESENT AT TIME OF COMMISSIONING.

CUSTOMER APPROVAL TO MANUFACTURE Approved as Nated Approved with ND Exception Taken Revise and Resubnit SIGNATURE _



TIET - MODEL SOSOND-E-PEP-F

PLENTIN SPRAY BAR LOCATION



JOB Ellsmere #2 r4	
LOCATION PORTLAND,	ME, 04103
DATE 3/27/2018	JOB # 3339140
DWG # 7	DRAWN BY BFC-21
REV.	SCALE 3/16' = 1'-0'

עטטצ	INF	ORMATION	— Job#,	33391 <i>4</i>	0											
	MAX.						EX	TZUAH	PLENU	М			TOTAL		HOOD CONFIG.	
HOOD	TAG	MODEL				TOTAL RISER(S)					SUPPLY	HOOD	END TO			
ND.	ING	MUDEL	LLINGIII			WIDTH	LENG.	HEIGHT	DIA.	CFM	VEL.	S.P.	CFM	CONSTRUCTION	END	RDW
1		6030	9′ 0″	700	4050	10"	38*	4"		4050	1535	-1.349*	2673	430 SS	ALONE	ALONE
		ND-2-PSP-F	, 0	Deg.	4030	10	30	7		4030	1555	1.547	2075	100%	HEUNE	11011
2		6030	6′ 0″	600 Deo.	1200	10"	11"	4"		1200	1571	-0.518*	1080	430 SS	ALONE	ALONE

PATENT NUMBERS

AC-PSP (United States) - US Patent 7963830 B2 AC-PSP Wall (Canada) - CA Patent 2820509 AC-PSP Island (Canada) - CA Patent 2520330



Reviewed for Code Compliance Permitting and Inspections Department Approved with Conditions

04/26/2018

H00	D IN	F'ORMATION															U
				FILTER(<2			LIGHT(S)					UTILITY CABINET(S)			FIRE	HOOD
HODI	TAC					EFFICIENCY @ 7			WIRE			FI	RE SYSTEM	ELECTRICAL	SWITCHES		MANGING
ND.	'"	TYPE	QTY	'.HEIGHT	LENGTH	MICRONS	QTY.	TYPE	GUARD	LOCATION	SIZE	TYPE	SIZE	MODEL #		PIPING	
1		Captrate Solo Filter	6	20"	16"	85% See Filter Spec.	3	Screw In Compact	ND	Left	12"×60"×30"	CORE Protection	0	SC-311110FP	1 Light 1 Fan	YES	886 886
2		Captrate Solo Filter	4	20"	16"	85% See Filter Spec.	2	Screw In Compact	ND							ND	412 LBS

HOOL	0PT	YONS						
HOOD NO.	TAG	OPTION						
		RISER SENSOR INSTALL GIN PLEN						
		WC-CORE PROTECTION						
1		LEFT WIDE VERTICAL END PANEL 42' Top Width, 36' Bottom Width, 80' High Insulated 430 SS						
		RIGHT WIDE VERTICAL END PANEL 42" Top Width, 36" Bottom Width, 80" High Insulated 430 SS						
		LEFT QUARTER END PANEL 23' Top Width, 0' Bottom Width, 23' High 430 SS						
2		RIGHT QUARTER END PANEL 23" Top Width, 0" Bottom Width, 23" High 430 SS						
		RISER SENSOR INSTALL 6IN PLEN						

PERF	ORAT	ED SU	PPLY .	PLENU	IM(S)							
HOOD					, ,				RISER	(2)		
ND.	TAG	POS.	LENGTH	WIDTH	HEIGHT	TYPE	WIDTH	LENG.	DIA.	CFM	S.P.	
						MUA	12"	20"		667	0.237"	
١, ١		Fmam+	120" 20"	20#	20*	6"	MUA	12"	20"		667	0.237"
1	1 Front 12	120			MUA	12"	20"		667	0.237"		
						MUA	12"	20"		667	0.237"	
2	Front 72" 20"	20"	6"	MUA	12"	20"		540	0.159"			
ے ا		Front	/2-	دن	P	MUA	12"	20"		540	0.159"	

SPECIFICATION: CAPTRATE GREASE-STOP SOLO FILTER


THE CAPTRATE GREASE-STOP SOLO FILTER IS A SINGLE-STAGE FILTER FEATURING A UNIQUE S-BAFFLE DESIGN IN CONJUNCTION WITH A SLOTTED REAR BAFFLE DESIGN, TO DELIVER EXCEPTIONAL FILTRATION EFFICIENCY.


FILTER IS STAINLESS STEEL CONSTRUCTION, AND SIZED TO FIT INTO STANDARD 2-INCH DEEP HOOD CHANNEL(S).

UNITS SHALL INCLUDE STAINLESS STEEL HANDLES AND A FASTENING DEVICE TO SECURE THE TWO COMPONENTS WHEN ASSEMBLED.

GREASE EXTRACTION EFFICIENCY PERFORMANCE SHALL REMOVE AT LEAST 75% OF GREASE PARTICLES FIVE MICRONS IN SIZE, AND 85% GREASE PARTICLES SEVEN MICRONS IN SIZE AND LARGER, WITH A CORRESPONDING PRESSURE DROP NOT TO EXCEED 1.0 INCHES OF WATER GAUGE.

THE CAPTRATE GREASE-STOP SOLO WAS TESTED TO ASTM STANDARD ASTM F2519-05.

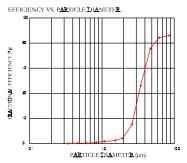

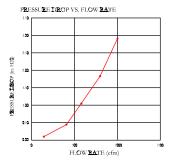

CAPTRATE FILTERS ARE BUILT IN COMPLIANCE WITH. NFPA #96 NSF STANDARD #2 UL STANDARD #1046 INT. MECH. CODE (IMC) ULC-S649







CUSTUMER APPRUVAL I	LI MANUFACTURE:
Approved as Noted	
Approved with NO Exception Taken	
Revise and Resubmit	
SIGNATURE	

Date


OUGTONED ADDRESSAL TO MANUELOTUDE

Your Title





JOBEllsmere #2 r4							
<i>LOCATION</i> PORTLAND, M	E, 04103						
<i>DATE</i> 3/27/2018	<i>JOB #</i> 3339140						
DWG # 1	<i>DRAWN BY</i> BFC-21						
REV.	SCALE 3/8" = 1'-0"						

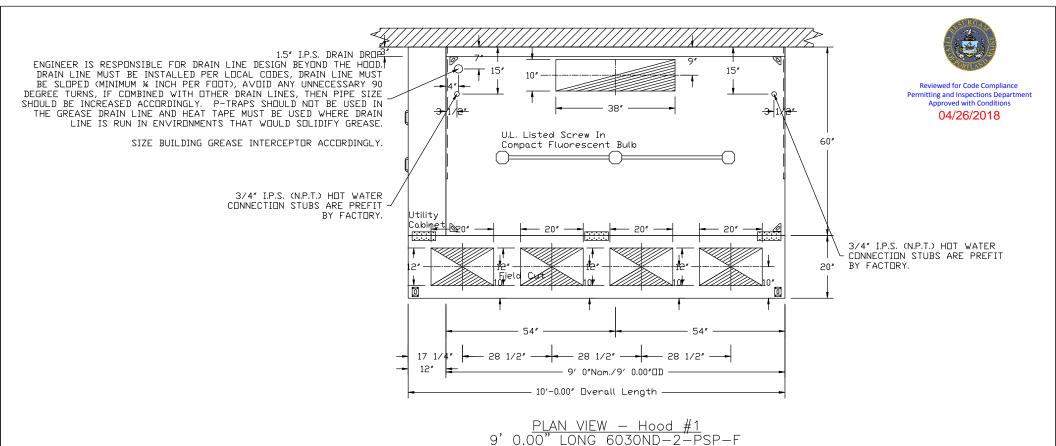

24" MINIMUM OVERHANG IS RECOMMENDED FOR THE FRONT AND BOTH ENDS OF SOLID FUEL COOKING APPLIANCES.


CUSTOMER APPROVAL TO MANUFACTURE:

Approved as Noted
Approved with NO Exception Taken
Revise and Resubmit
SIGNATURE
Your Title
Date






JOBEllsmere #2 r4							
LOCATION PORTLAND, M	E, 04103						
<i>DATE</i> 3/27/2018	<i>JOB #</i> 3339140						
<i>DWG #</i> 2	<i>DRAWN BY</i> BFC-21						
REV.	SCALE 3/8" = 1'-0"						

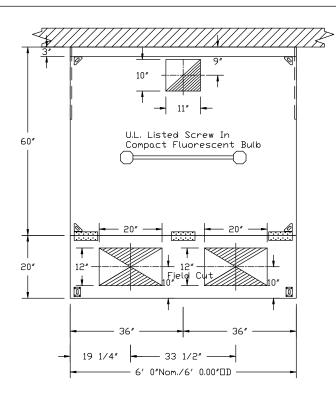

PLAN VIEW - Hood #2 0.00" LONG 6030ND-2-PSP-F

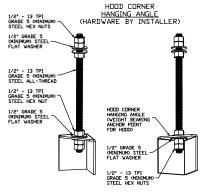


ASSEMBLY INSTRUCTIONS

HANGING ANGLE MUST BE SUPPORTED WITH 1/2' - 13 TPI HANGING ANGLE MUST BE SUPPORTED WITH 1/2' - 13 TPI GRADE 5 (MINIMUM) ALL-THREAD, SANDWICH HANGING ANGLES AND CEILING ANCHOR POINTS WITH 1/2' GRADE 5 ANGLES AND CEILING ANCHOR POINTS WITH 1/2' GRADE 5 (MINIMUM) STEEL FLAT WASHERS AND 1/2" - 13 TPI GRADE 5 (MINIMUM) HEX NUTS AS SHOWN. MUST USE DOUBLED HEX NUT CONFIGURATION BENEATH HOOD HANGING DOUBLED HEX NUT CONFIGURATION ABOVE CEILING ANGLES AND ABOVE CEILING ANCHORS, MAINTAIN 1/4" OF EXPOSED THREADS BENEATH BOTTOM HEX NUT. TORQUE ALL HEX NUTS TO 57 FT-LBS.




ASSEMBLY INSTRUCTIONS

(MINIMUM) STEEL FLAT WASHERS AND 1/2" - 13 TPI GRADE 5 (MINIMUM) HEX NUTS AS SHOWN, MUST USE ANCHORS, SINGLE HEX NUT BENEATH HANGING ANGLE IS ACCEPTABLE FOR FULL LENGTH HANGING ANGLES. MAINTAIN 1/4" OF EXPOSED THREADS BENEATH BOTTOM HEX NUT. TORQUE ALL HEX NUTS TO 57 FT-LBS.

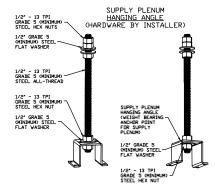

ASSEMBLY INSTRUCTIONS


HANGING ANGLE MUST BE SUPPORTED WITH 1/2" - 13 TPI GRADE 5 (MINIMUM) ALL-THREAD, SANDWICH HANGING ANGLES AND CEILING ANCHOR POINTS WITH 1/2" GRADE 5 (MINIMUM) STEEL FLAT WASHERS AND 1/2" - 13 TPI GRADE 5 (MINIMUM) HEX NUTS AS SHOWN. MUST USE DOUBLED HEX NUT CONFIGURATION ABOVE CEILING ANCHORS. SINGLE HEX NUT BENEATH HANGING ANGLE IS ACCEPTABLE FOR PSP HANGING ANGLES. MAINTAIN 1/4" OF EXPOSED THREADS BENEATH BOTTOM HEX NUT. TORQUE ALL HEX NUTS TO 57 FT-LBS.

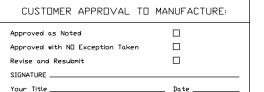





JOBEllsmere #2 r4	
LOCATION PORTLAND, M	E, 04103
<i>DATE</i> 3/27/2018	<i>JOB #</i> 3339140
<i>DWG #</i> 3	<i>DRAWN BY</i> BFC-21
REV.	SCALE 3/8" = 1'-0"

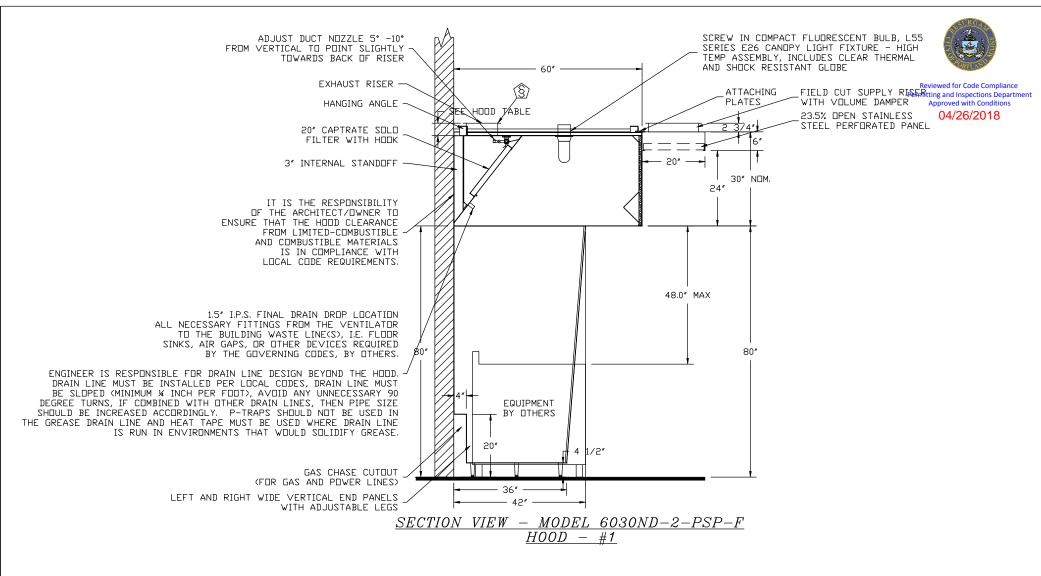

WARNING; FILTER NOISE MAY BE HIGHER THAN NORMAL DUE TO THE CFM REQUREMENT OF THE APPLIANCE BEING USED AND TYPE OF FILTERS THAT ARE REQUIRED.


CUSTOMER APPROVAL TO MA	NUFACTURE:
Approved as Noted	
Approved with NO Exception Taken	
Revise and Resubmit	
SIGNATURE	

Your Title





JOBEllsmere #2 r4							
E, 04103							
<i>JOB #</i> 3339140							
DRAWN BY BFC-21							
SCALE 3/8" = 1'-0"							

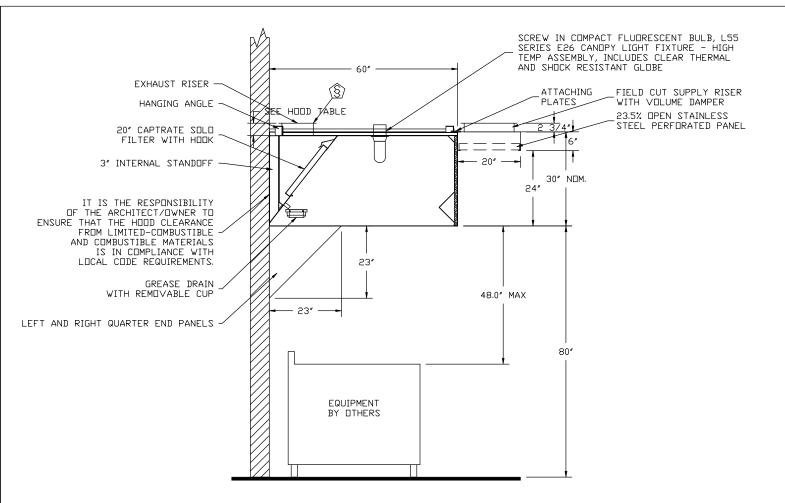



 $\frac{SECTION\ VIEW\ -\ MODEL\ 6030ND-2-PSP-F}{HOOD\ -\ \#2}$

CUSTOMER APPROVAL TO	MANUFACTURE:		
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Approved with N□ Exception Taken			
Revise and Resubmit			
SIGNATURE			
Your Title	Date		





<i>JOB</i> Ellsmere #2 r4	
LOCATION PORTLAND, M	E, 04103
<i>DATE</i> 3/27/2018	<i>JOB #</i> 3339140
<i>DWG</i> # 5	<i>DRAWN BY</i> BFC-21
REV.	SCALE 3/8" = 1'-0"

Fire System Parts List Key

FIRE SYSTEM NO.	TAG	KEY NUMBER - PART DESCRIPTION	QTY. BY FACTORY	QTY. BY DIST.
		34 - 34 - A0019852 24VDC or 120VAC Single Action Manual Actuation Device (Push/Pull Station) With Protective Cover, One (1) Normally Open Contact	1	0
		26 - 26 - QSA-3/8 QUIK SEAL - 3/8' (UL)	10	0
		16 - 16 - 3070-3/8H-10-SS NOZZLE - CORE Protection Appliance Coverage Nozzle (Includes Metal Blow Off Cap, Lanyard, and Chrome-plated pipe)	10	0
1		0 - 0 - A0029078 Junction Box for CORE Protection Manual Pull Station. 1.5" Deep Back Box, Blue	1	0
		0 - 0 - 59361-1/2 2x4 Extension Ring	1	0
		0 - 0 - 12-G28021-005500 Duct Fire Thermostat. ND, Close on temp rise at 500°F.	2	0
		0 - 0 - 100-BW 2x4 Blank Plate for J-Box	1	0

NOTE: EXHAUST DUCTWORK NEEDS TO BE LIQUID TIGHT AND PROPERLY SLOPED BACK TOWARDS HOOD PER CODE. LEAKY DUCTWORK AND DUCTWORK WITH IMPROPER SLOPE WILL NEED TO BE CORRECTED - THIS WILL RESULT IN EXTRA JOBSITE VISITS AND ADDITIONAL CHARGES FOR CORE PRE-TESTS AND TESTS. THE USE OF CAPTIVE-AIRE ETL LISTED GREASE DUCT IS RECOMMENDED.

CUSTOMER APPROVAL TO	MANUFACTURE:
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Approved with N□ Exception Taken	
Revise and Resubmit	
SIGNATURE	
Your Title	Date






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Reviewed for Code Compliance Permitting and Inspections Departmen Approved with Conditions 04/26/2018	it

<i>10B</i> Ellsmere #2 r4	
<i>LOCATION</i> PORTLAND, M	E, 04103
<i>DATE</i> 3/27/2018	<i>JOB #</i> 3339140
<i>DWG</i> # 6	<i>DRAWN BY</i> BFC-21
REV.	SCALE 3/8" = 1'-0"
<u> </u>	<u> </u>

m Operating pressure range at Self Cleaning Panel Gauge is 30 to 70 PSI. Maximum Static Pressure is 125 PSI

Hood # 1 Job # 3339140 Model: ND-2-PSP-F Size: 60'x30" Length: 9' 0"

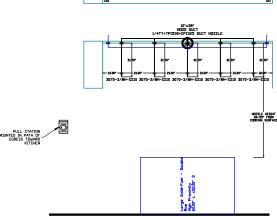

Job #: 3339140 Job Name: Ellsmere #2 r4 Drawn By: System Size: CDRE Total FP required: 0 Hood #1 19'.00' Long x 60' Vide x 30' High Riser #: 1 Size: 10' x 38'



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NOIES

- FIELD PIPE DROPS AS SHOWN

- FIELD PIPE BROPS AS SHOWN


- RELOCATE NOIZZLES IF FILD PATTERN IS BLOCKED BY SHELVING,
SALAMADERS, ETC.

- FACTORY PIPING EXTENDS A MAXIMUM OF 6' ABOVE THE TOP OF THE HOOD.

- APPLIANCE DIMENSIONS LISTED REPRESENT THE COOKING SURFACE SIZE, NOT THE OVERALL APPLIANCE SIZE.
- THIS FIRE SYSTEM COMPLIES WITH U.L. 300 REQUIREMENTS
- CORE / Self Cleaning (United States) US Patent 7963282 B2 CORE / Self Cleaning (Europe) EP Patent 2274069 A1 CORE Supervision US Patent 8378834 B1 CORE Electrical US Patent 8610601 B2

Job #: 339140
Job Nane: Ellsmere #2 r4
Job Nane: Ellsmere #2 r4
Job Nane: Ellsmere #2 r4
John Hood #1 #2 0.00" Long x 60" Vlide x 30" High
Riser # 1 Size: 10" x 38"
Hood #1 #1 Fetal Blow-Diff Caps Included.

- ADDITIONAL FIRESTAT REQUIRED AT END OF DUCT NEAR EXHAUST FAN IF DUCT IS MORE THAN 10' LONG OR THERE IS HORIZONTAL DUCT.

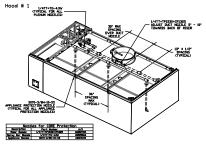

ISOMETRIC VIEWS ARE FOR GRAPHICAL REPRESENTATION OF TYPICAL NOZZLE PLACEMENTS AND TYPE. QUANTITIES OF NOZZLES WILL VARY.

FROM VERTICAL TO POINT SLIGHTLY -23.5% OPEN STAINLESS STEEL PERFORATED PANE EQUIPMENT BY DTHERS GAS CHASE CUTDUT . LEFT AND RIGHT VIDE VERTICAL END PANELS . VITH ADJUSTABLE LEGS SECTION VIEW - MODEL 6030ND-2-PSP-F HOOD - #1

DUCT NOZZLE AND PLENUM SPRAY BAR LOCATION

PROPER CORE AND HOT WATER PRESSURES ARE CRITICAL TO SYSTEM PERFORMANCE. PLEASE CONTACT SALES OFFICE IF THERE ARE ANY CONCERNS OR QUESTIONS REGARDING REQUIRED PRESSURES.

> NOTE: CATS ETHERNET CABLE MUST BE RUN TO THE CORE HOOD FOR CONNECTING CASLINK MONITORING SYSTEM, ADDITIONAL CHARGES WILL APPLY IF THIS CATS ETHERNET CONNECTION IS NOT PROVIDED IN THE FIELD, THESE CHARGES WILL BE INVOICED AFTER THE FACTORY COMMISSIONING OF SYSTEM IF THE CATS CONNECTION IS NOT PRESENT AT TIME OF COMMISSIONING.

CUSTOMER APPROVAL TO MANUFACTURE: Approved as Noted

Approved with NO Exception Taken Revise and Resubmit П SIGNATURE

Your Title





<i>JOB</i> Ellsmere #2 r4		
LOCATION PORTLAND, M	E, 04103	
<i>DATE</i> 3/27/2018	JOB #	3339140
DWG # 7	DRAWN	<i>BY</i> BFC-21
REV.	SCALE	3/16" = 1'-0"

EXHAUST FAN INFORMATION - Job#3339140 FAN UNIT ND. DISCHARGE WEIGHT TAG FAN UNIT MODEL # ESP. RPM H.P. B.H.P. ø VOLT FLA SONES VELOCITY (LBS.) 1 12ft DU180HFA 3000 1.500 1313 3.000 1.2100 3 230 8.6 693 FPM 226 19.1 2 0.1950 5.2 380 FPM 132 9.1 6ft DU85HFA 1200 0.650 995 0.750 230 3 9ft 3.0110 3 230 14.3 27 CASRE24DD 4050 1.750 1142 5.000 1375 FPM 559

Reviewed for Code Compliance Permitting and Inspections Department Approved with Conditions

04/26/2018

Λ	IUA	FAN INFORMATION - Job#3339140															
	FAN UNIT ND.	TAG	FAN UNIT MODEL #	BLOWER	HOUSING	MIN CFM	DESIGN CFM	ESP.	RPM	H.P.	B.H.P.	Ø	VOLT	FLA	WEIGHT (LBS.)	SONES	BURNER EFFICIENCY(%)
	4	12ft & 6ft	A2-20D	20MF-2-MOD	A2	-	3480	0.500	1230	2.000	1.0770	3	230	5.5	442	14	
	5	9ft	A2-D.250-20D	20MF-2-MOD	A2-D.250	2000	2673	0.500	1136	2.000	0.8310	3	230	5.5	908	9.4	92

GAS	FIREI	MAKE	-UP AII	R $UNIT(S)$)	
FAN UNIT NO.	TAG	INPUT BTUs	OUTPUT BTUs	TEMP. RISE	REQUIRED INPUT GAS PRESSURE	GAS TYPE
5	9ft	220185	202570	71 deg F	7 in. w.c 14 in. w.c.	Natural

with VFD) - Three Phase Only 1 - AC Interlock Relay - 24VAC Coil 1 - Motorized Backdraft Damper for A2-D Housing 1 - Full Crating For Commercial Heater 1 - Low Fire Start 5 9ft	ביו אז	OPTIONS							
1 - Full Crating For Exhaust Fans 1 12ft 1 - 3 Year Extended Motor Warranty 1 - Fan Base Ceramic Seal - Ship Loose - For Grease Ducts 1 - Hinge Kit - Ships Loose for Curb Supplied by Others 1 - Grease Box 1 - Full Crating For Exhaust Fans 2 6ft 1 - 3 Year Extended Motor Warranty 1 - Fan Base Ceramic Seal - Ship Loose - For Grease Ducts 1 - ECM Wiring Package-Exhaust - PWM Signal from ECPMO3 Prewire (NIDEC Motor) 1 - Full Crating For Exhaust Fans 1 - Utility Set Grease Cup 1 - 3 Year Extended Motor Warranty 1 - Fan Base Ceramic Seal - Ship Loose - For Grease Ducts 1 - RE24DD - High Temperature Heat & Smoke Option. 1 - RE24D - High Temperature Heat & Smoke Option. 1 - RE24 - Discharge Extension Assembly With Hardware. 1 - Full Crating For Untempered Fans 1 - 3 Year Extended Motor Warranty 4 12ft & 6ft 1 - Gravity Backdraft Damper for Size 2 Housing 1 - Separate 120V Wiring Package (Required and used only for DCV or Prewire with VFD) - Three Phase Only 1 - AC Interlock Relay - 24VAC Coil 1 - Motorized Backdraft Damper for A2-D Housing 1 - Full Crating For Commercial Heater 1 - Low Fire Start 5 9ft 1 - Inlet Pressure Gauge, 0-35' 1 - Manifold Pressure Gauge, 0-5 to 15' wc	FAN UNIT		OPTION (Qty Descr.)						
1 - 3 Year Extended Motor Warranty 1 - Fan Base Ceramic Seal - Ship Loose - For Grease Ducts 1 - Hinge Kit - Ships Loose for Curb Supplied by Others 1 - Grease Box 1 - Full Crating For Exhaust Fans 1 - 3 Year Extended Motor Warranty 1 - Fan Base Ceramic Seal - Ship Loose - For Grease Ducts 1 - ECM Wiring Package-Exhaust - PWM Signal from ECPMO3 Prewire (NIDEC Motor) 1 - Full Crating For Exhaust Fans 1 - Utility Set Grease Cup 1 - 3 Year Extended Motor Warranty 1 - Fan Base Ceramic Seal - Ship Loose - For Grease Ducts 1 - RE24DD - High Temperature Heat & Smoke Option. 1 - RE24DD - High Temperature Heat & Smoke Option. 1 - RE24DD - High Temperature Heat & Smoke Option. 1 - Full Crating For Untempered Fans 1 - 3 Year Extended Motor Warranty 4 12ft & 6ft 1 - Gravity Backdraft Damper for Size 2 Housing 1 - Separate 120V Wiring Package (Required and used only for DCV or Prewire with VFD) - Three Phase Only 1 - AC Interlock Relay - 24VAC Coll 1 - Motorized Backdraft Damper for A2-D Housing 1 - Full Crating For Commercial Heater 1 - Low Fire Start 1 - Inlet Pressure Gauge, 0-35' 1 - Manifold Pressure Gauge, 0-5 to 15' wc									
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1 - Hinge Kit - Ships Loose for Curb Supplied by Others 1 - Grease Box 1 - Full Crating For Exhaust Fans 1 - 3 Year Extended Motor Warranty 1 - Fan Base Ceramic Seal - Ship Loose - For Grease Ducts 1 - ECM Wiring Package-Exhaust - PWM Signal from ECPMO3 Prewire (NIDEC Motor) 1 - Full Crating For Exhaust Fans 1 - Utility Set Grease Cup 1 - 3 Year Extended Motor Warranty 1 - Fan Base Ceramic Seal - Ship Loose - For Grease Ducts 1 - RE24DD - High Temperature Heat & Smoke Option. 1 - RE24 - Discharge Extension Assembly With Hardware. 1 - Full Crating For Untempered Fans 1 - 3 Year Extended Motor Warranty 1 - Gravity Backdraft Damper for Size 2 Housing 1 - Separate 120V Wiring Package (Required and used only for DCV or Prewire with VFD) - Three Phase Only 1 - AC Interlock Relay - 24VAC Coil 1 - Motorized Backdraft Damper for A2-D Housing 1 - Full Crating For Commercial Heater 1 - Low Fire Start 1 - Inlet Pressure Gauge, 0-35' 1 - Manifold Pressure Gauge, 0-5 to 15' wc	1	12+1	,						
1 - Grease Box 1 - Full Crating For Exhaust Fans 1 - 3 Year Extended Motor Warranty 1 - Fan Base Ceramic Seal - Ship Loose - For Grease Ducts 1 - ECM Wiring Package-Exhaust - PWM Signal from ECPMO3 Prewire (NIDEC Motor) 1 - Full Crating For Exhaust Fans 1 - Utility Set Grease Cup 1 - 3 Year Extended Motor Warranty 1 - Fan Base Ceramic Seal - Ship Loose - For Grease Ducts 1 - RE24DD - High Temperature Heat & Smoke Option. 1 - RE24 - Discharge Extension Assembly With Hardware. 1 - Full Crating For Untempered Fans 1 - 3 Year Extended Motor Warranty 1 - Gravity Backdraft Damper for Size 2 Housing 1 - Separate 120V Wiring Package (Required and used only for DCV or Prewire with VFD) - Three Phase Only 1 - AC Interlock Relay - 24VAC Coil 1 - Motorized Backdraft Damper for A2-D Housing 1 - Full Crating For Commercial Heater 1 - Low Fire Start 1 - Inlet Pressure Gauge, 0-35' 1 - Manifold Pressure Gauge, 0-5 to 15' wc			·						
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1 - Full Crating For Untempered Fans 1 - 3 Year Extended Motor Warranty 1 - Gravity Backdraft Damper for Size 2 Housing 1 - Separate 120V Wining Package (Required and used only for DCV or Prewire with VFD) - Three Phase Dnly 1 - AC Interlock Relay - 24VAC Coll 1 - Motorized Backdraft Damper for A2-D Housing 1 - Full Crating For Commercial Heater 1 - Low Fire Start 1 - Inlet Pressure Gauge, 0-35' 1 - Manifold Pressure Gauge, -5 to 15' wc									
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1 - Motorized Backdraft Damper for A2-D Housing 1 - Full Crating For Commercial Heater 1 - Low Fire Start 5 9ft 1 - Inlet Pressure Gauge, 0-35' 1 - Manifold Pressure Gauge, -5 to 15' wc			1 - Separate 120V Wiring Package (Required and used only for DCV or Prewire with VFD) - Three Phase Only						
1 - Full Crating For Commercial Heater 1 - Low Fire Start 5 9ft 1 - Inlet Pressure Gauge, 0-35' 1 - Manifold Pressure Gauge, -5 to 15' wc			1 - AC Interlock Relay - 24VAC Coil						
1 - Low Fire Start 5 9ft 1 - Inlet Pressure Gauge, 0-35' 1 - Manifold Pressure Gauge, -5 to 15' wc			1 - Motorized Backdraft Damper for A2-D Housing						
5 9ft I - Inlet Pressure Gauge, 0-35' 1 - Manifold Pressure Gauge, -5 to 15' wc			1 - Full Crating For Commercial Heater						
1 - Manifold Pressure Gauge, -5 to 15' wc	5		1 - Low Fire Start						
		9ft							
1 - Separate 120V Wining Package (Required and used only for DCV on Province			1 - Manifold Pressure Gauge, -5 to 15" wc						
with VFD) - Three Phase Only			1 - Separate 120V Wiring Package (Required and used only for DCV or Prewire with VFD) - Three Phase [Inly						
1 - 3 Year Extended Motor Warranty			1 - 3 Year Extended Motor Warranty						

<u>FAN</u>	ACCESSORI	ES					
FAN UNIT	TAG		EXHAUST		SUPF	PLY	
ND.	TAG	GREASE CUP	GRAVITY DAMPER	SIDE DISCHARGE	GRAVITY DAMPER	MOTORIZED DAMPER	WALL MOUNT
1	12ft	YES					
2	6ft	YES					
3	9ft	YES					
4	12ft & 6ft				YES		
5	9ft					YES	

CUSTOMER APPROVAL TO	MANUFACTURE:
Approved as Noted	
Approved with NO Exception Taken	
Revise and Resubmit	
SIGNATURE	
Your Title	Date





<i>JOB</i> Ellsmere #2 r4	
LOCATION PORTLAND, M	E, 04103
<i>DATE</i> 3/27/2018	<i>JOB #</i> 3339140
<i>DWG</i> # 8	<i>DRAWN BY</i> BFC-21
REV.	SCALE 3/8" = 1'-0"

CURB ASSEMBLIES


	ND.	□N FAN	TAG	WEIGHT	ITEM		SIZE		
	2	# 2	6ft	41 LBS	Curb	23.000"W × 23.000"L × 24.000"H	4.000:12.000 Pitch	Vented Hinged	
Γ	3	# 3	9ft	43 LBS	Curb	31.500"W × 31.500"L × 24.000"H	4.000:12.000 Pitch	Vented	
	5	# 5	9ft	88 LBS	Curb	31.000"W × 79.000"L × 24.000"H	4.000:12.000 Pitch	Along Width, Right	Insulated

Reviewed for Code Compliance Permitting and Inspections Department Approved with Conditions

04/26/2018

FA	N SOUND	INFOR	MATIO.	N										
F ON		RPM	LWA	SONES	DBA	DISTANCE FT	OCTAVE 1	OCTAVE 2	OCTAVE 3	OCTAVE 4	OCTAVE 5	OCTAVE 6	OCTAVE 7	OCTAVE 8
	l Exhaus	t 1313	83	19.1	71.5	5	77	82.1	88.6	79.6	72.3	69.8	63.7	57.7
- 7	2 Exhaus	t 995	69.8	9.1	58.3	5	69.7	73.9	70.6	65.3	63	62.8	58	51
- [:	3 Exhaus	t 1142	88.1	27	76.6	5	87.4	88.8	88.2	83.7	82.9	80.7	76.1	71.1
	1 Supply	1230	77	14	65.5	5	74	81.7	76.2	74.5	70.8	68	64.8	60.9
	Supply	1136	70.8	94	59.3	5	67.8	75.5	70.4	67.9	644	62	58.9	55.3

FAN #1 DU180HFA - EXHAUST FAN (12FT)

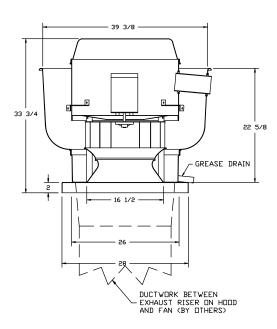

FEATURES:

- DIRECT DRIVE CONSTRUCTION (NO BELTS/PULLEYS)
- ROOF MOUNTED FANS
- RESTAURANT MODEL
- UL705 AND UL762 AND ULC-S645
- VARIABLE SPEED CONTROL
- INTERNAL WIRING
- WEATHERPROOF DISCONNECT
- THERMAL OVERLOAD PROTECTION (SINGLE PHASE)
- HIGH HEAT OPERATION 300°F (149°C)
- GREASE CLASSIFICATION TESTING

NORMAL TEMPERATURE TEST EXHAUST FAN MUST OPERATE CONTINUOUSLY

WHILE EXHAUSTING AIR AT 300°F (149°C) UNTIL ALL FAN PARTS HAVE REACHED THERMAL EQUILIBRIUM, AND WITHOUT ANY DETERIORATING EFFECTS TO THE FAN WHICH WOULD CAUSE UNSAFE OPERATION.

ABNORMAL FLARE-UP TEST
EXHAUST FAN MUST OPERATE CONTINUOUSLY
WHILE EXHAUSTING BURNING GREASE VAPORS AT 600°F (316°C) FOR A PERIOD OF 15 MINUTES WITHOUT THE FAN BECOMING DAMAGED TO ANY EXTENT THAT COULD CAUSE AN UNSAFE CONDITION.

<u>OPTIONS</u>

GREASE BOX FULL CRATING FOR EXHAUST FANS 3 YEAR EXTENDED MOTOR WARRANTY FAN BASE CERAMIC SEAL - SHIP LOOSE - FOR GREASE DUCTS HINGE KIT - SHIPS LOOSE FOR CURB SUPPLIED BY OTHERS

CUSTOMER APPROVAL T	□ MANUFACTURE:
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Approved with NO Exception Taken	
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SIGNATURE	
Your Title	Date






<i>JOB</i> Ellsmere #2 r4					
<i>Location</i> portland, M	E, 04103				
<i>DATE</i> 3/27/2018	<i>JOB #</i> 3339140				
DWG # 9	<i>DRAWN BY</i> BFC-21				
REV.	SCALE 3/8" = 1'-0"				



3000 CFM, 1.5 SP @ 1313 RPM and 1.21 BHP at 86 feet and 70 deg F

* Please note that these curves were adjusted for job specific temperature and altitude.

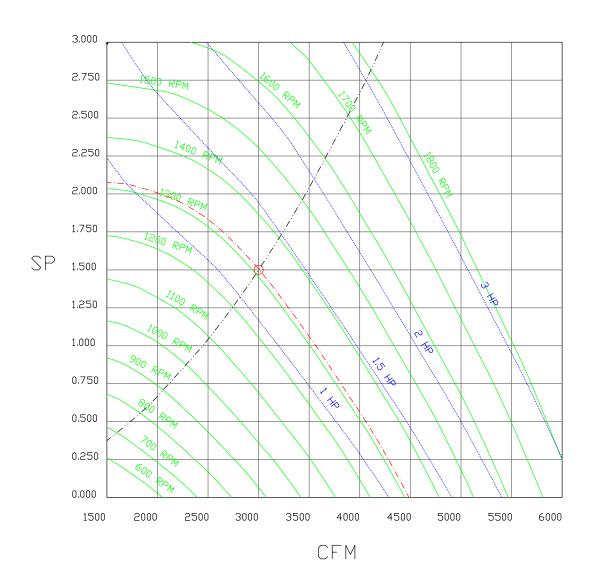


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Your Title Date





JOBEllsmere #2 r4					
LOCATION PORTLAND, M	E, 04103				
<i>DATE</i> 3/27/2018	JOB #	3339140			
<i>DWG</i> # 10	DRAWN	<i>BY</i> BFC-21			
REV.	SCALE	3/8" = 1'-0"			

FAN #2 DU85HFA - EXHAUST FAN (6FT)

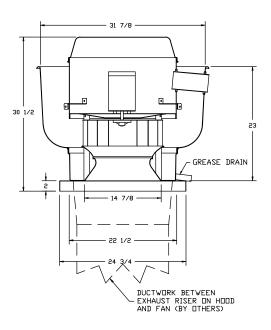

FEATURES:


- DIRECT DRIVE CONSTRUCTION (NO BELTS/PULLEYS)
- ROOF MOUNTED FANS
- RESTAURANT MODEL
- UL705 AND UL762 AND ULC-S645
- VARIABLE SPEED CONTROL
- INTERNAL WIRING
- WEATHERPROOF DISCONNECT - THERMAL OVERLOAD PROTECTION (SINGLE PHASE)
- HIGH HEAT OPERATION 300°F (149°C)
- GREASE CLASSIFICATION TESTING

NORMAL TEMPERATURE TEST
EXHAUST FAN MUST OPERATE CONTINUOUSLY
WHILE EXHAUSTING AIR AT 300°F (149°C) UNTIL ALL FAN PARTS HAVE REACHED THERMAL EQUILIBRIUM, AND WITHOUT ANY DETERIORATING EFFECTS TO THE FAN WHICH WOULD CAUSE UNSAFE OPERATION.

ABNORMAL FLARE-UP TEST EXHAUST FAN MUST OPERATE CONTINUOUSLY WHILE EXHAUSTING BURNING GREASE VAPORS AT 600°F (316°C) FOR A PERIOD OF 15 MINUTES WITHOUT THE FAN BECOMING DAMAGED TO ANY EXTENT THAT COULD CAUSE AN UNSAFE CONDITION.

OPTIONS

GREASE BOX FULL CRATING FOR EXHAUST FANS 3 YEAR EXTENDED MOTOR WARRANTY FAN BASE CERAMIC SEAL - SHIP LOOSE - FOR GREASE DUCTS ECM WIRING PACKAGE-EXHAUST - PWM SIGNAL FROM ECPMO3 PREWIRE (NIDEC MOTOR)

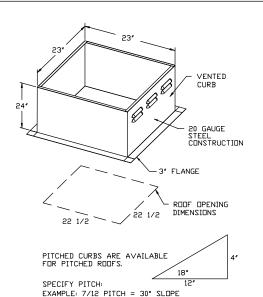










JOBEllsmere #2 r4					
LOCATION PORTLAND, ME, 04103					
<i>DATE</i> 3/27/2018	JOB #	3339140			
DWG # 11	DRAWN	<i>BY</i> BFC−21			
REV.	SCALE	3/8'' = 1'-0''			



1200 CFM, 0.65 SP @ 995 RPM and 0.195 BHP at 86 feet and 70 deg F \ast Please note that these curves were adjusted for job specific temperature and altitude.

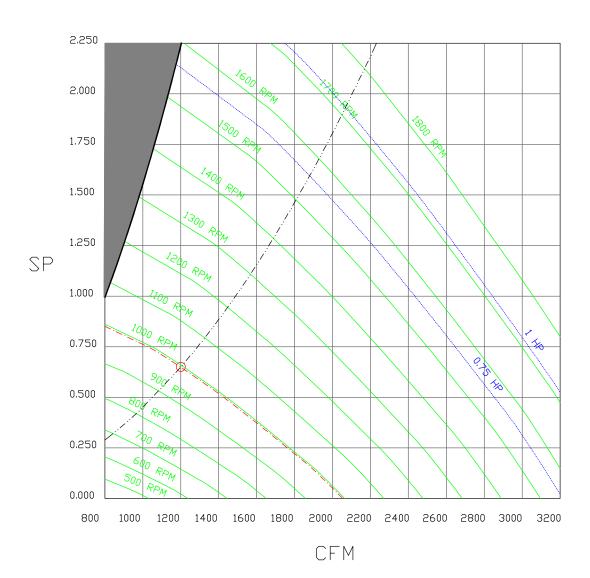

CUSTOMER APPROVAL TO MANUFACTURE:


Approved as Noted
Approved with NO Exception Taken
Revise and Resulpmit
SIGNATURE
Your Title ______ Date _____





JOBEllsmere #2 r4					
LOCATION PORTLAND, M	E, 04103				
<i>DATE</i> 3/27/2018	<i>JOB #</i> 3339140				
<i>DWG</i> # 12	<i>DRAWN BY</i> BFC-21				
REV.	SCALE 3/8" = 1'-0"				

FAN #3 CASRE24DD - EXHAUST FAN (9FT)

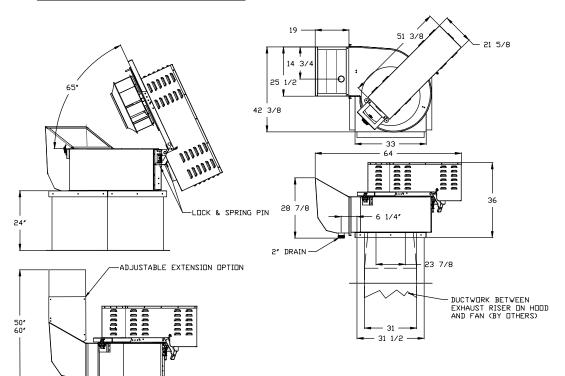

FEATURES:


- ROOF MOUNTED FANS
- RESTAURANT MODEL
- UL762 AND ULC-S645
- HIGH HEAT OPERATION DIRECT DRIVE 300°F (149°C)
- HIGH HEAT OPERATION BELT DRIVE 500°F (260°C)
- HEAT SLINGER
- GREASE CLASSIFICATION TESTING
- TILT OUT WHEEL
- LOCKING PIN FOR POWER PACK
- MOTOR WEATHER COVER
- INTERLOCKED DISCONNECT SWITCH

NORMAL TEMPERATURE TEST DIRECT DRIVE EXHAUST FAN MUST DPERATE CONTINUOUSLY WHILE EXHAUSTING AIR AT 300°F (149°C) UNTIL ALL FAN PARTS HAVE REACHED THERMAL EQUILIBRIUM, AND WITHOUT ANY DETERIORATING EFFECTS TO THE FAN WHICH WOULD CAUSE UNSAFE DPERATION.

ABNORMAL_FLARE-UP_TEST_BELT & DIRECT_DRIVE EXHAUST FAN MUST DERATE CONTINUOUSLY WHILE EXHAUSTING BURNING GREASE VAPDRS AT 600°F (316°C) FOR A PERIOD OF 15 MINUTES WITHOUT THE FAN BECOMING DAMAGED TO ANY EXTENT THAT COULD CAUSE AN UNSAFE CONDITION.

OPTIONS

FULL CRATING FOR EXHAUST FANS
UTILITY SET GREASE CUP
3 YEAR EXTENDED MOTOR WARRANTY
FAN BASE CERAMIC SEAL - SHIP LOOSE - FOR GREASE DUCTS
RE24DD - HIGH TEMPERATURE HEAT & SMOKE OPTION.
RE24 - DISCHARGE EXTENSION ASSEMBLY WITH HARDWARE.

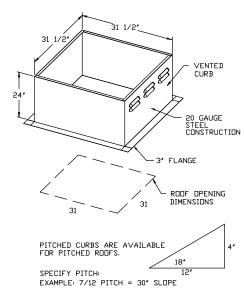

CUSTOMER APPROVAL TO MANUFACTURE:					
Approved as Noted					
Approved with N□ Exception Taken □					
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SIGNATURE					
Your Title Date					





JOB Ellsmere #2 r4					
LOCATION PORTLAND, ME, 04103					
<i>DATE</i> 3/27/2018	JOB #	3339140			
<i>DWG</i> # 13	DRAWN	<i>BY</i> BFC−21			
REV.	SCALE	3/8'' = 1'-0''			

Reviewed for Code Compliance

Permitting and Inspections Department


Approved with Conditions

04/26/2018



4050 CFM, 1.75 SP @ 1142 RPM and 3.011 BHP at 86 feet and 70 deg F

* Please note that these curves were adjusted for job specific temperature and altitude.

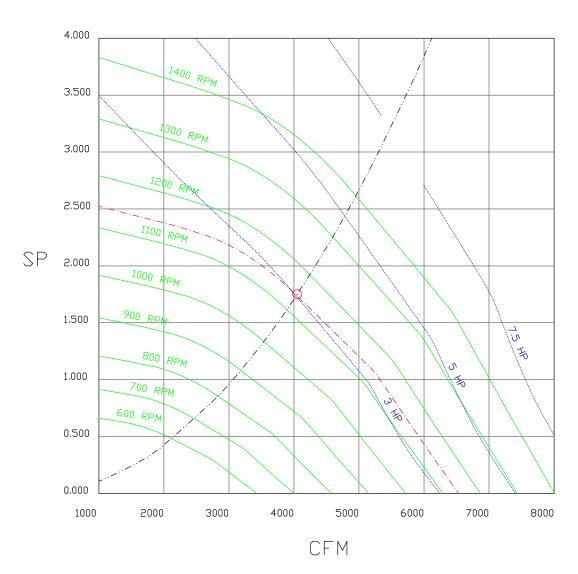

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Approved with N□ Exception Taken	
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SIGNATURE	
Your Title	Date






<i>JOB</i> Ellsmere #2 r4					
<i>Location</i> portland, M	E, 04103				
<i>DATE</i> 3/27/2018	<i>JOB #</i> 3339140				
DWG # 14	<i>DRAWN BY</i> BFC-21				
REV.	SCALE 3/8" = 1'-0"				

FAN #4 A2-20D - SUPPLY FAN (12FT & 6FT)

- 1. UNTEMPERED SUPPLY UNIT WITH 20" DIRECT DRIVE FAN IN SIZE #2 HOUSING
- 2. INTAKE HODD WITH EZ FILTERS
- 3. DOWN DISCHARGE AIR FLOW RIGHT -> LEFT
- 4. FULL CRATING FOR UNTEMPERED FANS FOR SHIPPING.
- 5. 3 YEAR EXTENDED WARRANTY FOR FAN MOTOR. PARTS ONLY; DOES NOT INCLUDE LABOR.
- 6. GRAVITY BACK DRAFT DAMPER 22" X 24", STANDARD GALVANIZED CONSTRUCTION, 1 1/4" REAR FLANGE, FOR SIZE 2 UNTEMPERED FAN HOUSING (5182)

7. SEPARATE 120VAC WIRING PACKAGE FOR MAKE-UP AIR UNITS. OPTION MUST BE SELECTED WHEN MOUNTING VFD IN PREWIRE PANEL OR WITH DCV PACKAGE. PROVIDES SEPARATE 120VAC INPUT TO SUPPLY FAN. THIS 120V SIGNAL MUST BE RUN BY ELECTRICIAN FROM DCV TO MUA SWITCH.

NOTE: SUPPLY DUCT MUST BE INSTALLED TO MEET SMACNA STANDARDS. A MINIMUM STRAIGHT DUCT LENGTH EQUAL TO THREE TIMES THE SUPPLY DUCT EQUIVALENT DIAMETER MUST BE MAINTAINED DOWNSTREAM OF UNIT DISCHARGE UNLESS OTHERWISE SPECIFIED. DO NOT RELY ON UNIT TO SUPPORT DUCT IN ANY WAY.

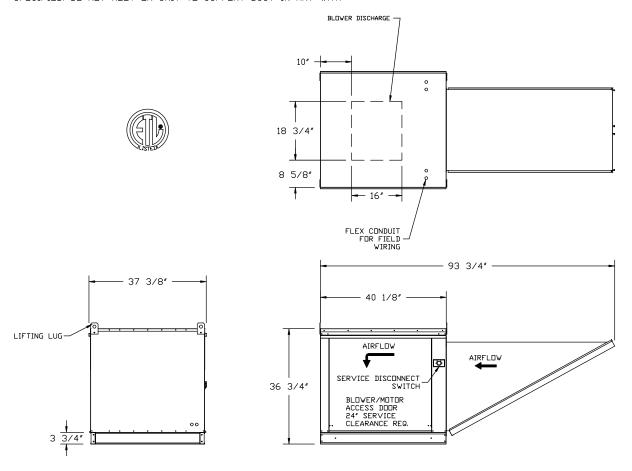

CUSTOMER APPROVAL TO	MANUFACTURE:
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Approved with NO Exception Taken	
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SIGNATURE	
Your Title	Date






Reviewed for Code Compliance
Permitting and Inspections Department
Approved with Conditions
04/26/2018

<i>JOB</i> Ellsmere #2 r4	
LOCATION PORTLAND, M	E, 04103
<i>DATE</i> 3/27/2018	<i>JOB #</i> 3339140
<i>DWG</i> # 15	DRAWN BY BFC-21
REV.	SCALE 3/8" = 1'-0"
·	·



3480 CFM, 0.59 SP @ 1230 RPM and 1.077 BHP at 25 feet and 84 deg F

* Please note that these curves were adjusted for job specific temperature and altitude.

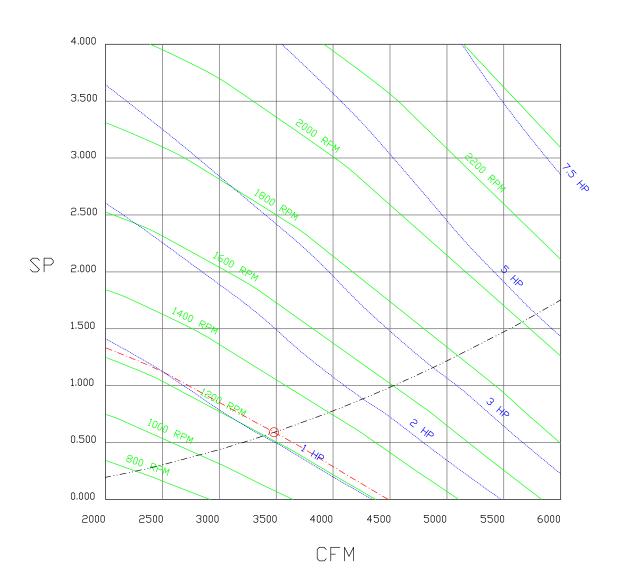

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SIGNATURE	
Your Title	Date





<i>JOB</i> Ellsmere #2 r4		
LOCATION PORTLAND, M	E, 04103	
<i>DATE</i> 3/27/2018	JOB #	3339140
<i>DWG</i> # 16	DRAWN BY	BFC-21
REV.	SCALE 3/8	" = 1'-0"

FAN #5 A2-D.250-20D - HEATER (9FT)

1. DIRECT GAS FIRED HEATED MAKE UP AIR UNIT WITH 20' DIRECT DRIVE FAN

2. INTAKE HODD WITH EZ FILIERS

3. DIOWN DISCHARGE - AIR FLOW RIGHT -> LEFT

4. COOLING INTERLOCK RELAY. 24VAC COIL. 120V CONTACTS. LOCKS OUT BURNER CIRCUIT WHEN AC IS ENERGIZED.

5. MOTIORIZED BACK DRAFT DAMPER 22.75' X 24' FOR SIZE 2 STANDARD & MODULAR HEATER UNITS W/EXTENDED SHAFT,

STANDARD BOLVANIZED CONSTRUCTION, 3/4' REAR FLANGE, LF120S ACTUATOR INCLUDED

6. FULL CRATING FOR COMMERCIAL HEATERS FOR SHIPPING,

7. LOUY FIRE START. ALLOWS THE BURNER CIRCUIT TO ENERGIZE WHEN THE MODULATION CONTROL IS IN A LOW FIRE POSITION.

8. GAS PRESSURE GAUGE, 0-35', 2.5' DIAMETER, 1/4' THREAD SIZE


10. SEPARATE 120VAC WIRING PACKAGE FOR MAKE-UP AIR UNITS. OPTION MUST BE SELECTED WHEN MOUNTING VFD IN PREWIRE PANEL OR WITH DOV PACKAGE. PROVIDES SEPARATE 120VAC WIRING PACKAGE FOR MAKE-UP AIR UNITS. OPTION MUST BE SELECTED WHEN MOUNTING VFD IN PREWIRE PANEL OR WITH DOV PACKAGE. PROVIDES SEPARATE 120VAC WIRING PACKAGE FOR MAKE-UP AIR UNITS. OPTION MUST BE SELECTED WHEN MOUNTING VFD IN PREWIRE PANEL OR WITH DOV PACKAGE. PROVIDES SEPARATE 120VAC WIRING PACKAGE FOR MAKE-UP AIR UNITS. OPTION MUST BE SELECTED WHEN MOUNTING VFD IN PREWIRE PANEL OR WITH DOV PACKAGE. PROVIDES SEPARATE 120VAC WIRING PACKAGE FOR MAKE-UP AIR UNITS. OPTION MUST BE SELECTED WHEN MOUNTING VFD IN PREWIRE PANEL OR WITH DOV PACKAGE. PROVIDES SEPARATE 120VAC INPUT TO SUPPLY FAN. THIS 120V SIGNAL MUST BE RUN BY ELECTRICIAN FROM DOV ARRANTY FOR FAN MOTOR. PARTS ONLY, DOES NOT INCLUDE LABOR.


11. 3 YEAR EXTENDED WARRANTY FOR FAN MOTOR. PARTS ONLY; DOES NOT INCLUDE LABOR.

NOTE: SUPPLY DUCT MUST BE INSTALLED TO MEET SMACINA STANDARDS. A MINIMUM STRAIGHT DUCT LENGTH EQUAL TO THREE TIMES THE SUPPLY DUCT EQUIVALENT DIAMETER MUST BE MAINTAINED DOWNSTREAM OF UNIT DISCHARGE UNLESS OTHERWISE SPECIFIED. DO NOT RELY ON UNIT TO SUPPORT DUCT IN ANY WAY.

SUPPLY SIDE HEATER INFORMATION:

VINTER TEMPERATURE = 4'F. TEMP. RISE = 71'F.
BTUS CALCULATED DFF ACTUAL AIR DENSITY
GUTPUT BIUS AT ALITITUSE OF 0.0 ft. = 202753
INPUT BTUS AT ALITITUSE OF 0.0 ft. = 202530
GUTPUT BTUS AT ALITITUSE OF 25 ft. = 202570
INPUT BTUS AT ALITITUSE OF 25 ft. = 202570

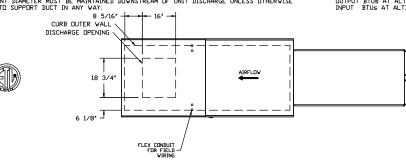

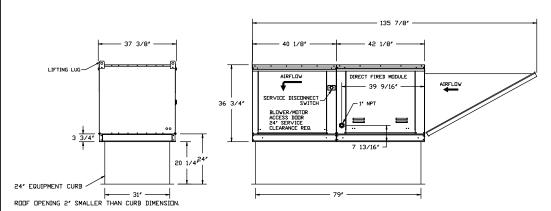



Direct Fired (DF) Profile Pla

CUSTOMER APPROVAL TO MANUFACTURE: Approved with ND Exception Taken Revise and Resubnit Your Title Date





<i>JOB</i> Ellsmere #2 r4		
LOCATION PORTLAND, M	E, 04103	
<i>DATE</i> 3/27/2018	JOB #	3339140
DWG # 17	DRAWN	<i>BY</i> BFC-21
REV.	SCALE	1/4" = 1'-0"
·		·


Reviewed for Code Compliance

Permitting and Inspections Department Approved with Conditions

04/26/2018



2673 CFM, 0.546 SP @ 1136 RPM and 0.831 BHP at 25 feet and 75 deg F ** Please note that these curves were adjusted for job specific temperature and altitude.

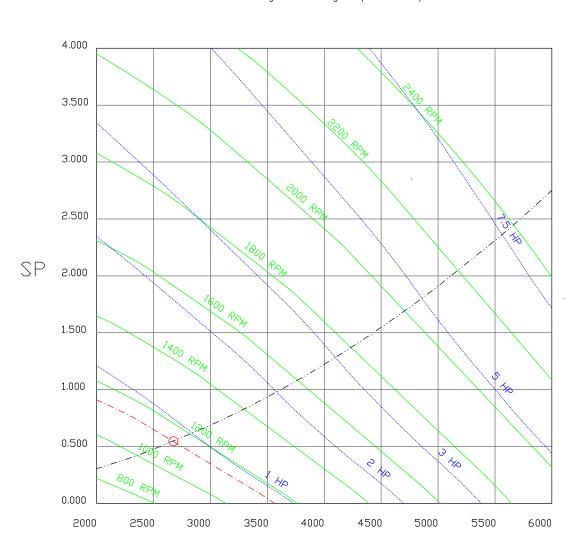

CFM

CUSTOMER APPROVAL TO MANUFACTURE:

Approved as Noted
Approved with NO Exception Taken
Revise and Resubmit
SIGNATURE
Your Title
Date





<i>10B</i> Ellsmere #2 r4	
<i>LOCATION</i> PORTLAND, M	E, 04103
<i>DATE</i> 3/27/2018	<i>JOB #</i> 3339140
<i>DWG #</i> 18	<i>DRAWN BY</i> BFC-21
REV.	SCALE 3/8" = 1'-0"

(


GREASE DUCT & CHIMNEY SPECIFICATIONS:

PROVIDE GREASE DUCT EQUAL TO CAPTIVEAIRE SYSTEMS MODEL "DW" ROUND 20 GAUGE 430 STAINLESS STEEL DUCTWORK, MODEL "DW" IS LISTED TO UL-1978 AND IS INSTALLED USING "V" CLAMP LOCKING CONNECTIONS SEALED WITH 3M FIRE BARRIER 2000 PLUS. MODEL "DW" DOES NOT REQUIRE WELDING PROVIDING IT HAS BEEN INSTALLED PER

THE MANUFACTURES INSTALLATION GUIDE.

PROVIDE RATED ACCESS DOORS AT EVERY CHANGE IN DIRECTION AND EVERY 12' ON CENTER. PER MANUFACTURES LISTING MODEL "DW" HORIZONTAL RUNS LESS THAN 75 FT. CAN BE SLOPED 1/16" PER 12", HORIZONTAL RUNS MORE THAN 75 FT. CAN BE SLOPED 3/16" PER 12". DUCT SHOULD BE SLOPED AS MUCH AS POSSIBLE TO REDUCE THE CHANCE OF GREASE ACCUMULATION IN HORIZONTAL RUNS.

IF THE DUCT OR CHIMNEY IS WITHIN 18 INCHES OF COMBUSTIBLE MATERIAL, PROVIDE UL-2221 OR UL-103 HT LISTED DOUBLE WALL GREASE DUCT OR DOUBLE WALL CHIMNEY EQUAL TO CAPTIVEAIRE SYSTEMS MODEL "DW- 2R, 2R TYPE HT, 3R, OR 3Z" ROUND 20 GAUGE 430 STAINLESS INNER DUCT INSULATED WITH A 24 GAUGE 430 STAINLESS OUTER SHELL.

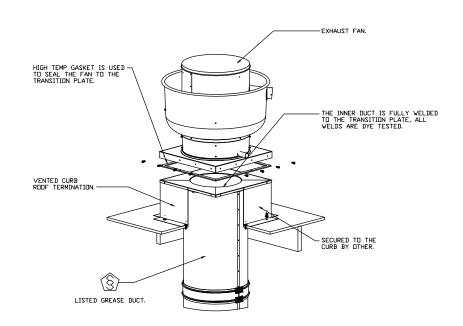







<i>JOB</i> Ellsmere #2 r4		
LOCATION PORTLAND, M	E, 04103	
<i>DATE</i> 3/27/2018	JOB #	3339140
<i>DWG</i> # 19	DRAWN	<i>BY</i> BFC-21
REV.	SCALE	3/8" = 1'-0"


Reviewed for Code Compliance

Permitting and Inspections Department


Approved with Conditions 04/26/2018

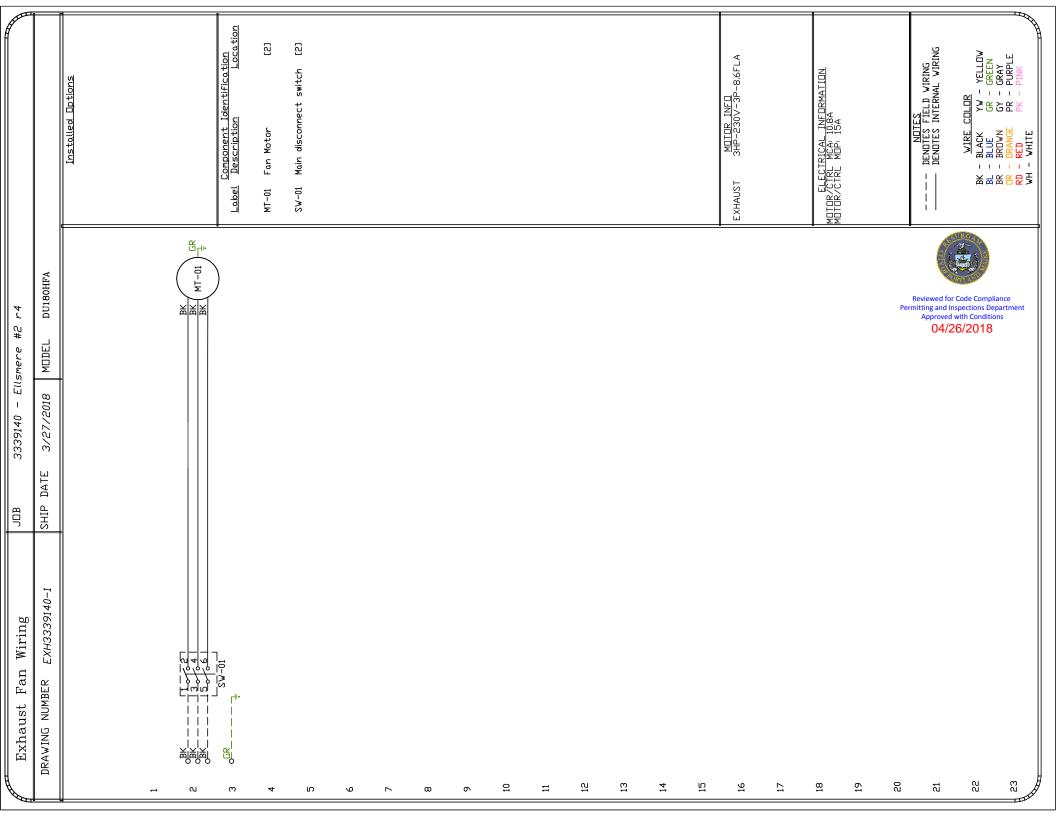


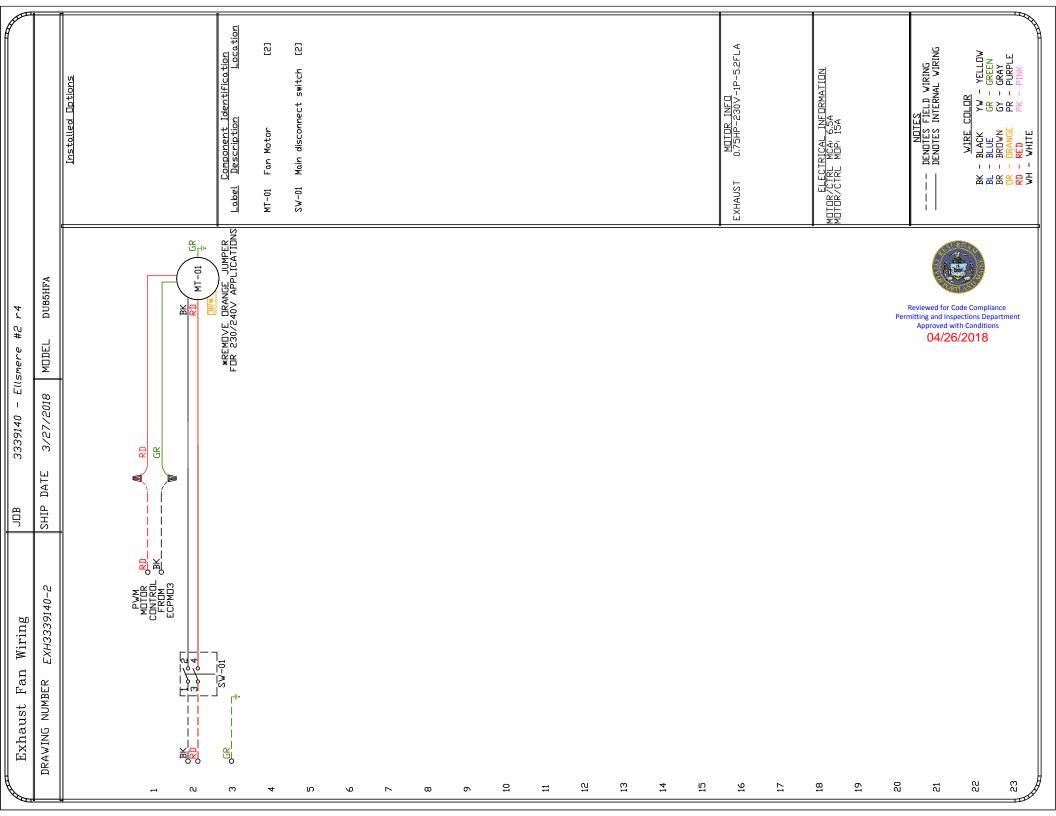

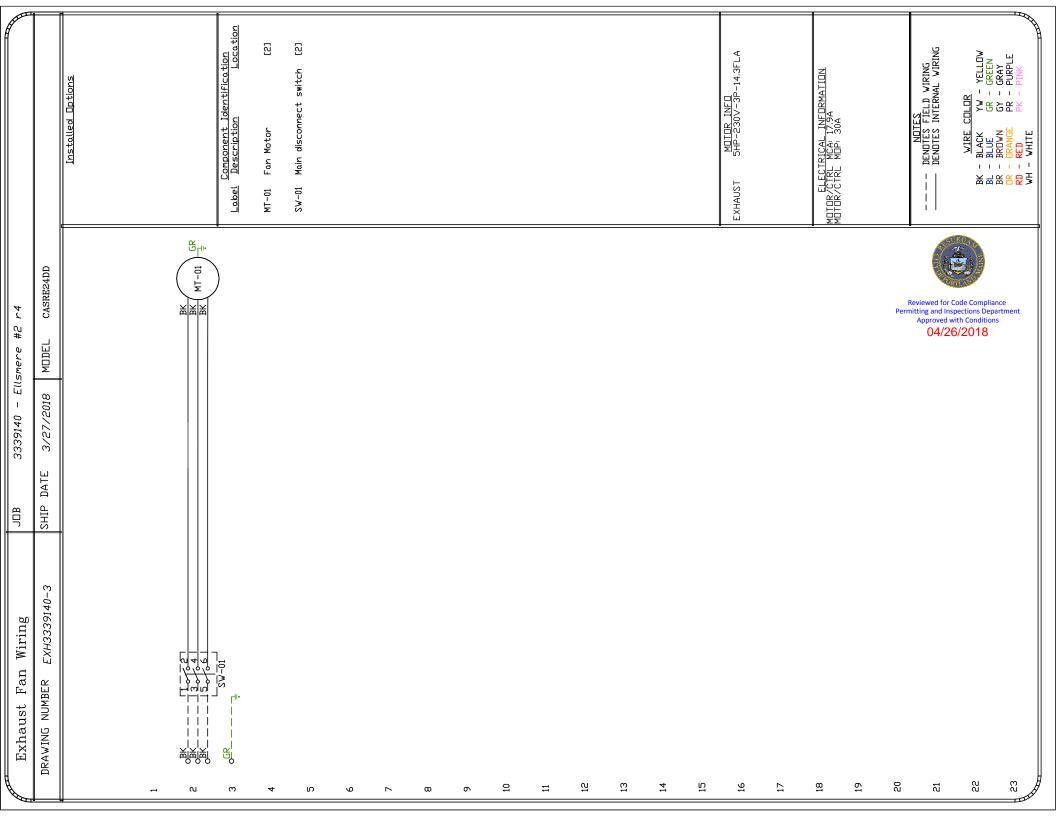

AirHandler Wiring JOB 3339140 - Ellsmere #2 r4	
DRAWING NUMBER 43339140-4 SHIP DATE 3/27/2018 MODEL A2-20D	
INTTENTION ELECTRICIANI DROP FOR DISCONNECT CONNECTION IS FACTORY SUPPLIED CONNECT POWER TO THE DROP	Installed Options DCV/VFD Wiring
BK SH	
Number N	Component Identification Label Description
4 IV	MT-01 Supply motor [2]
VD	
Δ α	
ο σ	
10	
11	SW-01 Main disconnect switch [2]
12	
133	
14	
15	MUTOR INFO SUPPLY 24P-230V-3P-5,5FLA
17	
18	ELECTRICAL INFORMATION MOTOR CIRCUIT MCA: 6.9A CONTROL CIRCUIT MCA: 1.0A
19	MOTOR CIRCUIT MOP: 15A
Permitting a Appro	NOTES DENOTES FIELD VIRING
d for Code Comp nd Inspections D oved with Conditi 4/26/2018	
epartment ions	BR - BROWN GY - GRAY OR - ORANGE PR - PURPLE RD - RED PK - PINK WH - WHITE

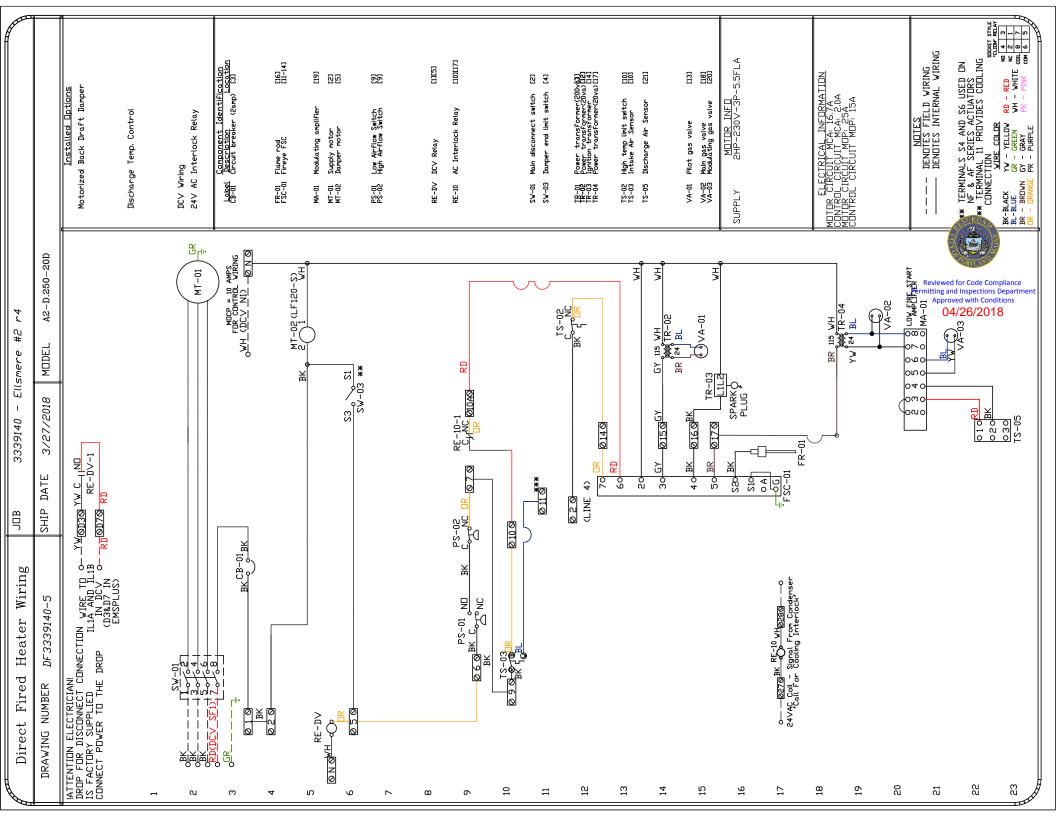


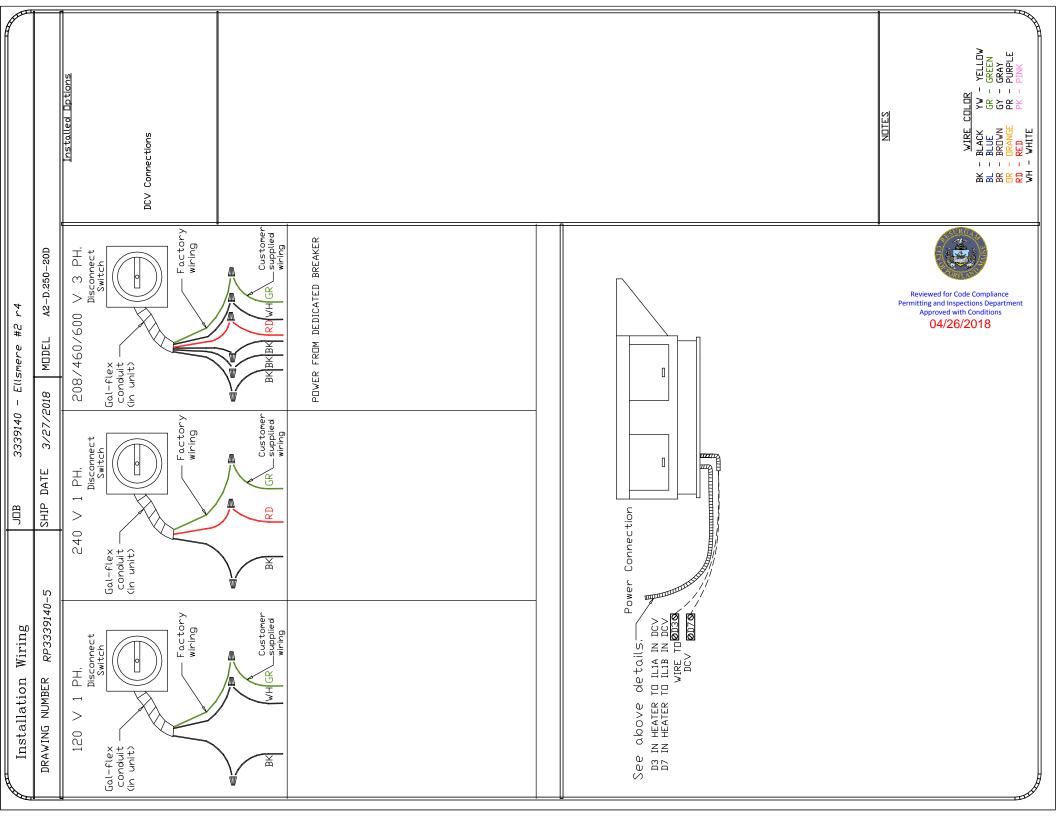

ELECTRICAL PACKAGES 1.1.1.2220110

<u>Ľ L I</u>	SCIRICAL P	<u> ACNAGES -</u>	. J00#333914U									
ND.	TAG	PACKAGE #	 LOCATION	SWITCHES		FANS CONTROLLED						
				LOCATION	QUANTITY	· · - <u>-</u> -·	FAN TAG	TYPE	ф	H.P.	VOLT	FLA
					1 Light		12ft	Exhaust	3	3.000	230	8.6
1	12ft & 6ft	SC-321110FP	Wall Mount In SS Box	05 - SS Wall Mount Box		Smart Controls Thermostatic Control	6ft	Exhaust	1	0.750	230	5.2
					1 Fan		12ft & 6ft	Supply	3	2.000	230	5.5
2	9ft	SC-311110FP	Utility Cabinet Left	03 - Utility Cabinet Left	1 Light	Smart Controls Thermostatic Control	9ft	Exhaust	3	5.000	230	14.3
2) 7 7 T	2C-311110FP	Courty Cabinet Lett	Hood # 1	1 Fan	Smart Controls Inermostatic Control	9ft	Supply	3	2.000	230	5.5



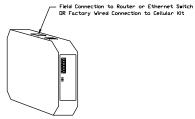

CASlink Monitor and Control

- Hood control panel to support communications to cloud-based Building Management System.
 Hood Control Panel to allow cloud-based Building Management System to monitor real time parameters outlined as MINITOR in the points list.
 Hood Control Panel to allow cloud-based Building Management System to control parameters outlined as CINITOR. In the points list.
 Hood control panel to allow remote changes to system setting such as VFD Frequencies, ECM speeds, temperature set points, fan and wash schedules, etc.

MONITORING AND CONTROL POINTS LIST

DCV Packages	Function
Room Temperature	MONITOR
Duct Temperature(s)	MONITOR
MUA Discharge Temperature	MONITOR
Kitchen RTU Discharge Temperature	MONITOR
Fan Speed	MONITOR
Fan Amperage	MONITOR
Fan Power	MONITOR
VFD Faults	MONITOR
Controller Faults	MONITOR
Fan Faults	MONITOR
Fan Status	MONITOR
PCU Faults	MONITOR
PCU Filter Clog Percentages	MONITOR
Fire Condition	MONITOR
CORE Fire System	MONITOR
Bullding Pressures	MONITOR
Prep Time Button	MONITOR & CONTROL
Fans Button	MONITOR & CONTROL
Lights Button	MONITOR & CONTROL
Wash Button	MONITOR & CONTROL

SC Packages	Function
Room Temperature(s)	MONITOR
Duct Temperature(s)	MONITOR
MUA Discharge Temperature	MONITOR
Kitchen RTU Discharge Temperature	MONITOR
Controller Faults	MONITOR
Fan Faults	MONITOR
Fan Status	MONITOR
PCU Faults	MONITOR
PCU Filter Clog Percentages	MONITOR
Fire Condition	MONITOR
CORE Fire System	MONITOR
Building Pressures	MONITOR
Fans Button(s)	MONITOR & CONTRO
Lights Button(s)	MONITOR & CONTRO
Wash Button	MONITOR & CONTRO


NOTE: CATS ETHERNET CABLE MUST BE RUN TO THE CORE HOOD FOR CONNECTING CASLINK CONNECTION IS NOT PRESENT COMMISSIONING.


CUSTOMER APPROVAL TO	MANUFACTURE:
Approved as Noted	
Approved with NO Exception Taken	
Revise and Resubmit	
SIGNATURE	
Your Title	Date






<i>JOB</i> Ellsmere #2 r4	
LOCATION PORTLAND, M	E, 04103
<i>DATE</i> 3/27/2018	<i>JOB #</i> 3339140
<i>DWG</i> # 26	<i>DRAWN BY</i> BFC-21
REV.	SCALE 3/8" = 1'-0"
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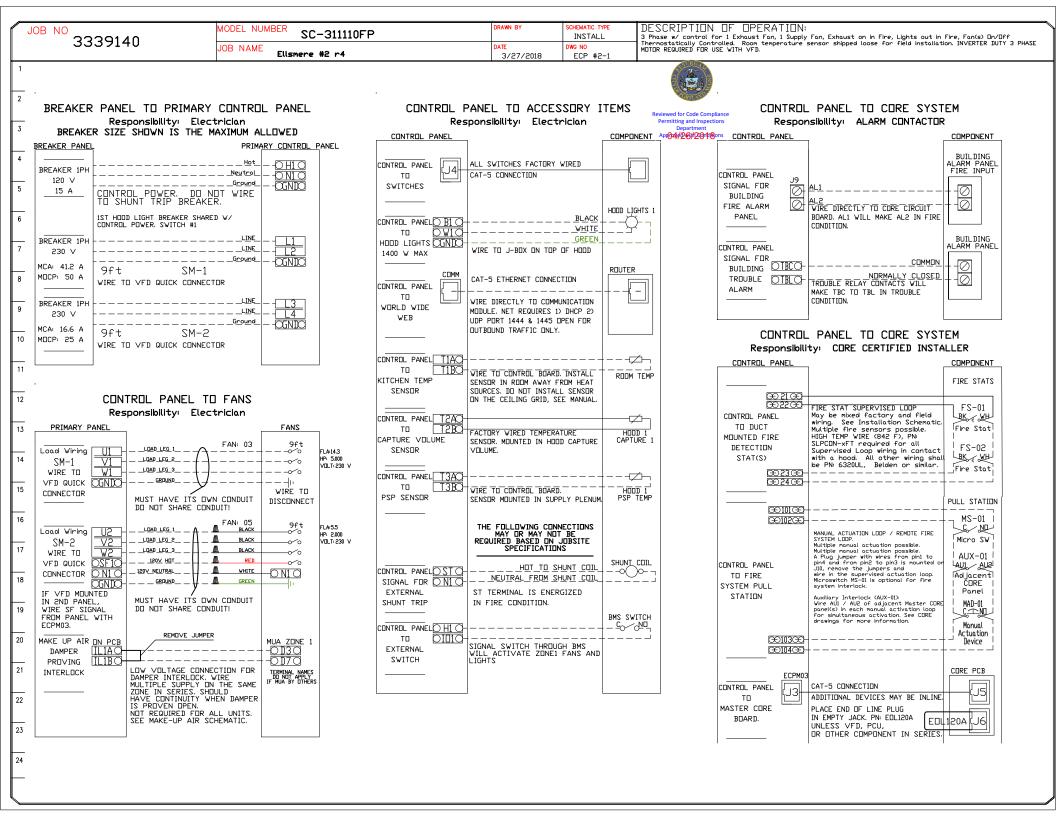


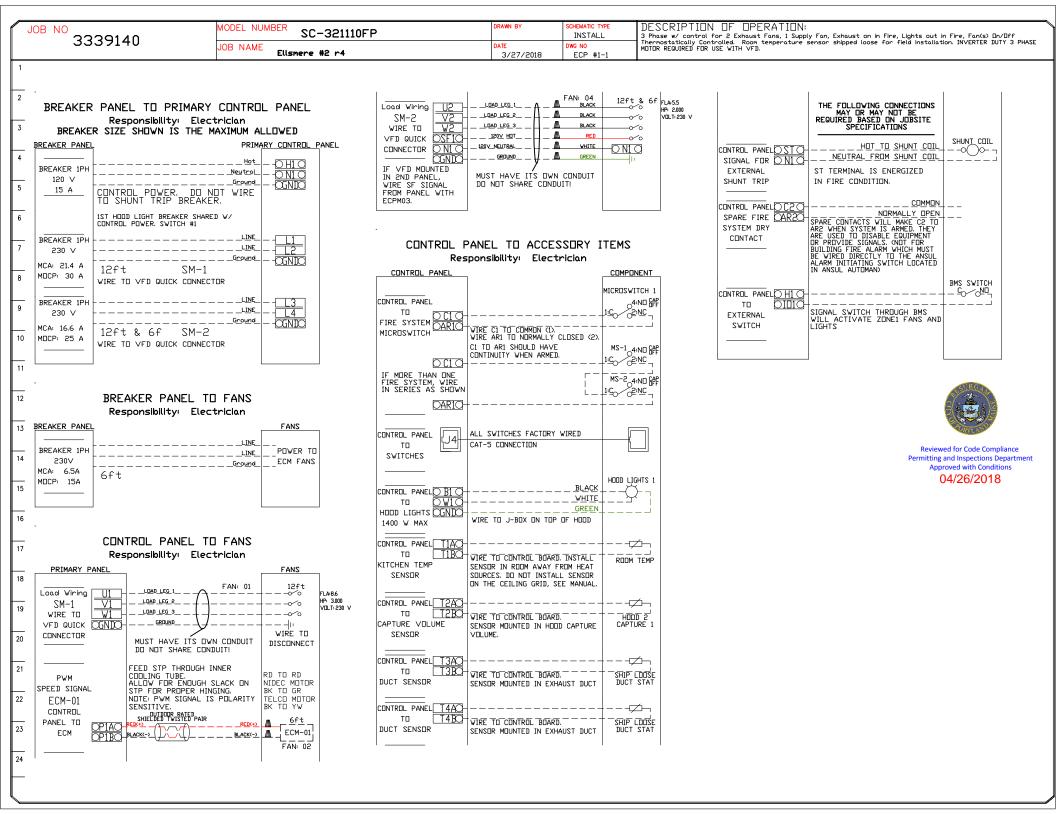


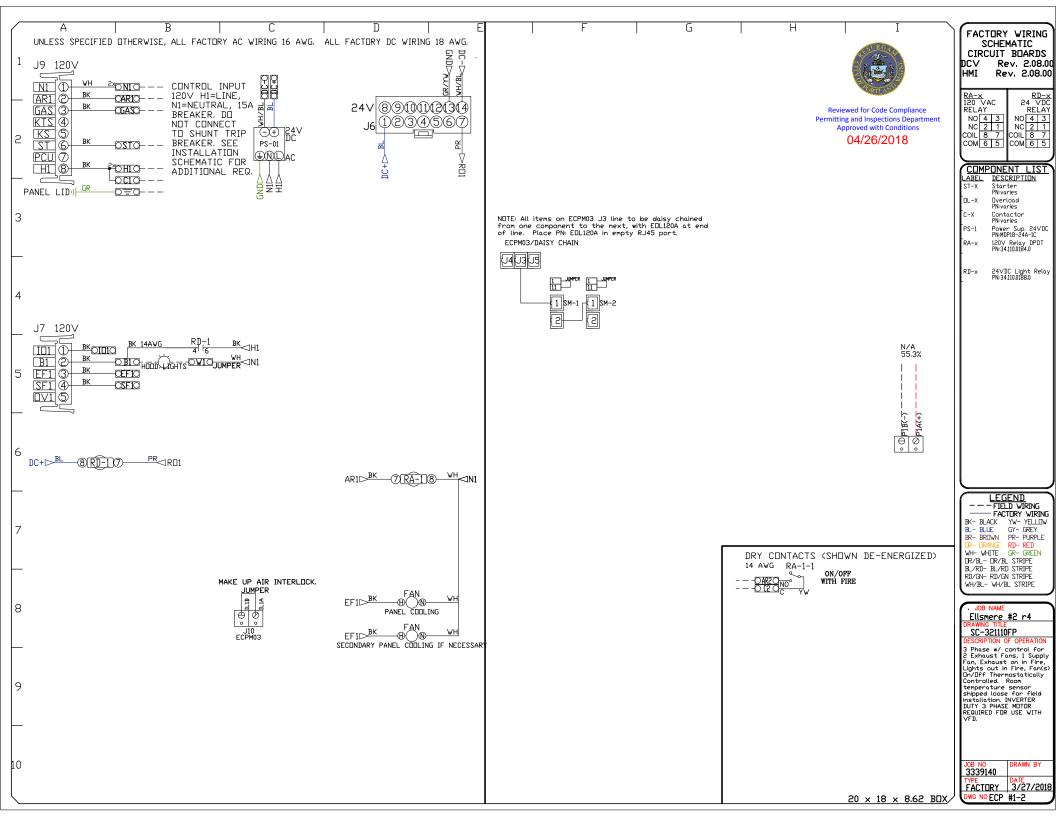

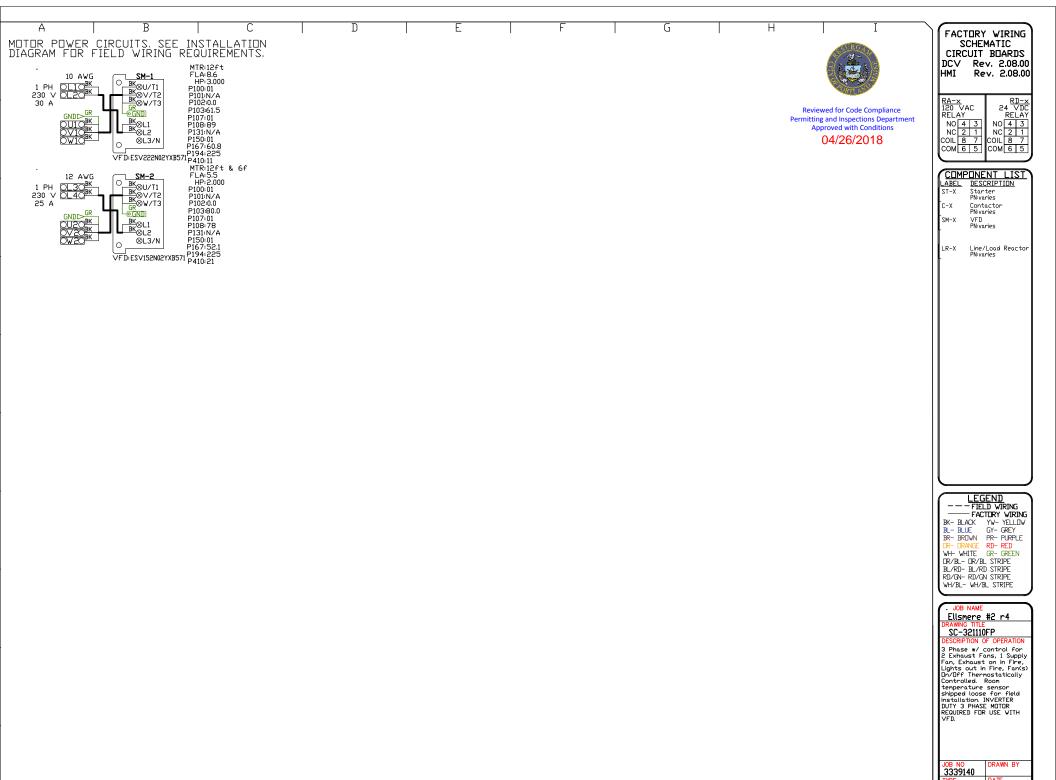20 × 18 × 8.62 BOX

FACTORY 3/27/2018
DWG NO ECP #1-3



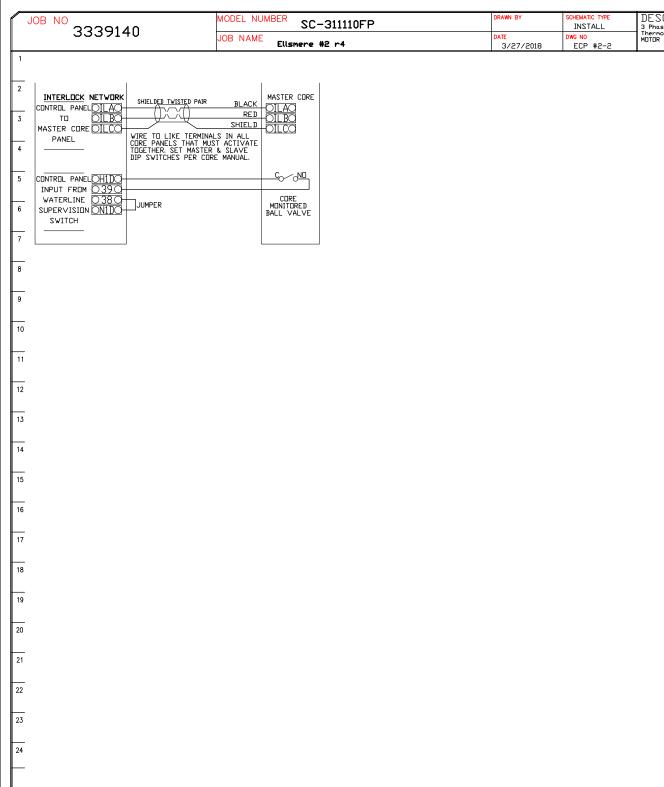

DESCRIPTION OF OPERATION:

3 Phase w/ control for 1 Exhaust Fan, 1 Supply Fan, Exhaust on in Fire, Lights out in Fire, Fan(s) On/Off
Thernostatically Controlled. Room temperature sensor shipped loose for field installation. INVERTER DUTY 3 PHASE
MUTUR REQUIRED FOR USE WITH VFD.



Reviewed for Code Compliance Permitting and Inspections Department Approved with Conditions 04/26/2018

JOB NO 3339140

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MODEL NUMBER SC-311110FP JOB NAME

DATE 3/27/2018

INSTALL DWG NO ECP #2-3 DESCRIPTION OF OPERATION:

Fire System #1 CDRE Protection. 1' CDRE Appliance Manifold Package with Self Cleaning. Installed in Hood Utility Cabinet with integral hood prewire panel.

TOTAL FLOOD PROTECTION ELECTRICAL DETAIL

Ellsmere #2 r4


03/06/2017 Rev. 12

L'ELURICIANI
I. WIRE MAIN CONTROL PANEL PER INCLUDED SCHEMATIC
2. WIRE ALL FANS PER INCLUDED SCHEMATIC
3. WIRE SHUTT TRIP BREAKER (OPTIONAL)
4. WIRE UDS APPLIANCE KILL SWITCH, IF EQUIPPED (OPTIONAL)
5. WIRE GAS VALVE

Reviewed for Code Compliance Permitting and Inspections Department Approved with Conditions 04/26/2018

FS-1: MASTER

ELECTRICAL CONTRACTOR REQUIREMENT					
ITEM	CONNECTION IN PANEL	CONNECTION IN DEVICE	VOLTAGE	AMPERAGE	COMMENTS
SHUNT TRIP BREAKER (OPTIONAL)	ST & N1	BREAKER COIL (A1 & A2)	120 VAC	< 4 AMPS	ST TO ALON SHUNT BREAKER COIL, AND NEUTRAL TO A2 ON SHUNT TRIP BREAKER COIL
CONTROL PANEL POWER	H1 & N1 + GROUND	CIRCUIT BREAKER	120 VAC	15 AMPS	CONTROL PANEL POWER MUST NOT BE RUN THROUGH SHUNT TRIP BREAKER
UDS APPLIANCE KILL SWITCH (OPTIONAL)	KTS & N1	KTS & N1	120 VAC	< 4 AMPS	KILL SWITCH TERMINALS MUST BE IN SERIES WITH OTHER KILL SWITCHES
REMOTE 120VAC ANSUL AUTOMAN (OPTIONAL)	AU1, AU2	SOLENDID	120 VAC	< 6 AMPS	120V TO AU1, AU2 TO ANSUL ELECTRIC AUTOMAN, ANSUL SOLENDID TO NEUTRAL
GAS VALVE	35 & N1D (IF 24 VDC) GAS & N1 (IF 120 VAC)	RED/RED/GREEN	24 VDC DR 120 VAC	< 1.0 AMPS	IF 24 VDC - 2 WIRES & GROUND, N1D TO RED, 35 TO RED, AND GREEN TO GROUND IF 120 VAC - 2 WIRES & GROUND GAS TO RED, N1 TO RED, AND GREEN TO GROUND

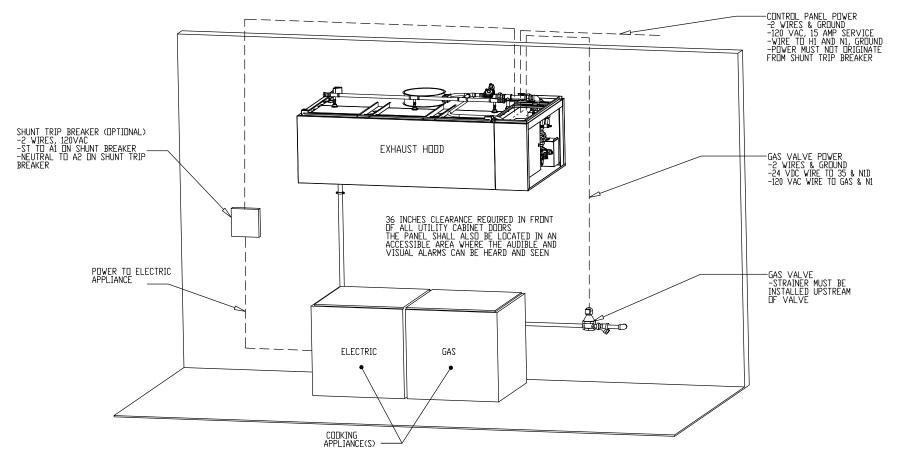

DESCRIPTION OF OPERATION: MODEL NUMBER JOB NO SC-311110FP INSTALL Fire System #1 CORE Protection. 1' CORE Appliance Manifold Package with Self Cleaning. Installed in Hood Utility 3339140 DATE OWG NO JOB NAME Ellsmere #2 r4 ECP #2-4 3/27/2018 TOTAL FLOOD PROTECTION LOW-VOLTAGE DETAIL 03/06/2017 Rev. 12 2 ALARM CONTRACTOR:

1. WIRE MANUAL ACTUATION DEVICE(S), REMOTE FIRESTAT(S), CORE INTERLOCK(S), FIRE SENSOR(S) AND FIRE ALARM CONTACTS

2. COMPLETE FINAL HODKUP OF SYSTEM

3. PERFORM FINAL FIRE SYSTEM TEST

4. FILL SURFACTANT TANK Reviewed for Code Compliance Permitting and Inspections Department FS-1: MASTER 3 04/26/2018 ALARM CONTRACTOR REQUIREMENT CONNECTION IN PANEL CONNECTION ON DEVICE **AMPERAGE** COMMENTS ITEM VOLTAGE 5 WIRE MANUAL ACTUATION DEVICE TERMINAL 1 BETWEEN CORE PANEL TERMINALS 102 AND 103 WIRE MANUAL ACTUATION DEVICE TERMINAL 2 BETWEEN CORE PANEL TERMINALS 101 AND 104 101 AND 104 102 AND 103 MANUAL ACTUATION DEVICE(S) 24 VDC < 1.0 AMPS 1 & 2 JUMPER 101 TO 104 AND 102 TO 103 IF NO MANUAL ACTUATION DEVICE IS INSTALLED 6 MANUAL ACTUATION DEVICE COVER MUST BE INSTALLED IF SURFACE MOUNTED, USE COVER EXTENSION STI-6531E MANUAL ACTUATION DEVICE COVER N/A N/A N/A N/A WIRE FIRE SENSOR WHITE WIRES BETWEEN HOOD CORE PANEL TERMINALS 22 AND 23
WIRE FIRE SENSOR BLACK WIRE BETWEEN HOOD CORE PANEL TERMINALS 22 AND 23
WIRE FIRE SENSOR BLACK WIRE BETWEEN HOOD CORE PANEL TERMINALS 21 AND 24
HIGH TEMP (842°F) #CW04427 (WHT) & #CW04427B (BLK)WIRE OR SIMILAR ONLY IF RAN OVER TOP
OF HOOD; OTHERWISE BELDEN #6320UL OR SIMILAR PLENUM RATED WIRE; SEE FIGURE 1
FIRE ALARM RELAY CONTACTS FOR BUILDING FIRE ALARM LOCATED IN THE
CORE ELECTRICAL CONTROL PANEL 21 AND 24 22 AND 23 REMOTE FIRESTAT SENSOR(S) BLACK AND WHITE 24 VDC < 1.0 AMPS 50V MAX (AC/DC) 8 FIRE ALARM CONTACT AL1, AL2 **VARIES** UP TO 1 AMP CORE SYSTEM (1) ILA, TO CORE SYSTEM (2) ILA. CORE SYSTEM (1) ILB, TO CORE SYSTEM (2) ILB. CORE SYSTEM (1) ILC, TO CORE SYSTEM (2) ILC. USE BELDEN# 88760 OR SIMILAR WIRE RS-485 COMMUNICATIONS CORE INTERLOCK(S) ILA, ILB, ILC ILA, ILB, ILC SIGNAL 9 UP TO 6 WIRE TO TBL & TBC NORMALLY OPEN CONTACT, CLOSES IN TROUBLE CONDITION TROUBLE CONTACT TBC, TBL, TOK VARIES MAX 120 VAC 10 TYPICAL CONNECTION CATS CABLE TO LOCAL AREA NETWORK VIA ETHERNET SWITCH OR WIRELESS ROUTER WITH VALID INTERNET CONNECTION CORE COMMUNICATIONS CABLE RJ-45 Jack INTERNET CONNECTION SIGNAL <1.0 AMPS 11 FIRE ALARM PANEL CORE INTERLOCK FIRE ALARM CONTACT
-2 WIRES WIRED TO NORMALLY
OPEN CONTACTS (CLOSES IN 12 -2 WIRES + SHIELD -USE BELDEN#88760 OR SIMILAR WIRE -SEE FIGURE 3 FIRE CONDITION) -CORE CONTROL PANEL AL1 AND AL2 13 -SEE FIGURE 2 TROUBLE CONTACT

-2 WIRES TO NORMALLY
OPEN CONTACTS (CLOSE
IN TROUBLE CONDITION)

-CORE PANEL TERMINALS
TDI AND TRO 14 CORE_COMMUNICATIONS CABLE -CATS CABLE
-CATS CABLE
MUST BE INSTALLED TO A LOCAL AREA
NETWORK WITH VALID INTERNET ACCESS
VIA ETHERNET SWITCH OR WIRELESS 15 TBL AND TBC -SEE FIGURE 4 ROUTER MANUAL **ACTUATION** DEVICE EXHAUST HOOD 10 TO 20 SUPERVISED LUIP

-4 WIRES, 24VDC CONNECT BLACK
WIRES BETWEEN 21 AND 24 IN PANEL,
CONNECT WHITE (OR RED) WIRES
BETWEEN 22 AND 23 IN PANEL
-ADDITIONAL FIRESTATS, WIRED IN
SUPERVISED LOOP 17 FEET FROM -> HOOD LOCATED NEAR POINT -MANUAL ACTUATION DEVICE WIRES

-4 WIRES, 24VDC WIRE (TERMINAL 1)
BETWEEN 102 AND 103

-WIRE (TERMINAL 2) BETWEEN 101 AND 104

-ADDITIONAL PULL STATIONS WIRED IN
SUPERVISED LOOP OF EGRESS FROM HOOD -USE HIGH TEMP (842°F) #CW04427 -USE FIGHT (BM2F) BLK)VIRE ONLY
IF RAN DVER TOP OF HODD;
OTHERWISE BELDEN #6320UL OR
SIMILAR PLENUM RATED WIRE
-SEE FIGURE 1 19 -USE BELDEN #6320UL OR SIMILAR WIRE -SEE FIGURE 2 20 42 TO 48 INCHES ABOVE FLOOR -MANUAL ACTUATION DEVICE PART #STI-SS2431 21 36 INCHES CLEARANCE REQUIRED IN FRONT OF ALL UTILITY CABINET DITIES. ⊐D LEVEL TO OF ALL UTILITY CABINET DOORS
THE PANEL SHALL ALSO BE LOCATED IN AN ACCESSIBLE AREA WHERE THE AUDIBLE AND CENTER OF PUSH ELECTRIC PROTECTIVE COVER MUST BE INSTALLED GAS NOITAT2 22 VISUAL ALARMS CAN BE HEARD AND SEEN 23 APPLIANCE(S) 24 ATTENTION: LOW-VOLTAGE DC OR SIGNALING WIRE SHOULD BE ROUTED IN SEPARATE CONDUIT FROM ALL AC SOURCES NOTE: SEE INSTALLATION, OPERATION, AND MAINTENANCE MANUAL FOR FURTHER INSTRUCTIONS

MODEL NUMBER DESCRIPTION OF OPERATION:

Fire System #1 CDRE Protection. 1' CDRE Appliance Manifold Package with Self Cleaning. Installed in Hood Utility JOB NO SC-311110FP INSTALL 3339140 DATE DWG NO JOB NAME Ellsmere #2 r4 ECP #2-5 3/27/2018 02/05/2015 Rev. 16 TOTAL FLOOD PROTECTION LOW-VOLTAGE FIGURES FS-1: MASTER **Reviewed for Code Compliance** Permitting and Inspections Department Approved with Conditions 04/26/2018 USE BELDEN #6320UL OR SIMILAR WIRE J2-1 Ø 21 Ø J10-1 0 101 0 MICROSWITCH/ MANUAL ACTUATION DEVICE J2-2 0 22 01-J10-2 1020 FIRE STAT-1 CORE CONTROL PANEL FIRE ALARM CONTACT ND-WH (OR RD) BUILDING BREAK WIRE BEFORE INSERTING BK-C FIRE ALARM BREAK WIRE 1 2 MANUAL BEFORE INSERTING INTO TERMINALS ACTUATION DEVICE INTO TERMINALS FIRE STAT-2 MD-WH (DR RD) ND-WH (DR RD) BK-C AL2 S END OF LINE PAL1 DEVICE 1 2 ALARM INPUT PAL1 J2-3 <u>Ø 23 </u>Ø J10-3 <u>⊘103</u> ⊘ J2-4 Ø 24 O J10-4 104 0 WIRING CONNECTIONS FOR FIRE ALARM CONTACT FIGURE 2 WIRING CONNECTIONS FOR FIRESTAT LOOP FIGURE 1 WIRING CONNECTIONS FOR MANUAL ACTUATION LOOP FIGURE 1A BUILDING FIRE ALARM CORE CONTROL PRV SUPERVISION WATERLINE SUPERVISION CORE WATER SHUT-OFF SWITCH PANEL SHIELDED TWISTED PAIR TROUBLE CONTACT SWITCH SWITCH ØILAO BK +BK Ø ILA⊗ RD OILBO O TBL NO TOK A O NC ØILBO RD 95 END OF LINE DEVICE TROUBLE INPUT фтвс. ØILCO ØILCO WIRING CONNECTIONS FOR CORE INTERLOCK FIGURE 3 WIRING CONNECTIONS FOR TROUBLE CONTACT FIGURE 4

ATTENTION: LOW-VOLTAGE DC OR SIGNALING WIRE SHOULD BE ROUTED IN SEPARATE CONDUIT FROM ALL AC SOURCES

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DESCRIPTION OF OPERATION: MODEL NUMBER JOB NO SC-311110FP INSTALL 3339140 Cabinet with integral hood prewire panel. DATE DWG NO JOB NAME Ellsmere #2 r4 ECP #2-6 3/27/2018 PROTECTION PLUMBING DETAIL 2 PLUMBER:

1. CONNECT HOT WATER LINE; PVC, COPPER OR STAINLESS STEEL PIPE ONLY

2. CONNECT HODD DRAIN'S) STAINLESS STEEL, COPPER, OR STEEL PIPE ONLY

2. CONNECT HODD DRAIN'S) STAINLESS STEEL, COPPER, OR STEEL PIPE ONLY

3. CONNECT HODD DRAIN'S) STAINLESS STEEL, COPPER, OR STEEL PIPE ONLY

4. CONNECT HODD DRAIN HODD STAINLESS STEEL, COPPER, OR STEEL PIPE ONLY

4. PLUMB GAS VALVE, STRAINER MUST BE INSTALLED UPSTREAM OF VALVE

5. INSTALL FLOOR DRAIN

6. INSTALL BACKFLOW PREVENTER IF CODE REQUIRES 3 DI LIMBING CUNITDACTUD DECLIIDEMENT 5 6 8 9 HOT WATER LINE


-PVC, COPPER, OR STAINLESS STEEL PIPE ONLY
-140-170°F OPERATING TEMPERATURE
-30 PSI TO 70 PSI OPERATING PRESSURE
-125 PSI MAX STATIC PRESSURE
-6.30 GPM (0.7 GPM PER FOOT OF HODD) -PRESSURE REGULATOR VALVE REGULATORS ARE NOT INCLUDED TO MEET REQUIRED PRESSURE AND MUST BE ORDERED SEPARATELY PART NUMBERS: X65BU(3/4*), X65BU(1*), OR X65BU(1-1/2*) CONSULT FACTORY FOR SIZING 10 11 -1 INCH NPT INCH NPT FITTING INSULATED 1' MANIFOLD MINIMUM OPERATING PRESSURE REQUIREMENTS 12

Fire System #1 CORE Protection. 1' CORE Appliance Manifold Package with Self Cleaning. Installed in Hood Utility

03/06/2017 Rev

Permitting and Inspections Department

				PLUMBING CUNIKACIUM	K REQUIREMENT
ITEM	CONNECTION	TEMPERATURE	PRESSURE	FLOW RATE	COMMENTS
HOT WATER LINE	1 INCH NPT	140 to 170°F	30 PSI TD 70	PSI 6.30 GPM	INSULATE HOT WATER PIPE, MINIMUM PRESSURE DEPENDENT ON LENGTH AND CONFIGURATION OF HOOD SYSTEM
HOOD DRAIN(S)	1-1/2 INCH NPT	N/A	GRAVITY DRAIN	SEE ABOVE	2 DRAINS ON 24 INCH TALL HOODS WITH 20 INCH TALL FILTERS AND HOODS 10 FEET AND LONGER
END-TO-END CORE CONNECTION	VARIES	N/A	N/A	N/A	CONNECT WITH NPT PIPE, SEAL ALL THREADS, HOOD CONNECTION PROVIDED
BACK-TO-BACK CORE CONNECTION	VARIES	N/A	N/A	N/A	CONNECT WITH NPT PIPE, SEAL ALL THREADS, HODD CONNECTION PROVIDED
GAS VALVE	VARIES	N/A	SEE TABLE	N/A	UP TO 2 INCHES NPT WITH 24V CONTROLS, 2-1/2 AND 3 INCH USE 120V CONTROL
FLOOR DRAIN(S)	1-1/2 INCH	N/A	GRAVITY DRAIN	N/A	USED TO HELP CLEAN UP FIRE SYSTEM DISCHARGE, GREASE INTERCEPTOR MAY BE REQUIRED
BACKFLOW PREVENTER DRAIN LINE (OPTIONAL)	INLET/OUTLET DRAIN	N/A	VARIES	N/A	INSTALLED WHEN PACKAGE HAS A BACKFLOW PREVENTER VALVE, SEE BACKFLOW PREVENTER VALVE MANUAL FOR DETAILS

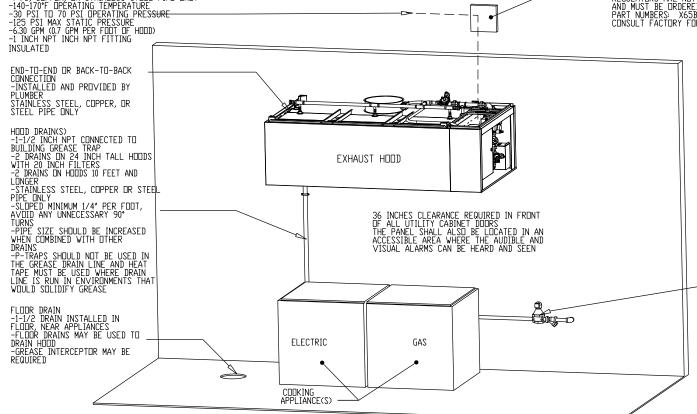

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NOTE: SEE INSTALLATION, OPERATION, AND MAINTENANCE MANUAL FOR FURTHER INSTRUCTIONS

LENGTH OF HOOD (FT)	MINIMUM INLET WATER PRESSURE FOR HOT WATER (PSI)	DISCHARGE COEFFICIENTS (K-FACTOR)
4	30	0.6
8	30	1.3
12	30	1.9
16	30	2.5
20	30	3.1
24	30	3.8
28	31	4.3
32	33	4.8
36	35	5.3
40	42	5.4
44	43	5.9
48	45	6.3

TOTAL FLOWRATE = K FACTOR x PRESSURE 0.44

-THREADED NPT CONNECTION -SEE TABLE BELOW FOR MAX PRESSURE -STRAINER INSTALLED UPSTREAM OF VALVE

SIZE	MAX INLET PRESSURE (PSI)	VOLTAGE	BTU/HR
3/4"		24VDC	593,200
1"		24VDC	1,132,300
1-1/4"		24VDC	1,925,000
1-1/2"	5	24VDC	2,406,000
2"		24VDC	2,940,500
2-1/2"		120VAC	5,607,800
3"		120VAC	5,661,700

JOB NO 3339140

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MODEL NUMBER SC-311110FP JOB NAME

Ellsmere #2 r4

INSTALL DATE DWG NO 3/27/2018 ECP #2-7

DESCRIPTION OF OPERATION:
Fire System #1 CDRE Protection. 1' CDRE Appliance Manifold Package with Self Cleaning. Installed Cabinet with integral hood prewire panel.

FS-1: MASTE RApproved with Conditions

03/06/2017 Rev **Reviewed for Code Compliance**

Permitting and Inspections Department

04/26/2018

TOTAL FLOOD PROTECTION SPRINKLER DETAIL

BUILDING SPRINKLER CONTRACTOR:
1. CONNECT CORE WATER LINE TO BUILDING WET SPRINKLER SYSTEM. STAINLESS STEEL, COPPER, OR STEEL PIPE ONLY

SPRINKLER CONTRACTOR REQUIREMENT ITEM CONNECTION **OPERATING PRESSURE** K-FACTOR FLOW RATE COMMENTS WATER LINE MUST BE SUPERVISED AND HAVE NO UNSUPERVISED MANUAL SHUT-OFF CORE WATER SUPPLY LINE 1 INCH NPT 30 PSI TO 70 PSI 3.0 13.50 GPM VALVES MINIMUM PRESSURE AND FLOWRATE DEPENDENT ON LENGTH OF HOOD SYSTEM

PRESSURE REGULATOR VALVE (PRV) -PRV NOT INCLUDED AND MUST BE PROVIDED, INSTALLED, AND ADJUSTED BY THE SPRINKLER CONTRACTOR TO MEET INCOMING PRESSURE REQUIREMENTS -A REGULATOR SUCH AS THE ELKHART BRASS MODEL NUMBER URFA-20S-2.5' OR THE UR-20 SERIES PARTS KITS SHOULD BE UTILIZED -MUST BE CONFIRMED WITH THE FIRE MARSHAL OR LOCAL AUTHORITY HAVING JURISDICTION (AHJ)
CORE WATER SUPPLY LINE 39 PSI, TIO 70 PSI DEPARTING PRESSURE, 125 PSI, MAX STATIC PRESSURE, 11 INCH NP IN PT FITTING. 1350 PPM 415 GPM PER TOUT OF HOUD SIEW WITH NO UNSUPERVISED MANUAL SHIPLOFF VALVES CONNECT TO BUILDING FIEW SERVINER WATER LINE ORDURED STAINLESS STEEL, COPPER, OR STEEL PIPE DNLY 36 INCHES CLEARANCE REQUIRED IN FRONT OFF ALL UTILITY CABINET DOORS THE ARRANGE STEEL, COPPER, OR STEEL PIPE DNLY 36 INCHES CLEARANCE REQUIRED IN FRONT OFF ALL UTILITY CABINET DOORS THE ARRANGE SHALL HASD BE LIDCATED IN AN ACCESSIBLE AREA WHERE THE AUDIBLE AND VISUAL ALARMS CAN BE HEARD AND SEEN ELECTRIC GAS CODKING APPLIANCE(S)


1" MANIFOLD MINIMUM OPERATING PRESSURE REQUIREMENTS				
LENGTH OF HOOD (FT)	MINIMUM INLET WATER PRESSURE FOR HOT WATER (PSI)	MINIMUM INLET WATER PRESSURE FOR CORE PROTECTION (PSI)	DISCHARGE COEFFICIENTS (K-FACTOR)	
4	30	30	1.3	
8	30	30	2.7	
12	30	30	4.0	
16	30	30	5.4	
20	30	30	6.7	
24	30	30	8.1	
28	31	33	9.0	
32	33	35	10.0	
36	35	45	10.1	
40	42	50	10.7	
44	43	55	11.3	
48	45	60	11.9	


TOTAL FLOWRATE = K FACTOR × PRESSURE

NOZZLE HEIGHTS ABOVE HAZARD NOZZLE ABOVE HAZARD NOZZLE PART NUMBER MIN MAX 3070-3/8H-SS10 30" 55"

NOZZLES FOR CORE PROTECTION DESCRIPTION PART NUMBER MACOLA FLOW RATE 2.6 GPM @ 30 PSI 1/4TT+TP1530+CP1325 A0002784 RISER NOZZLE 0.7 GPM @ 30 PSI SPRAY BAR NOZZLE 1/4TT+TG-4.3W A0025166

NOTE: SEE INSTALLATION, OPERATION, AND MAINTENANCE MANUAL FOR FURTHER INSTRUCTIONS

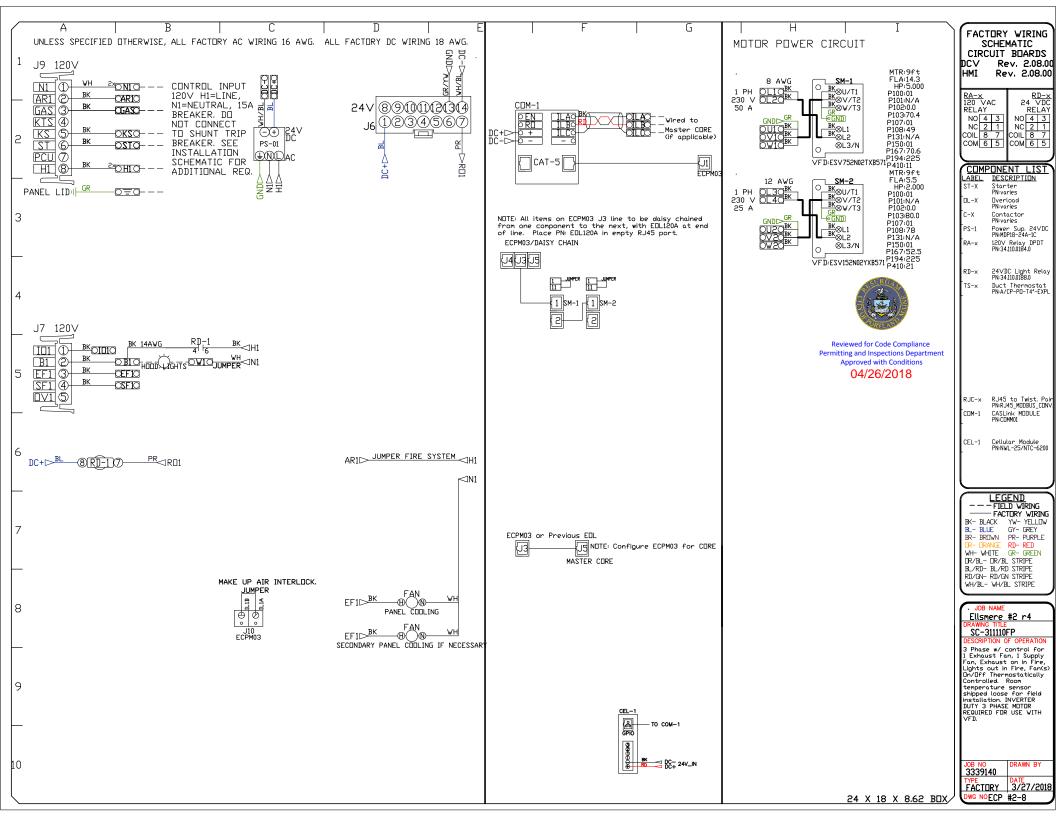

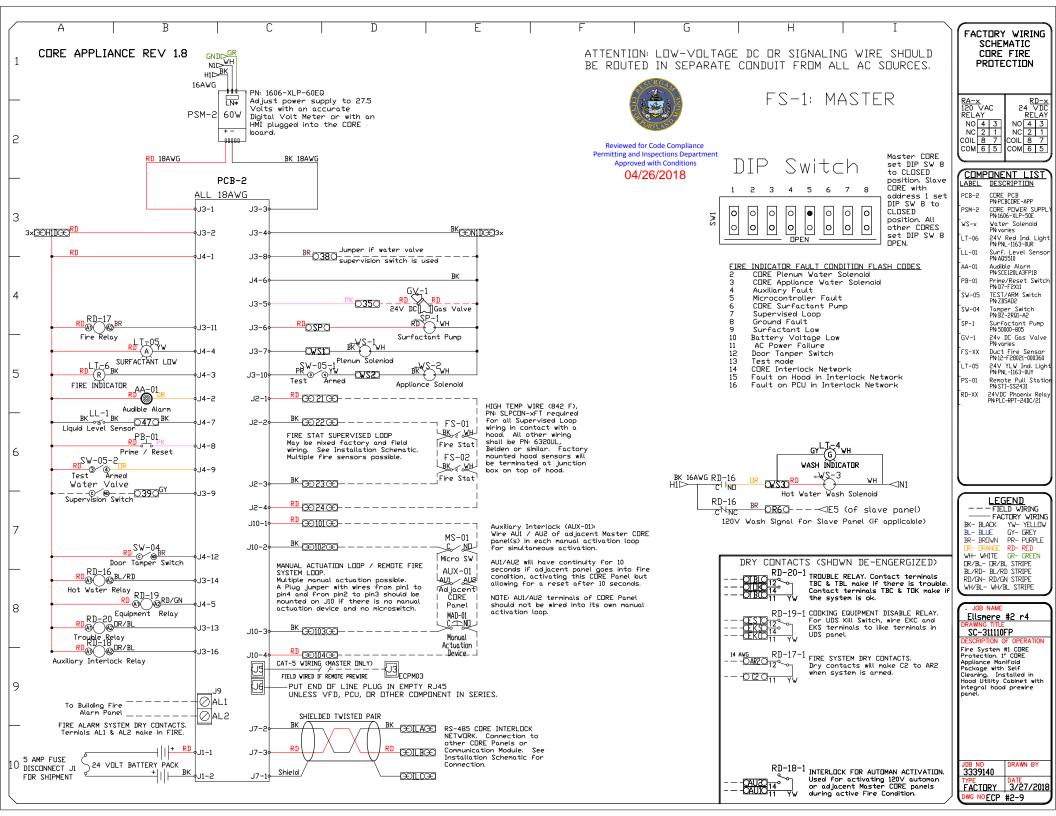

System Design Verification (SDV)

If ordered, CAS Service will perform a System Design Verification (SDV) once all equipment has had a complete start up per the Operation and Installation Manual. Typically, the SDV will be performed after all inspections are complete.

Any field related discrepancies that are discovered during the SDV will be brought to the attention of the general contractor and corresponding trades on site. These issues will be documented and forwarded to the appropriate sales office. If CAS Service has to resolve a discrepancy that is a field issue, the general contractor will be notified and billed for the work. Should a return trip be required due to any field related discrepancy that cannot be resolved during the SDV, there will be additional trip charges.

During the SDV, CAS Service will address any discrepancy that is the fault of the manufacturer. Should a return trip be required, the general contractor and appropriate sales office will be notified. There will be no additional charges for manufacturer discrepancies.

CUSTOMER APPROVAL T	□ MANUFACTURE:
Approved as Noted	
Approved with N□ Exception Taken	
Revise and Resubmit	
SIGNATURE	
Your Title	Date







<i>JOB</i> Ellsmere #2 r4		
LOCATION PORTLAND, M	E, 04103	
<i>DATE</i> 3/27/2018	JOB #	3339140
<i>DWG</i> # 39	DRAWN	<i>BY</i> BFC-21
REV.	SCALE	3/8" = 1'-0"