



2ND & 3RD FLOOR DECK FRAMING PLAN
Scale: 3/8" = 1'-0"

Scale: 3/8" = 1'-0"

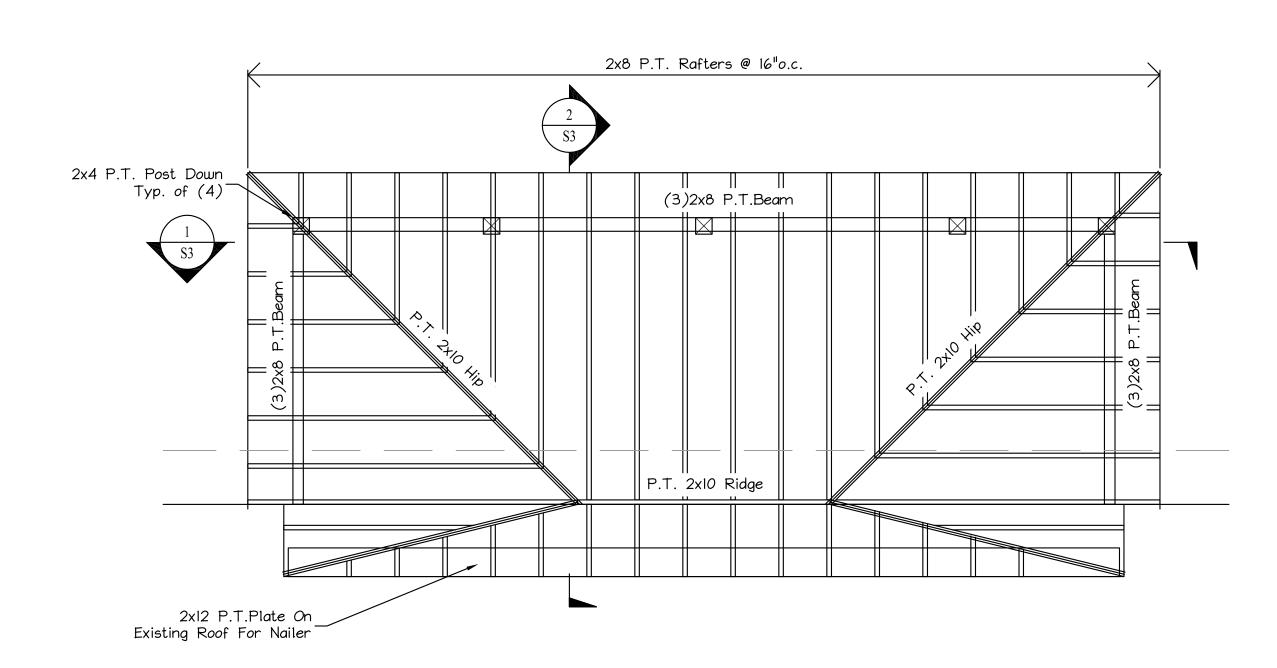

STAIR ROOF FRAMING PLAN
Scale: 3/8" = 1'-0"

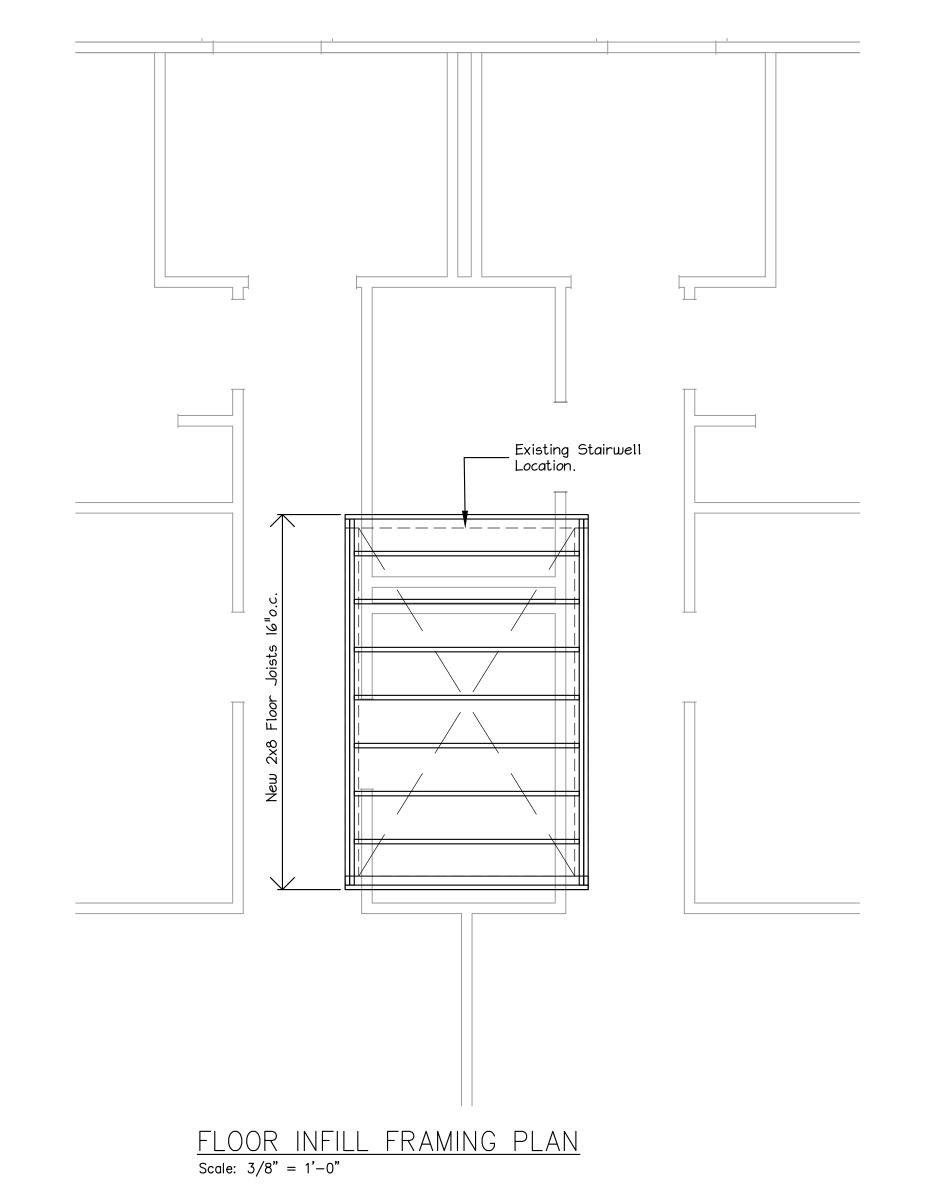

WOOD FRAMING NOTES:

I. STRUCTURAL LUMBER: SPRUCE PINE FIR NOI/NO2 OR BETTER Fb = 875 PSIFv = 125 PSIE = 1400000 PSIFc = 1150 PSI

> MANUFACTURED LUMBER: BOISE CASCADE VERSA-LAM 2.0 3100

Fv = 285 PSI Fb = 3100 PSIFc = 3000 PSIE = 2000000 PSI

2. DESIGN CODE: IBC 2009 / NATIONAL DESIGN SPECIFICATIONS FOR WOOD CONSTRUCTION BY THE NATIONAL FOREST PRODUCTS ASSOCIATION.

SEE CODE FOR NAILING AND SPACING REQUIREMENTS. 4. SPIKE TOGETHER ALL FRAMING MEMBERS WHICH ARE BUILT-UP

3. NAILING REQUIREMENTS FOR PLYWOOD SHEATHING:

USING MULTIPLE 2x LUMBER. 5. PROVIDE GALVANIZED METAL TIES EQUAL TO SIMPSON H2.5 HURRICANE TIES BETWEEN ROOF RAFTERS OR TRUSSES AND SUPPORTING WALL MEMBERS, UNLESS SHOWN OTHERWISE.


PROVIDE GALVANIZED METAL CONNECTORS EQUAL TO SIMPSON TC26 TRUSS CONNECTOR BETWEEN ALL ROOF SCISSOR TRUSSES AND SUPPORTING WALL MEMBERS, UNLESS SHOWN OTHERWISE.

6. PROVIDE PRESSURE TREATED LUMBER FOR ALL LUMBER IN CONTACT WITH MASONRY OR CONCRETE.

7. ROOF SHEATHING: 5/8" APA RATED SHEATHING, EXTERIOR OR STRUCTURAL I OR II RATED SHEATHING, SPAN RATING 32/16 (TRUSSES), 24/12 (JOISTS). INSTALL SHEETS WITH FACE GRAIN DIRECTION PERPENDICULAR TO SUPPORTING MEMBERS.

8. I-JOISTS ARE DESIGNED BASED ON NORDIC JOISTS. FOLLOW MANUFACTURERS INSTRUCTIONS FOR INSTALLATION.

9. ALL NAILS, SPIKES, BOLTS ETC. FASTENING MEMBERS TO PRESSURE TREATED LUMBER SHALL BE EITHER STAINLESS STEEL OR HEAVY GALVANIZED.

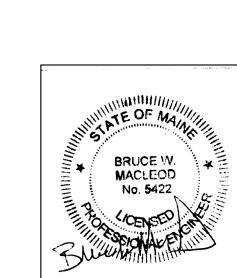

MacLeod Structural Engineers, PA 90 Bridge Street Ste252 Westbrook, Maine 04038 207.839.0980 732 Forest Ave. Portland, Maine

Floor & Roof Framing Plans

DRAWN BY: BWM DRAWING NUMBER:

PROJ NO: 2017-031 S-2.0 SCALE: as noted PROJ NO: 2017-031