



DOOR SCHEDULE

DOOR NO.	SIZE	LABEL	LOCATION	TYPE	ELEV	REMARKS
001	3'-0" x 6'-8"	---	BASEMENT	EXT./INSULATED	1	
101	3'-0" x 6'-8"	---	ENTRY	EXT./INSULATED	1	
201	3'-0" x 6'-8"	---	ENTRY	EXT./INSULATED	1	
301	3'-0" x 6'-8"	---	ENTRY	EXT./INSULATED	1	
102	3'-0" x 6'-8"	---	ENTRY UNIT	INT./SOLID CORE	2	IHR. RATED
103	2'-6" x 6'-8"	---	BATH	INT./HOLLOW CORE	3	
104	2'-6" x 6'-8"	---	BEDROOM 2	INT./HOLLOW CORE	3	
105	2'-0" x 6'-8"	---	CLOSET	INT./HOLLOW CORE	3	
106	2'-6" x 6'-8"	---	BEDROOM 1	INT./HOLLOW CORE	3	
107	5'-0" x 6'-8"	---	CLOSET	INT./HOLLOW CORE	4	SLIDING
108	3'-0" x 6'-8"	---	ENTRY UNIT	EXT./INSULATED	1	


NOTE: DOORS 102-108 ARE TYPICAL FOR EACH UNIT, EACH FLOOR

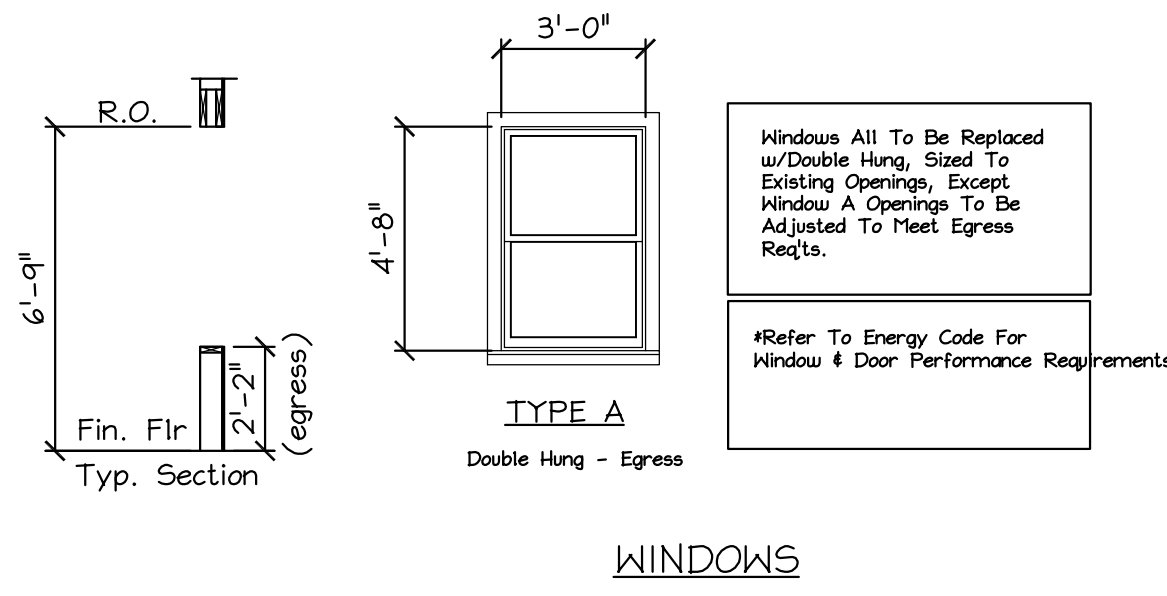


WINDOWS

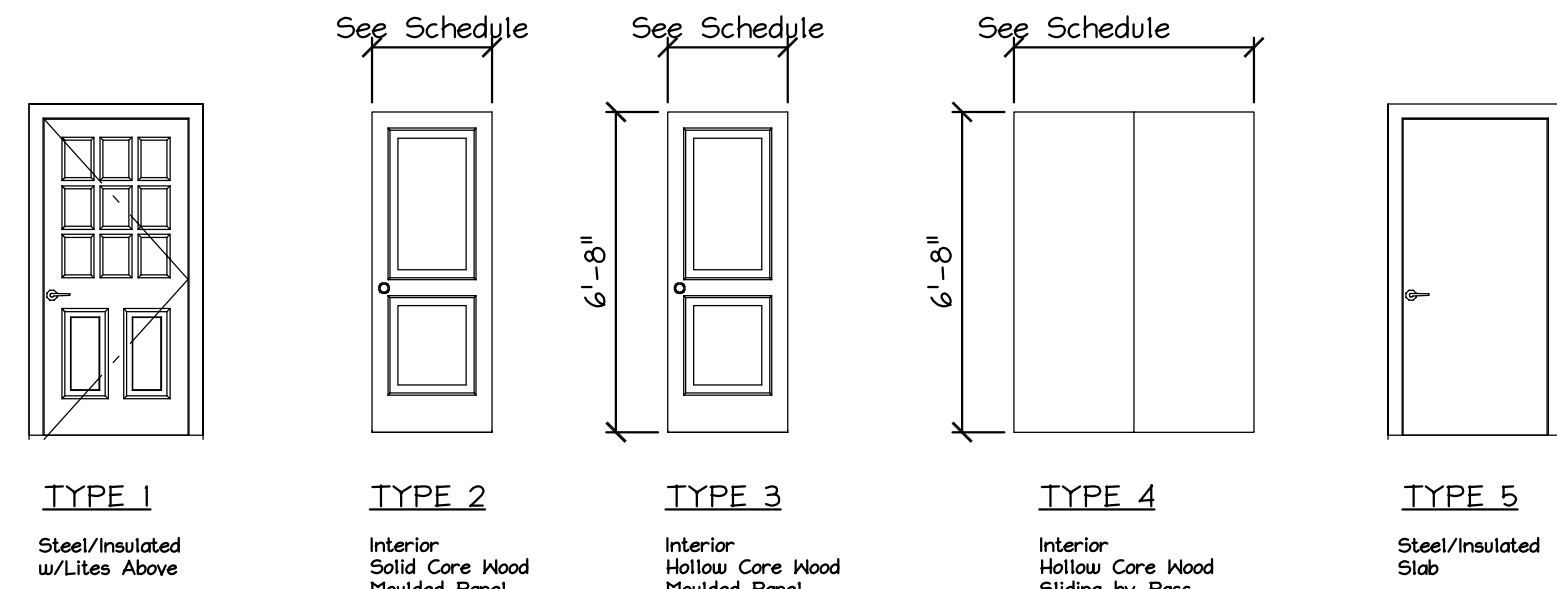


DOOR TYPES

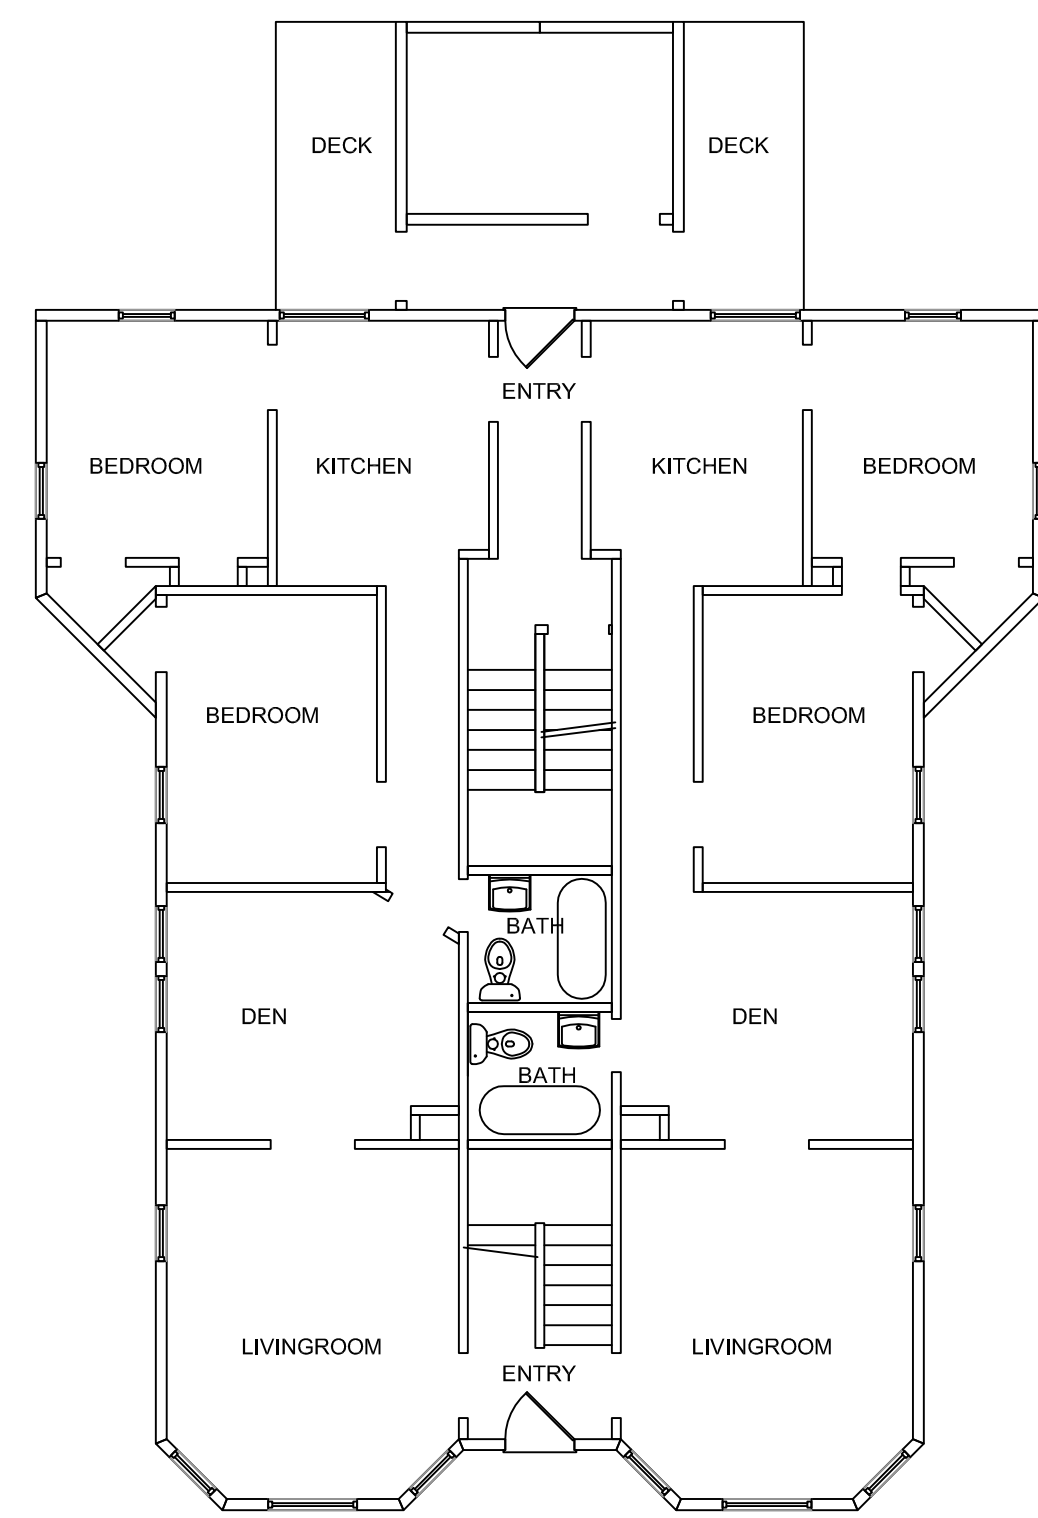

FIRST FLOOR
Scale: 1/8" = 1'-0"

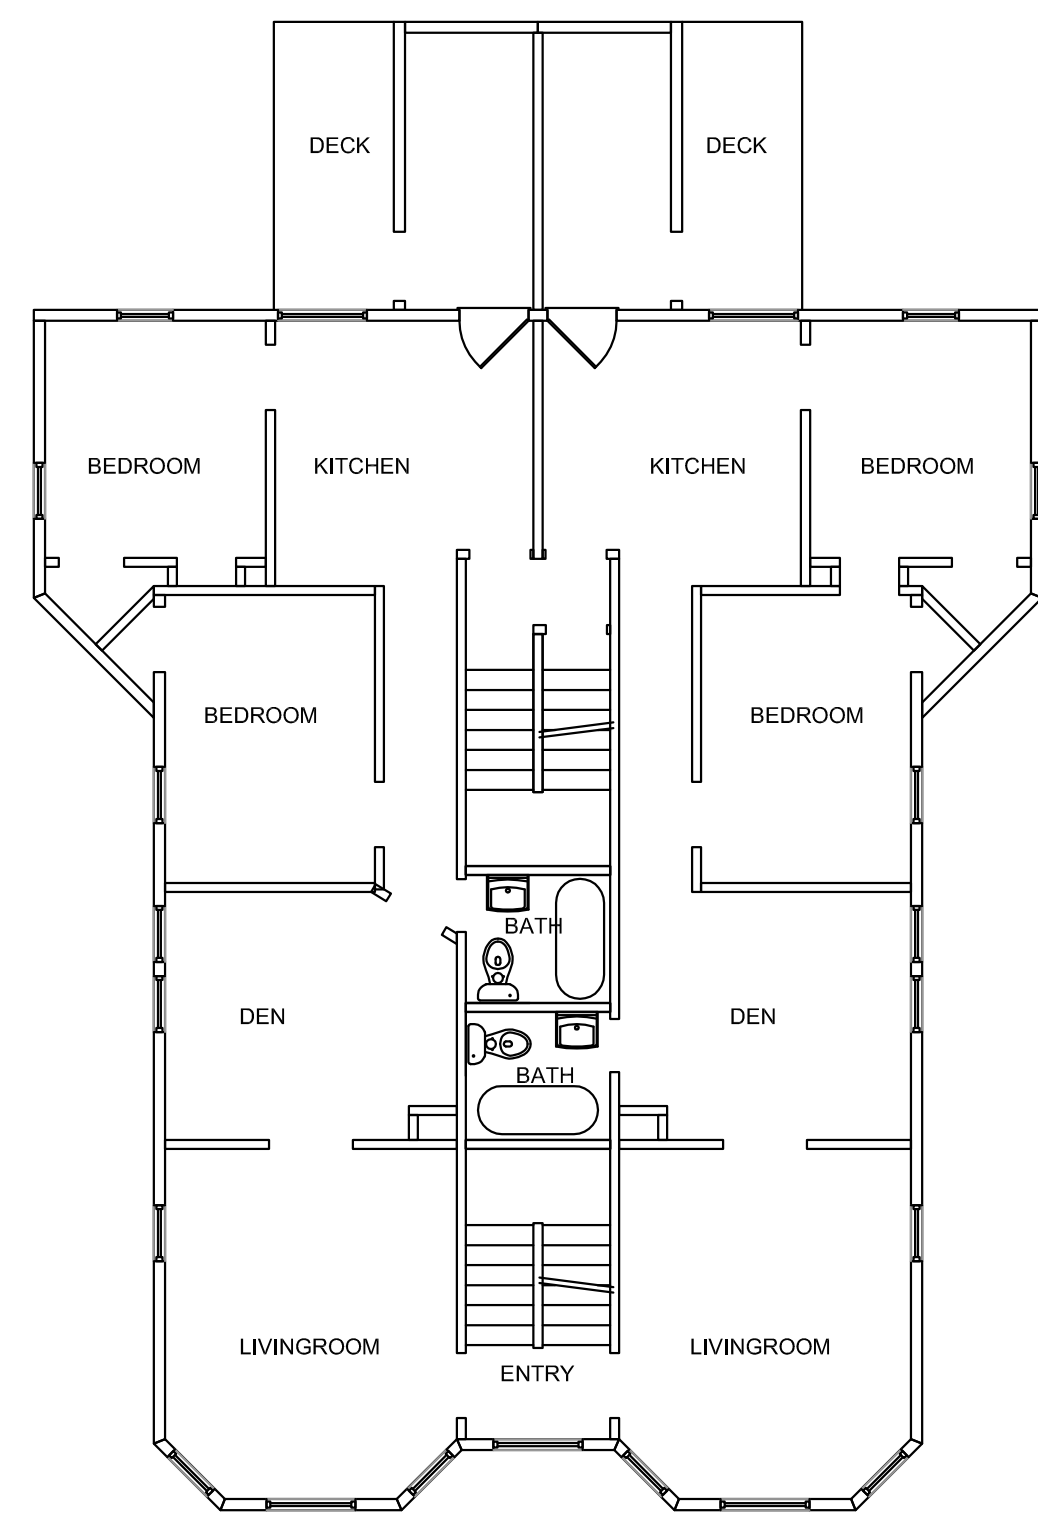


SECOND FLOOR
Scale: 1/8" = 1'-0"

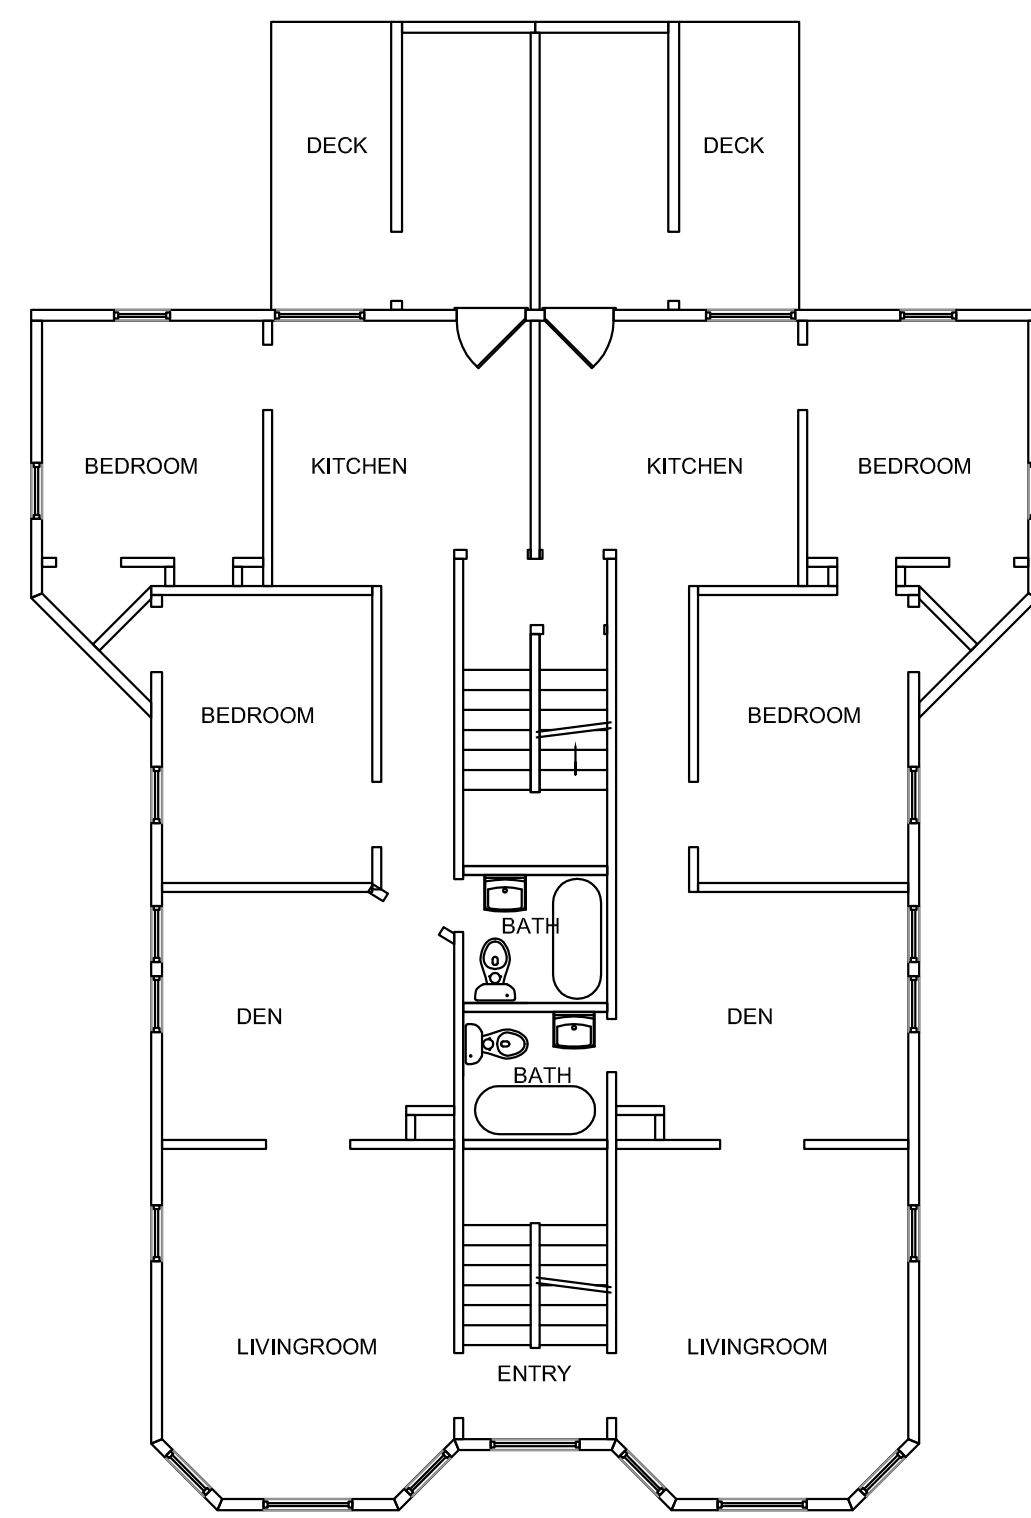

THIRD FLOOR
Scale: 1/8" = 1'-0"

EXISTING FLOOR PLANS
Scale: 1/4" = 1'-0"

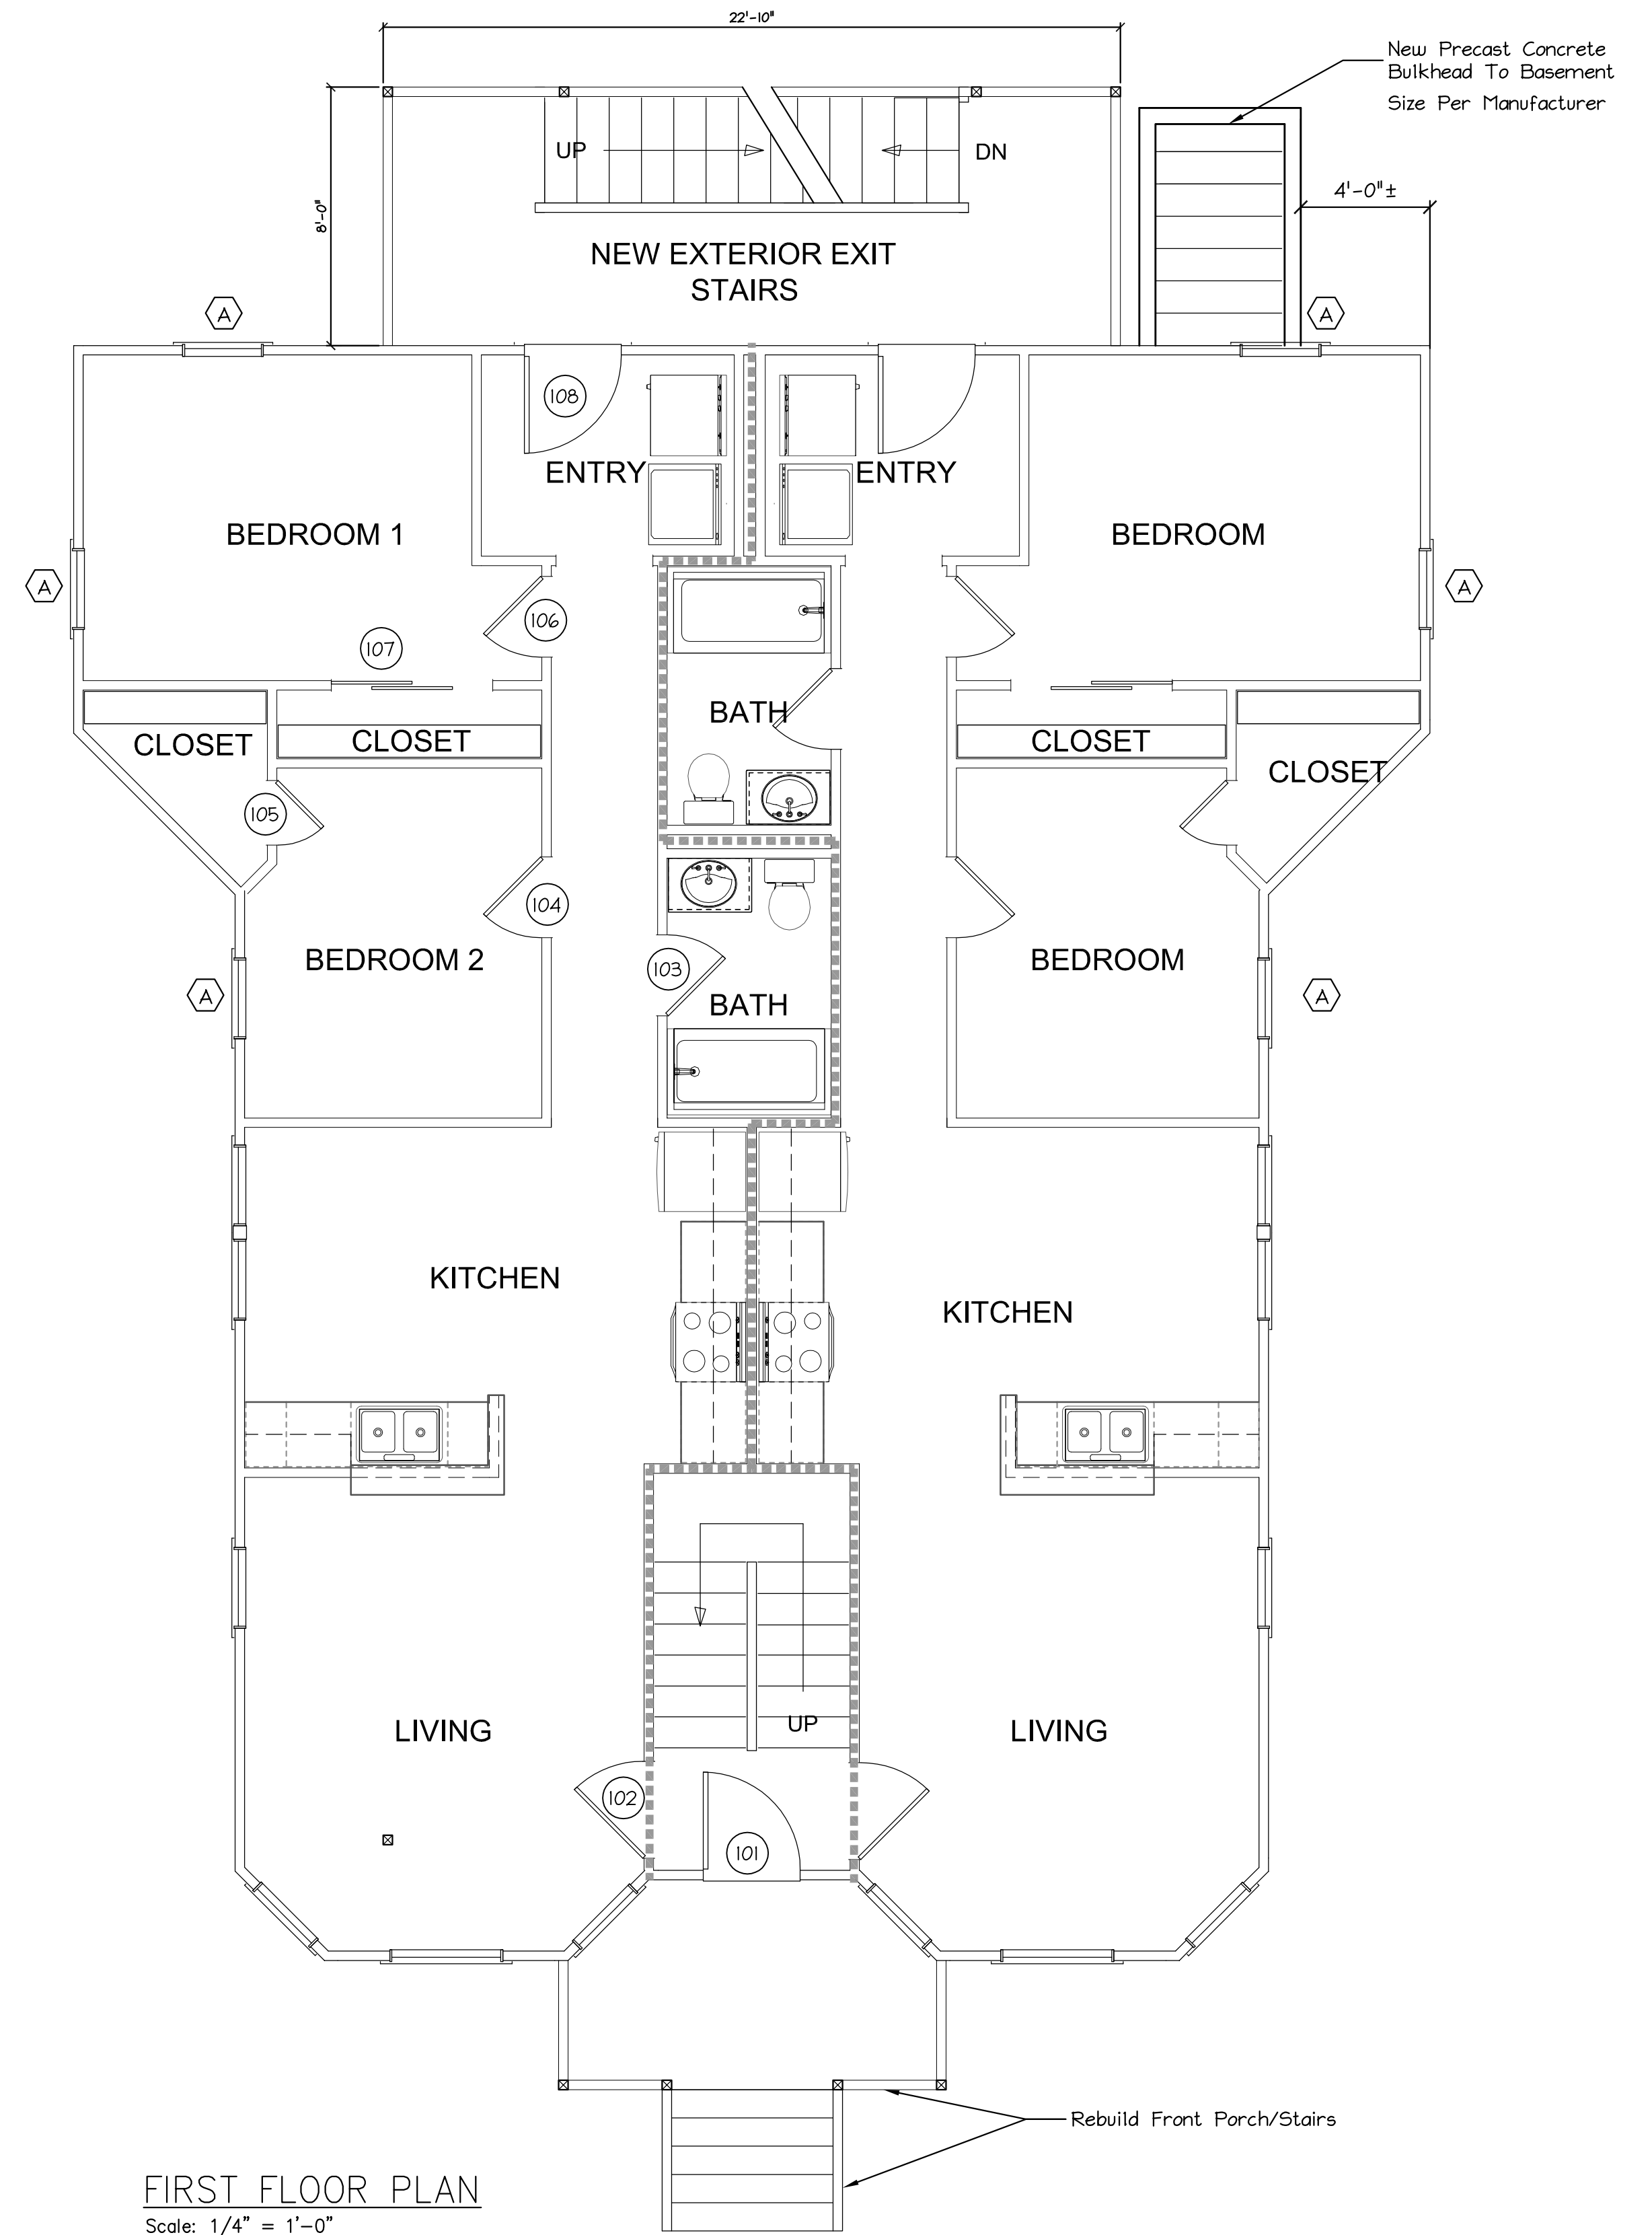

FIRST FLOOR PLAN
Scale: 1/4" = 1'-0"

MacLeod Structural Engineers, PA		
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732 Forest Ave.		
Portland, Maine		
TITLE: First Floor Plan		
DATE: 4/25/17	DRAWN BY: BIM	DRAWING NUMBER: A-1.0
SCALE: as noted	PROJ NO: 2017-031	