OCCUPANT LOAD	193 PEOPLE
USE GROUP CLASSIFICATION	MERCANTILE/ BUSINESS (LOUNGE)
TYPE OF CONSTRUCTION	5B - UNPROTECTED
TOTAL AREA OF WORK: PROPOSED	13,187 SF
ACTUAL BUILDING AREA: EXISTING	12,884 SF
ACTUAL BUILDING HEIGHT	(1) STORIES
BUILDING AREA LIMITATION - SQ. FT. (TABLE 503)	9,000 SF PER FLOOR
BUILDING HEIGHT LIMITATION - STORIES (TABLE 503)	(1) STORIES
STREET FRONTAGE INCREASE (150%) - SQ. FT.	N/A
AUTOMATIC SPRINKLER SYSTEM AREA INCREASE (300%) - SQ. FT.	36,000 SF ALLOWABLE AREA
AUTOMATIC SPRINKLER SYSTEM HEIGHT INCREASE	(1) STORY, 2 STORIES ALLOWABLE
FIRE SUPPRESSION:	YES-PER NFPA 13
EXIT ACCESS FIRE RATINGS:	
FIRE WALLS:	
PARTY WALLS	N/A (SAME TENANT)
STAIR ENCLOSURES	NONE
SHAFTS	NONE
EXIT ACCESS CORRIDORS	0 HOUR
FIRE PROTECTION OF STRUCTURE:	
PRIMARY STRUCTURAL FRAME	0 HOUR
LOAD BEARING WALLS - EXTERIOR	0 HOUR
LOAD BEARING WALLS - INTERIOR	0 HOUR
NON-LOAD BEARING WALLS - EXTERIOR	0 HOUR
NON-LOAD BEARING WALLS - INTERIOR	0 HOUR
FLOOR CONSTRUCTION	0 HOUR
ROOF CONSTRUCTION	0 HOUR
OCCUPANT LOAD:	
MERCANTILE: 4,617 SF/ 30 SF/ PERSON (GROSS) = 154 PEOPLE	
MERCANTILE OFFICE: (CALC. PER BUSINESS)	OCCUDANCY SEDADATION:

193 PEOPLE

OCCUPANCY SEPARATION:

193 PEOPLE

**BUILDING SECTION** 

SCALE: 1/8"=1'-0"

NON-SEPARTATED MIXED USE

DESIGN MEETS SPACE AND BULK

REQUIREMENTS FOR MERCANTILE

MERCANTILE(CLASS-B)/ BUSINESS

AS THE MOST RESTRICTIVE USE

5 (000) - UNPROTECTED

# NFPA 101 2009 CODE DATA

REQUIREMENTS FOR MERCANTILE

DISTANCE LIMITATIONS: (SPRINKLERED BUILDING)

AS THE MOST RESTRICTIVE USE

COMMON PATH OF TRAVEL:

BUSINESS: 100' MAX.

BUSINESS: 300' MAX.

MERCANTILE: 100' MAX.

MAXIMUM TRAVEL DISTANCE:

MERCANTILE: 250' MAX.

FIRST FLOOR: 592 SF/ 100 SF/ PERSON

STOREROOM: 7,110 SF/ 300 SF/ PERSON

TOTAL OCCUPANT LOAD =

USE GROUP CLASSIFICATION


TYPE OF CONSTRUCTION

OCCUPANT LOAD

SECOND FLOOR: 868 SF/ 100 SF PERSON


TOTAL AREA OF WORK: PROPOSED	13,187 SF
ACTUAL BUILDING AREA: EXISTING	12,884 SF
BUILDING HEIGHT	(1) STORY
FIRE SUPPRESSION:	YES-PER NFPA 13
EXIT ACCESS FIRE RATINGS:	
FIRE WALLS:	
PARTY WALLS	N/A (SAME TENANT)
STAIR ENCLOSURES	NA
SHAFTS	NA
EXIT ACCESS CORRIDORS	0 HOUR
FIRE PROTECTION OF STRUCTURE:	
PRIMARY STRUCTURAL FRAME	0 HOUR
LOAD BEARING WALLS - EXTERIOR	0 HOUR
LOAD BEARING WALLS - INTERIOR	0 HOUR
NON-LOAD BEARING WALLS - EXTERIOR	0 HOUR
NON-LOAD BEARING WALLS - INTERIOR	0 HOUR
FLOOR CONSTRUCTION	0 HOUR
ROOF CONSTRUCTION	0 HOUR
OCCUPANCY SEPARATION:	INTERIOR FINISHES:
NON-SEPARTATED MIXED USE	WALLS AND CEILINGS: CLASS A, B OR C
NON-SELAKTATED WILZED USE	FLOORS: CLASS 1 OR 2
DECICN MEETS CDACE AND DITLY	F.F.E. SHALL MEET NFPA 265 AND 701.
DESIGN MEETS SPACE AND BULK	

## **EXISTING WALL - COOLER**

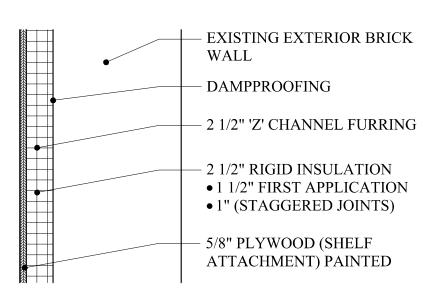

STOREROOM EXTERIOR WALL


### PROPOSED DEMISING WALL - INTERIOR

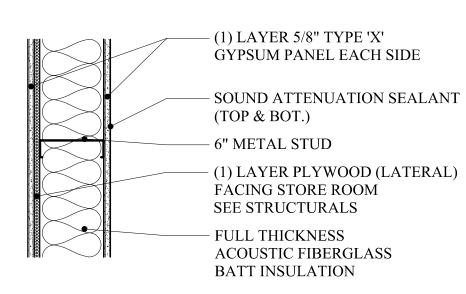


6" METAL SHEAR WALL - (1HR RATED) (UL DESIGN: U 419sim.) FIRE CAULK PERIMETER (stc 56)

> EXTEND WALL TO UNDERSIDE OF ROOF DECK ABOVE INSTALL ALL MATERIALS PER MANUFACTURE REQUIREMENTS

### **EXISTING WALL - INTERIOR**

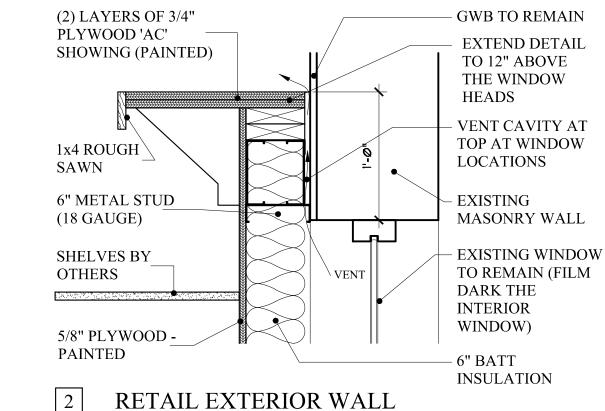

# PROPOSED WALL - INTERIOR

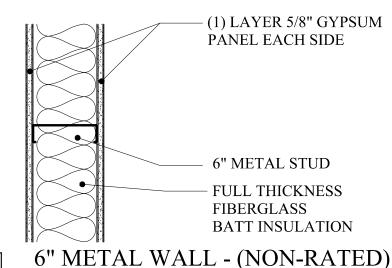

CAULK PERIMETER VEHICULAR LOADING AREA: EXTEND WALL TO


ROOF DECK ABOVE SIM: NON-INSULATED: EXTEND WALL TO ROOF DECK

ALTA VISTA | 2: project re-design

# EXISTING WALL - PARTY WALL


3 EXISTING WALL TO REMAIN MAINTAIN FIRE RATING

#### PROPOSED DEMISING WALL - INTERIOR

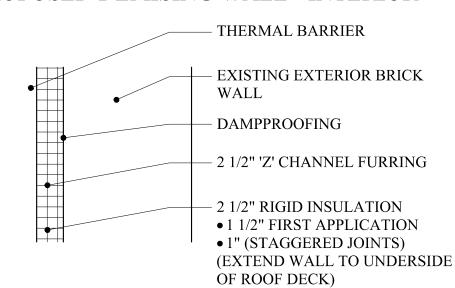

EXTERIOR WALL @ WALK-IN COOLER

### **EXISTING WALL - INTERIOR**

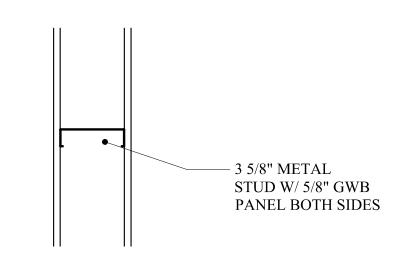

7 3 5/8"METAL STUD WALL - (NON- RATED)

7.1 3 5/8"METAL STUD WALL - (1 HR.- RATED) ADD: (1) LAYER 5/8" TYPE 'X' BOTH SIDES

\* INSTALL ALL MATERIALS PER MANUFACTURE REQUIREMENTS

# METAL STUD NOTES: METAL STUDS: <10' LENGTHS: 25 GA > 10' LENGTHS: 18 GA BRACE AS REQUIRED

#### DOOR SCHEDULE:


DOOR 1: 38"x84" AUTO-SLIDING DOOR W/ TRANSOM DOOR 2: SIM. TO ABOVE DOOR 4: TYPE A.1 DOOR 5: TYPE A.1 W/ CLOSER DOOR 6: TYPE A WITH CLOSER (FIELD VERIFY M.O.) OPENER/REMOTE, VISION PANELS DOOR 9: TYPE C W/ CLOSER DOOR 10: 72" X 84" METAL DOUBLE-ACTING DOORS, KICK PLATE BOTH SIDES DOOR 11: TYPE C, CLOSER DOOR 12: TYPE C, CLOSER DOOR 13: 10' X 10' high OHD, METAL INSULATED W/ ELECTRIC OPENER/REMOTE, VISION PANELS DOOR 14: TYPE C, CLOSER DOOR 15: TYPE C, CLOSER

DOOR 19: TYPE C, CLOSER DOOR 20: TYPE C, (1) HR. FIRE RATED W/ CLOSER

DOOR 22: TYPE A, W/ CLOSER DOOR 23: TYPE B, (1) HR. FIRE RATED DOOR W/ CLOSER DOOR 24: TYPE C


RELEASE AND PIVOT FOR EMERGENCY EGRESS

ALL OHD'S TO HAVE SAFETY DEVICES

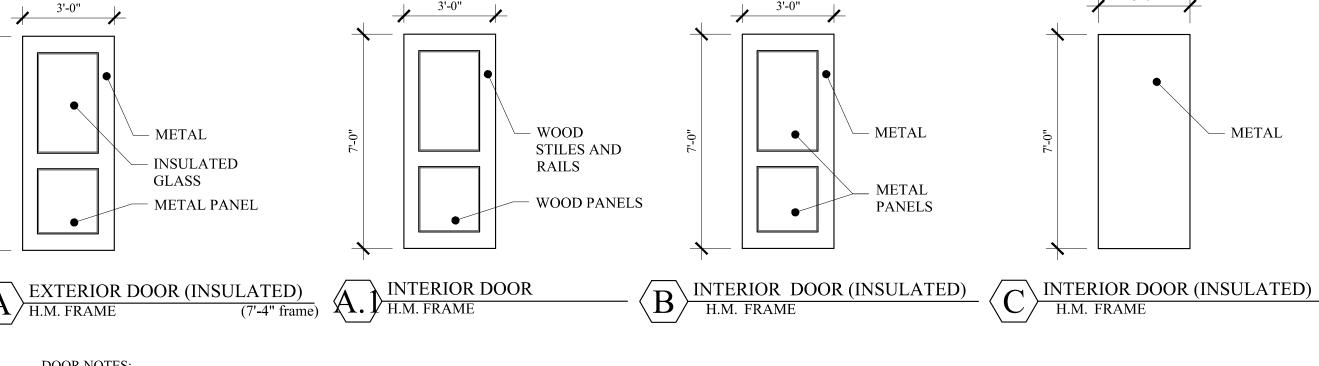

2. PROVIDE KEYING PER REQUIREMENTS THE BUILDING OWNER

DOOR NOTES:

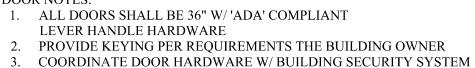

DOOR 3: 36"X84" SWING EXIT DOOR W/ TRANSOM, MATCH DOOR 1

DOOR 7: 36" GLASS COOLER DOOR, BY COOLER MANUFACTURE DOOR 8: 10' X 10' high OHD, METAL INSULATED W/ ELECTRIC

DOOR 16: 10' X 10' high OHD, METAL INSULATED W/ ELECTRIC


OPENER/REMOTE, VISION PANELS DOOR 17: TYPE A, CLOSER DOOR 18: TYPE C, CLOSER

DOOR 21: ETR (EXISTING TO REMAIN)

DOOR 25: TYPE B, W/ CLOSER DOOR 25: TYPE B, W/ CLOSER DOOR 26: TYPE B, W/ CLOSER

DOOR 2.1: TYPE A.1, (1) HR. FIRE RATED W/ CLOSER DOOR 2.2: TYPE A.1 DOOR 2.3: TYPE A.1

DOOR 1 & 2: SHALL UPON FIRE ALARM ACTIVATION

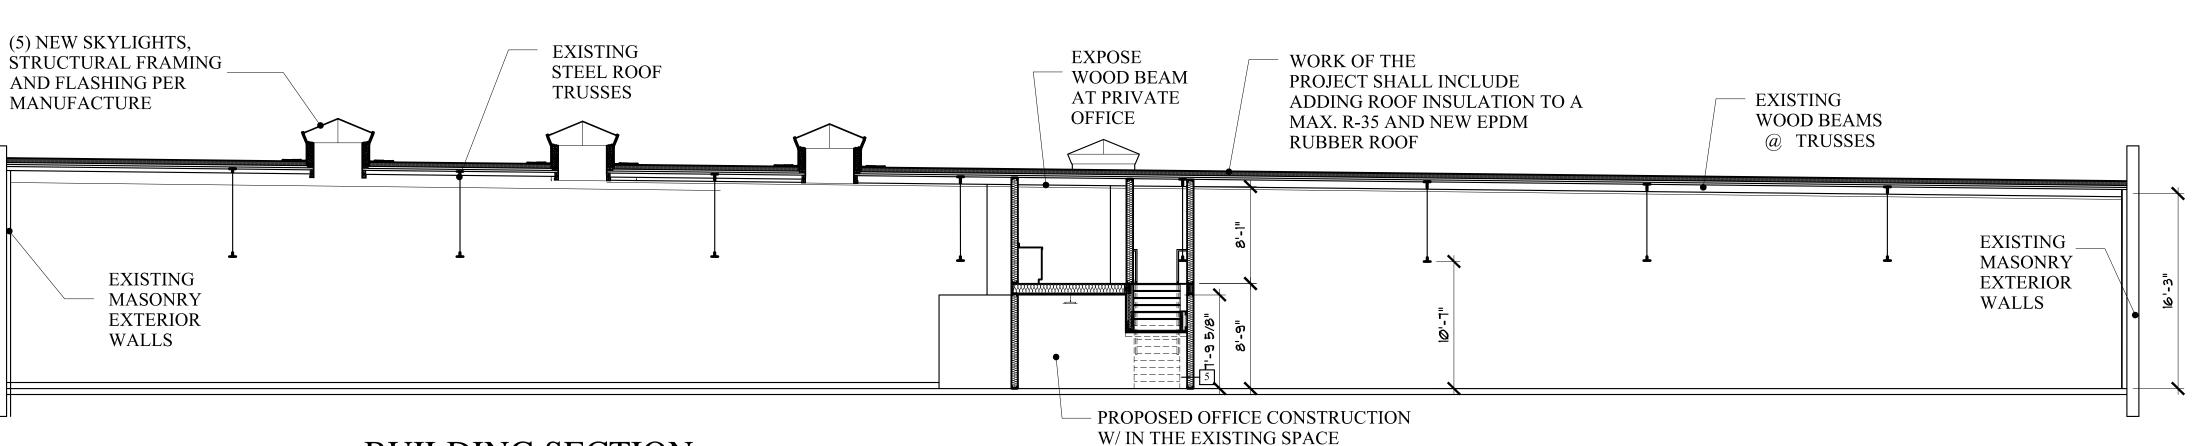

FOR BUILDING PERMITS JUNE 9, 2017

SECTION

DING

MARCH. 2017

ALTA VISTA | 2

DRAWN BY

CHECK BY

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