GENERAL DEMOLITIONS NOTES

- 1. GENERAL CONTRACTOR IS RESPONSIBLE TO COORDINATE CONSTRUCTION PHASING.
- 2. IN AREA OF WORK, G.C. SHALL BE RESPONSIBLE TO PATCH AND REPAIR ALL EXISTING CONSTRUCTION WHICH IS TO REMAIN.
- 3. GENERAL CONTRACTOR SHALL NOTIFY OWNER OF ANY HAZARDOUS MATERIALS DISCOVERED DURING DEMOLITION OR RE-CONSTRUCTION. G.C. SHALL REMOVE AND DISPOSE OF ALL HAZARDOUS MATERIALS IN ACCORDANCE WITH STATE AND LOCAL LAWS. ALL WORK SHALL BE PERFORMED BY A LICENSED ABATEMENT PROFESSIONAL. G.C. SHALL PROVIDE THE OWNER WITH ALL DOCUMENTS CERTIFYING THAT THE REMOVAL AND DISPOSAL MEETS ALL STATE AND LOCAL LAWS.
- 4. IF ANY QUESTIONS ARISE AS TO THE REMOVAL OF ANY MATERIAL, CLARIFY THE POINT WITH THE ARCHITECT BEFORE PROCEEDING.
- 5. DEMOLITION IS NOT NECESSARILY LIMITED TO WHAT IS SHOWN ON THE DRAWINGS. THE INTENT IS TO INDICATE THE GENERAL SCOPE OF DEMOLITION REQUIRED TO COMPLETE THE WORK IN ACCORDANCE WITH THE CONTRACT DOCUMENTS.
- 6. CONTRACTOR TO REMOVE AND DISPOSE OF ALL CARPET AND VCT IN ACCORDANCE WITH STATE AND LOCAL LAWS.
- 7. CONTRACTOR TO PREPARE EXISTING SUB-FLOOR AS REQUIRED FOR NEW FLOOR FINISHES.
- 8. ANY/ ALL EXISTING FIREPROOFING FOUND ON EXISTING STRUCTURE (COLUMNS, BEAMS, SLAB) SHALL BE PROTECTED & REMAIN INTACT.
- 9. IN PARTITIONS TO BE REMOVED REMOVE AND CAP ALL ELECTRICAL OUTLETS, SWITCHES, THERMOSTATS, WIRES, ETC. TO THEIR SOURCE AS REQUIRED.
- 10. CONTRACTOR TO STORE AND REMOVE ALL DEBRIS FROM SITE.
- 11. CONTRACTOR IS RESPONSIBLE TO CHECK WITH THE BUILDING OWNER OF ANY ITEMS TO BE SAVED AND RETURNED TO THE BUILDING OWNER PRIOR TO REMOVAL.
- 12. ALL WIRING, SWITCHING AND OUTLETS TO BE REMOVED A TERMINATED AT THE PANEL.
- 13. ALL ELECTRICAL WIRE MOLDING TO BE REMOVED AND SURFACES TO BE CLEAR OF ALL FASTENERS.

GENERAL ARCHITECTURAL NOTES

- 1. ALL DIMENSIONS SHOWN FROM EXISTING WALLS ARE GIVEN TO FACE OF EXISTING FINISH. ALL NEW WALLS ARE DIMENSIONED TO THE CENTER OF WALL UNLESS OTHERWISE NOTED.
- 2. SEE SITE PLAN DRAWINGS FOR ALL SITE RELATED CONSTRUCTION AND DETAILS
- 3. CONTRACTOR TO PROVIDE BLOCKING CONCEALED WITHIN PARTITION FOR SECURE ATTACHMENT OF MILLWORK CONSTRUCTION AND EQUIPMENT.
- 4. ALL DOOR OPENINGS TO BE PRE-FINISHED. OFFSET 6" FROM FINISH FACE OF PERPENDICULAR PARTITION, U.N.O.
- 5. ALL WORK SHALL BE ERECTED AND INSTALLED PLUMB, LEVEL, SQUARE AND TRUE, AND IN PROPER ALIGNMENT.
- 6. RELOCATE EXISTING FIRE SAFETY, ELECTRICAL DEVICES TO ADJOINING OR ADJACENT WALL, U.N.O . NOTIFY NEW PLACEMENT W/ ARCHITECT PRIOR TO REINSTALLATION.

GENERAL HVAC & PLUMBING NOTES

- 1. HVAC TO BE DESIGN PROVIDE AS A DESIGN BUILD SERVICE. ALL DESIGN AND CONSTRUCTION IS TO MEET THE HVAC PERFORMANCE SPECIFICATION. ALL RETURNS TO BE LOCATED AFTER LIGHTING HAS BEEN INSTALLED. SUPPLY AND INSTALLATION OF ADDITIONAL DUCTWORK, DIFFUSERS AND RETURNS AS REQUIRED TO ACCOMMODATE NEW USE.
- 2. COMPLY WITH LOCAL HEATING CODES AND REGULATIONS.
- 3. CONTRACTOR TO PROVIDE A COMFORT-BALANCE REPORT AT OR NEAR DESIGN CONDITIONS DURING THE FIRST HEATING AND COOLING SEASONS.
- 4. INSTALLATION SHALL BE DONE TO GUARANTEE SATISFACTORY AIR CIRCULATION AND ACCEPTABLE NOISE LEVELS.

5. G.C. IS NOT RESPONSIBLE FOR THE OPERATION AND MAINTENANCE OF EQUIPMENT.

GENERAL ELECTRICAL NOTES

- 1. ALL ELECTRICAL INSTALLATIONS AND EQUIPMENT SHALL BE IN ACCORDANCE WITH THE NATIONAL ELECTRICAL CODE AS AMENDED, (nfpa 70) OR THE STANDARD BUILDING CODE OF NEW HAMPSHIRE, LATEST EDITION.
- 2. ALL EXPOSED WIRING SHALL BE INSTALL IN METAL CABLE AS REQUIRE BY STATE AND LOCAL ELECTRICAL CODE.
- 3. ELECTRICAL WORK FOR THE PROJECT INCLUDES REMOVAL OF EXISTING LIGHT FIXTURES AS WELL AS SUPPLYING AND INSTALLING NEW FIXTURES TO EXISTING AND NEW CIRCUITS; RELOCATING EXISTING CIRCUIT AND WIRING; TYING NEW DUPLEX OUTLETS TO EXISTING POWER AND/OR LIGHTING CIRCUITS, AND NEW LIGHTING, SWITCHING AND POWER FOR NEW SPACES AS REQUIRED.
- 4. ALL SWITCHES, RECEPTACLES AND OTHER ELECTRICAL LOCATIONS SHALL BE COORDINATED WITH ALL OTHER TRADES.
- 5. ALL NEW SWITCHES CONTROLLING WIRING SHALL BE LOCATED TO MATCH EXISTING.
- 6. GROUNDING SHALL BE PROVIDED IN ACCORDANCE WITH THE REQUIREMENTS OF THE NATIONAL ELECTRICAL CODE, UTILITY COMPANY AND ALL AUTHORITIES HAVING JURISDICTION.
- 7. PROVIDE GROUND FAULT INTERRUPTION (GFI) RECEPTACLES AS PER NEC.
- 8. FURNISH ROUGH WIRING AND FINAL ACCEPTANCE CERTIFICATE FROM AUTHORITY PERFORMING INSPECTIONS.

GENERAL REFLECTED CEILING NOTES

TELEPHONE BASE BLOCK AND I.T. CENTRAL LOCATION

1	. CONTRACTOR TO REMOVE AND DISPOSE OF ALL CEILING TILES AND TRACK.
2	2. COORDINATE THE WORK OF ALL TRADES INVOLVED IN THE CEILING WORK TO INSURE CLEARANCES FOR FIXTURES, DUCTS, PIPING, CEILING SUSPENSION SYSTEM, ETC. NECESSARY TO MAINTAIN THE FINISHED CEILING HEIGHTS INDICATED ON THE CONTRACT DOCUMENTS.
3	SUPPLY AND INSTALL ALL SUSPENDED TRACK AND MATERIAL REQUIRED TO COMPLETE THE WORK AS INDICATED ON THE DRAWINGS. PROVIDE ALL TIES FOR LIGHT FIXTURES, EXIT SIGNS AND OTHER CEILING/ SOFFIT ELEMENTS FOR SECURE ATTACHMENT OF GENERAL CONSTRUCTION.
4	LIGHTING TO BE LOCATED AS BEST AS POSSIBLE WITH PROPOSED LAYOUT.
5	5. CEILING TILES TO BE ARMSTRONG CIRRUS SECOND LOOK - II, 513.
TEL	_EPHONE & DATA WIRING NOTES
1	TELEPHONE AND DATA DUAL JACK LOCATION RUN (2) CAT 5E CABLES BACK TO

CODE	MANUFACTURE	MATER
FLOOR	ING	
C-1	TO BE DETERMINED	CARPET TILE
L-1	METRO FLOORING	LAMINATED FLOOR
V-1	ARMSTRONG	VINYL COMPOSITE
M-1	MATS INC	SUPER NOP 52 TILE
BASE		
B-1	JOHNSONITE	4.25 MILLWORK CO
WALLS		
P-1	BENJAMIN MOORE	LATEX EGGSHELL
P-2		
P-3		
DOOR	FRAMES	
TR-1		
MILLWO	ORK	
PL-1	WILSONART	
PL-2	WILSONART	
PL-3	WILSONART	
SS-1	WILSONART	
ML-1	WILSONART	
CEILING	3	
ACT-1	ARMSTONG	CIRRUS SECOND L


GENERAL FINISH NOTES


- WITH MANUFACTURES SPECIFICATIONS AND REQUIREMENTS.
- THE AMOUNT OF FLOOR LEVELING REQUIRED. INFORM SOLIDUS OF REQUIRED LEVELING AND INCLUDE ALL COSTS WITH BID.
- COLOR MAY REQUIRE SEVERAL COATS.
- 5. FLOORING TRANSITION SHALL OCCUR AT CENTER LINE OF DOOR.
- 6. REMOVE ALL ROUGH SPACKLE, ETC. FROM WALL TO PROVIDE A SMOOTH SURFACE WHERE BASE IS TO BE APPLIED.

6	NTS	FINISH KEY

	GYP-CRETE OVER 3/4" PLYWOOD	
	1 3/4 x 9 1/2 LVL @ 16" O.C. NEW ALUMINUM STORE FRONT	
	- EXISTING ENTRY MASONRY BLOCK. ~	
4	3/4"=1'-0"	SECTION AT IN

					1
2	NTS	GENERAL NOTES	1	1/4"=1'-0"	PROPOS

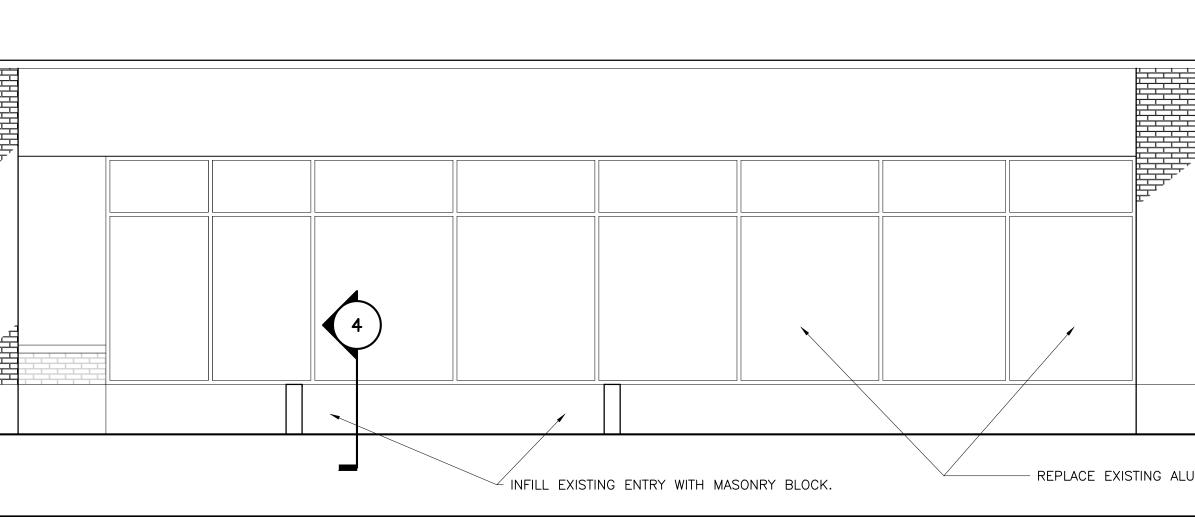

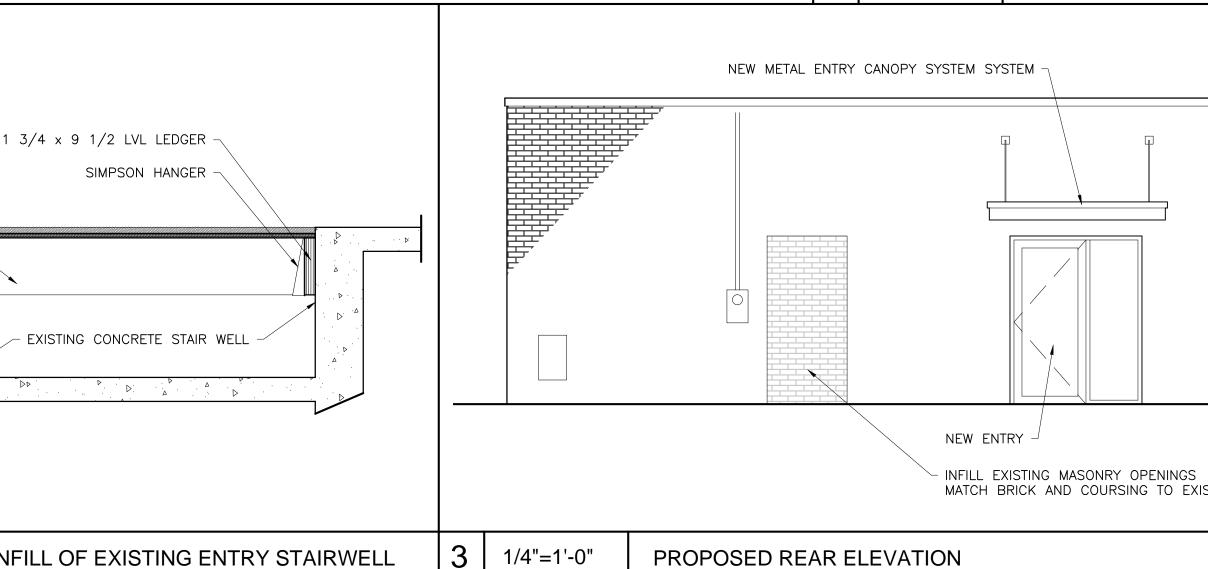

5

4. PROVIDE HARD RUBBER TRANSITION STRIP AT TRANSITION FROM RESILIENT FLOORING AND CARPET.

3. ALL PAINT SHALL BE APPLIED IN ACCORDANCE WITH MANUFACTURES SPECIFICATIONS FOR PARTICULAR SURFACES. PROVIDE A MINIMUM TWO(2) COATS OVER (1) PRIMER COAT AS REQUIRED. TOUCHUP WHERE REQUIRED BEFORE COMPLETION. AREAS WHERE EXISTING DARK

2. CONTRACTOR IS REQUIRED TO FIELD INSPECT EXISTING FLOOR CONSTRUCTION AND SLABS CONDITIONS, PRIOR TO BID, AND DETERMINE

1. CONTRACTOR TO SUBMIT ALL FINISHES FOR ARCHITECT'S APPROVAL PRIOR TO INSTALLATION. INSTALLATION OF FINISHES TO COMPLY

FINISH	KEY		
RIAL / STYLE	PATTERN	COLOR	REMARKS
RING			
TILE			
		STEEL BLUE	
		1	[
CONTOURED WALL BASE - REVEAL MW-XX-F			1
			l
LOOK - II	513 CIRRUS		

		ROOM	FINI	SH S	SCH	EDU	ILE						Graham Architects
RM. No.	ROOM NAME	FLOOR	FLOOR FINISH	BASE	MAT.	WA FIN.	LLS PRIMARY	ACCENT	MAT.		HGT.		59 Mills Road
NO. .00	ENTRY VESTIBULE	M-1	-	Bl	GYP.	FIIN. PAINT	PAINT P-1	PAINT -	ACT	FIN. ACT 1	9'-0"		Kennebunkport, ME 04046 207.967.8850 www.grahamarchitects.c
.01	WAITING	C-1	-	B1	GYP.	PAINT	P-1	-	ACT	ACT 1	9'-0"		
L02	OFFICE MANAGER BUSINESS OFFICE	C-1 C-1	-	B1	GYP. GYP.	PAINT	P-1 P-1	-	ACT ACT	ACT 1 ACT 1	9'-0" 9'-0"		
103 104	IMAGING	L-1	-	B1 B1	GIP. GYP.	PAINT	P-1 P-1	_	ACT	ACT 1	9'-0"		
105	JANITOR'S CLOSET	V-1	-	B1	GYP.	PAINT	P-1	-	ACT	ACT 1	9'-0"		
106		V-1	-	B1	GYP.	PAINT	P-1	_	ACT	ACT 1	9'-0"		
107 108	BATHROOM	V-1 V-1		B1 B1	GYP. GYP.	PAINT	P-1 P-1	-	ACT ACT	ACT 1 ACT 1	9'-0" 9'-0"		GENERAL CONTRACTOR
109	PRIVATE OFFICE	L-1	-	B1	GYP.	PAINT	P-1	-	ACT	ACT 1	9'-0"		
110	CLOSET	L-1	-	B1	GYP.	PAINT	P-1	-	ACT	ACT 1	9'-0"		
111 112	I.T. CLOSET CONFERENCE ROOM	V-1 C-1		B1 B1	GYP. GYP.	PAINT	P-1 P-1	-	ACT ACT	ACT 1 ACT 1	9'-0" 9'-0"		
113	CLOSET	V-1	-	Bl	GYP.	PAINT	P-1	-	ACT	ACT 1	9'-0"		
114	LAUNDRY	V-1	-	B1	GYP.	PAINT	P-1	-	ACT	ACT 1	9'-0"		STRUCTURAL ENGINEER
L15 L16	KITCHEN STAFF ENTRY	V-1 V-1	_	B1 B1	GYP. GYP.	PAINT	P-1 P-1	-	ACT ACT	ACT 1 ACT 1	9'-0" 9'-0"		
117	STAFF BATHROOM	V-1	-	Bl	GYP.	PAINT	P-1	_	ACT	ACT 1	9'-0"		
118	MECHANICAL ROOM	EXIST. CONCRETE	PAINT	B1	GYP.	PAINT	P-1	_	ACT	ACT 1	9'-0"		
L19 L20	TREATMENT TREATMENT	L-1 L-1	-	B1 B1	GYP. EXIST.	PAINT	P-1 P-1	-	ACT ACT	ACT 1 ACT 1	9'-0" 9'-0"	⊢	MEP ENGINEER
L20 L21	TREATMENT	L-1	-	Bl	GYP.	PAINT	P-1 P-1	-	ACT	ACT 1	9'-0" 9'-0"		-
L22	TREATMENT	L-1	-	B1	GYP.	PAINT	P-1	-	ACT	ACT 1	9'-0"		
123	TREATMENT TREATMENT	L-1	-	B1	GYP.	PAINT	P-1	-	ACT	ACT 1	9'-0"		
124 125	TREATMENT	L-1 L-1	-	B1 B1	GYP. GYP.	PAINT	P-1 P-1	-	ACT ACT	ACT 1 ACT 1	9'-0" 9'-0"		
126	TREATMENT	L-1	-	Bl	GYP.	PAINT	P-1	_	ACT	ACT 1	9'-0"		
127 128	TREATMENT STERILIZATION	L-1 L-1	-	B1 B1	GYP. GYP.	PAINT	P-1 P-1	-	ACT ACT	ACT 1 ACT 1	9'-0" 9'-0"	⊢	CLIENT
	SYSTEM SYSTEM	F FINISH SCHE	DULE										PROJECT New Office Renovation 563 Forest Avenue Portland, ME 04101
PY 5			DULE										New Office Renovation
			DULE										New Office Renovation
			DULE										S63 Forest Avenue Portland, ME 04101
			DULE										S63 Forest Avenue Portland, ME 04101 Image: Second state of the sec
	SYSTEM SYSTEM	SONRY OPENINGS											S63 Forest Avenue Portland, ME 04101
	SYSTEM SYSTEM												
PY S	SYSTEM SYSTEM	SONRY OPENINGS											S63 Forest Avenue Portland, ME 04101 Image: Constraint of the output of the o
PY S	SYSTEM SYSTEM	SONRY OPENINGS											<section-header> Sd3 Forest Avenue Portland, ME 04101 Sd3 Forest Avenue Portland, ME 04101 Sd3 Forest Avenue Portland, ME 04101 Support Avenue Portland, ME 04101 Support Avenue Portland, ME 04101 Support Portland NFORMATION Path: M:/boulos/endodontics Insue Date: 12/31/13 Drawn By: dig Checked By: </section-header>
PY S	SYSTEM SYSTEM	SONRY OPENINGS						EDGE BUILD					Sá3 Forest Avenue Só3 Forest Avenue Portland, ME O4101
PY S	SYSTEM SYSTEM	SONRY OPENINGS						BUILE	OF ADJA				S63 Forest Avenue Portland, ME 04101 S63 Forest Avenue Portland, ME 04101 Several Avenue Portland, ME 04101 Several Avenue Portland, ME 04101 SEVED FOR PERAUT INFORMATION Path: M:/boulos/endodontics Issue Date: 12/31/13 Drawn By: dig Checked By: 1. 2. 3.
PY S	SYSTEM SYSTEM	SONRY OPENINGS						BUILE					S63 Forest Avenue Portland, ME 04101 S63 Forest Avenue Portland, ME 04101 S63 Forest Avenue Portland, ME 04101 Sevent Avenue Portland, ME 04101 SEVED FOR PERMIT INFORMATION Path: M:/boulos/endodontics Issue Date: 12/31/13 Drawn By: dig Checked By: 1. 2. 3.
PY S	SYSTEM SYSTEM	SONRY OPENINGS						BUILE					Só3 Forest Avenue Só3 Forest Avenue Portland, ME 04101
PY S	SYSTEM SYSTEM	SONRY OPENINGS						EXIST FACA					Sd3 Forest Avenue Sd3 Forest Avenue Portland, ME 04101 INFORMATION NFORMATION Path: M:/boulos/endodontics Issue Date: 12/31/13 Drawn By: dig Checked By: Revision: 1. 2. 3. 4. TITLE FINISH SCHEDULE AND
PY S	SYSTEM SYSTEM	SONRY OPENINGS						EXIST FACA					Só3 Forest Avenue Só3 Forest Avenue Portland, ME 04101 INFORMATION NrSORMATION Path: M:/boulos/endodontics Issue Date: 12/31/31 Drawn By: dig Checked By: Revision: 1. 2. 3. 4. TITLE FINISH SCHEDULE AND GENERAL NOTES SCALE 1/4"=1'-0"
	SYSTEM SYSTEM	SONRY OPENINGS						EXIST FACA					SG3 Forest Avenue SG3 Forest Avenue Portland, ME 04101 INFORMATION NFORMATION Markin Michaele NFORMATION NEORMATION NEORMATION NEORMATION Michaele NEORMATION