

# SIGN SPECIFICATIONS

## SCOPE

THIS SIGN WORK SHALL CONSIST OF THE CONSTRUCTION AND INSTALLATION OF ONE NEW DOUBLE-FACED READERBOARD PYLON SIGN. SIGN POWER, FOUNDATION AND COLUMN BY DEVELOPER'S CONTRACTOR. WALGREENS' SIGN FACES AND CABINETS BY WALGREENS' SIGN CONTRACTOR.

## RESTRICTIONS

LOCAL SIGN CODE LIMITS THE FACE AREA OF FREESTANDING SIGNAGE TO 100 SQ.FT. AND A MAXIMUM SIGN HEIGHT OF 18'-0"

## I.D. PANEL

WALGREENS' PRIMARY PANEL SIGN FACES TO BE FABRICATED FROM 3M PANAFLEX WITH #3630-53 "CARDINAL RED" BACKGROUND, SCRIPT 'W' AND INNER SURFACE OF MORTAR. OUTER SURFACES OF MORTAR & PESTLE AND SCRIPT 'WALGREENS' COPY TO BE WHITE.

THE MORTAR AND PESTLE SYMBOL: 6'-2" OVERALL SYMBOL HEIGHT AND 5'-6 1/2" OVERALL SYMBOL WIDTH.

"WALGREENS" SCRIPT COPY FOR ID PANELS: 11" CAPITAL AND 6 1/4" LOWER CASE LETTER HEIGHTS; 1'-2 3/4" OVERALL COPY HEIGHT AND 5'-6 1/2" OVERALL LENGTH.

## READERBOARD

TWO SINGLE-FACED DISPLAYS WITH RED LED PIXELS. HIGH RESOLUTION WITH SHADING.

- 5'-0" X 15'-4 1/2" (HIGHWAY STANDARD); FOUR TO EIGHT LINES OF COPY.
- 3'-8" X 10'-11" (PREFERRED OPTION); THREE TO SIX LINES OF COPY.
- 2'-8" X 8'-8" (ALTERNATE OPTION); TWO TO FOUR LINES OF COPY.
- 2'-8" X 5'-9" (BLADE SIZED); TWO TO FOUR LINES OF COPY.

## STRUCTURE

DARK BRONZE FINISH ALUMINUM CABINETS FROM .063" THICK STOCK.

## ELECTRICAL/DATA CABLE

INTERNAL C.W.H.O. FLUORESCENT ILLUMINATION.

PROVIDE TWO (2) CONDUITS TO PYLON: ONE FOR LIGHTING CIRCUIT. THE OTHER FOR COAXIAL CABLE FROM CONTROL CENTER TO LED READERBOARD. PROVIDE 300' COAXIAL CABLE FOR EACH GROUND SIGN (REFER TO SITE PLAN).

PROVIDE TWO SEPARATE RECESSED, WEATHER-RESISTANT JUNCTION BOXES FOR ELECTRICAL AND DATA CABLE CONNECTIONS. LOCATE AT LEAST 3' ABOVE GRADE OR AS HIGH AS POSSIBLE.

PROVIDE DISCONNECT SWITCH ON EXTERIOR OF SIGN FOR EACH CIRCUIT TO COMPLY WITH STATE AND LOCAL CODES.

ALL SIGNS TO BE FABRICATED ACCORDING TO THE UNDERWRITERS LABORATORIES SPECIFICATIONS AND TO BEAR UL LABELS.


## CONTRACTOR

ALL DIMENSIONS AND CONDITIONS TO BE VERIFIED IN THE FIELD BY THE SIGN CONTRACTOR PRIOR TO SIGN FABRICATION.

SIGN CONTRACTOR SHALL BE RESPONSIBLE FOR SIGNS' COMPLIANCE TO ALL APPLICABLE CODES AND ORDINANCES.

SIGN CONTRACTOR SHALL OBTAIN ALL PERMITS NECESSARY TO INSTALL THE SIGN.

SIGN CONTRACTOR SHALL FURNISH (2) TWO SETS OF SHOP DRAWINGS FOR APPROVAL TO THIS OFFICE BEFORE FABRICATION.

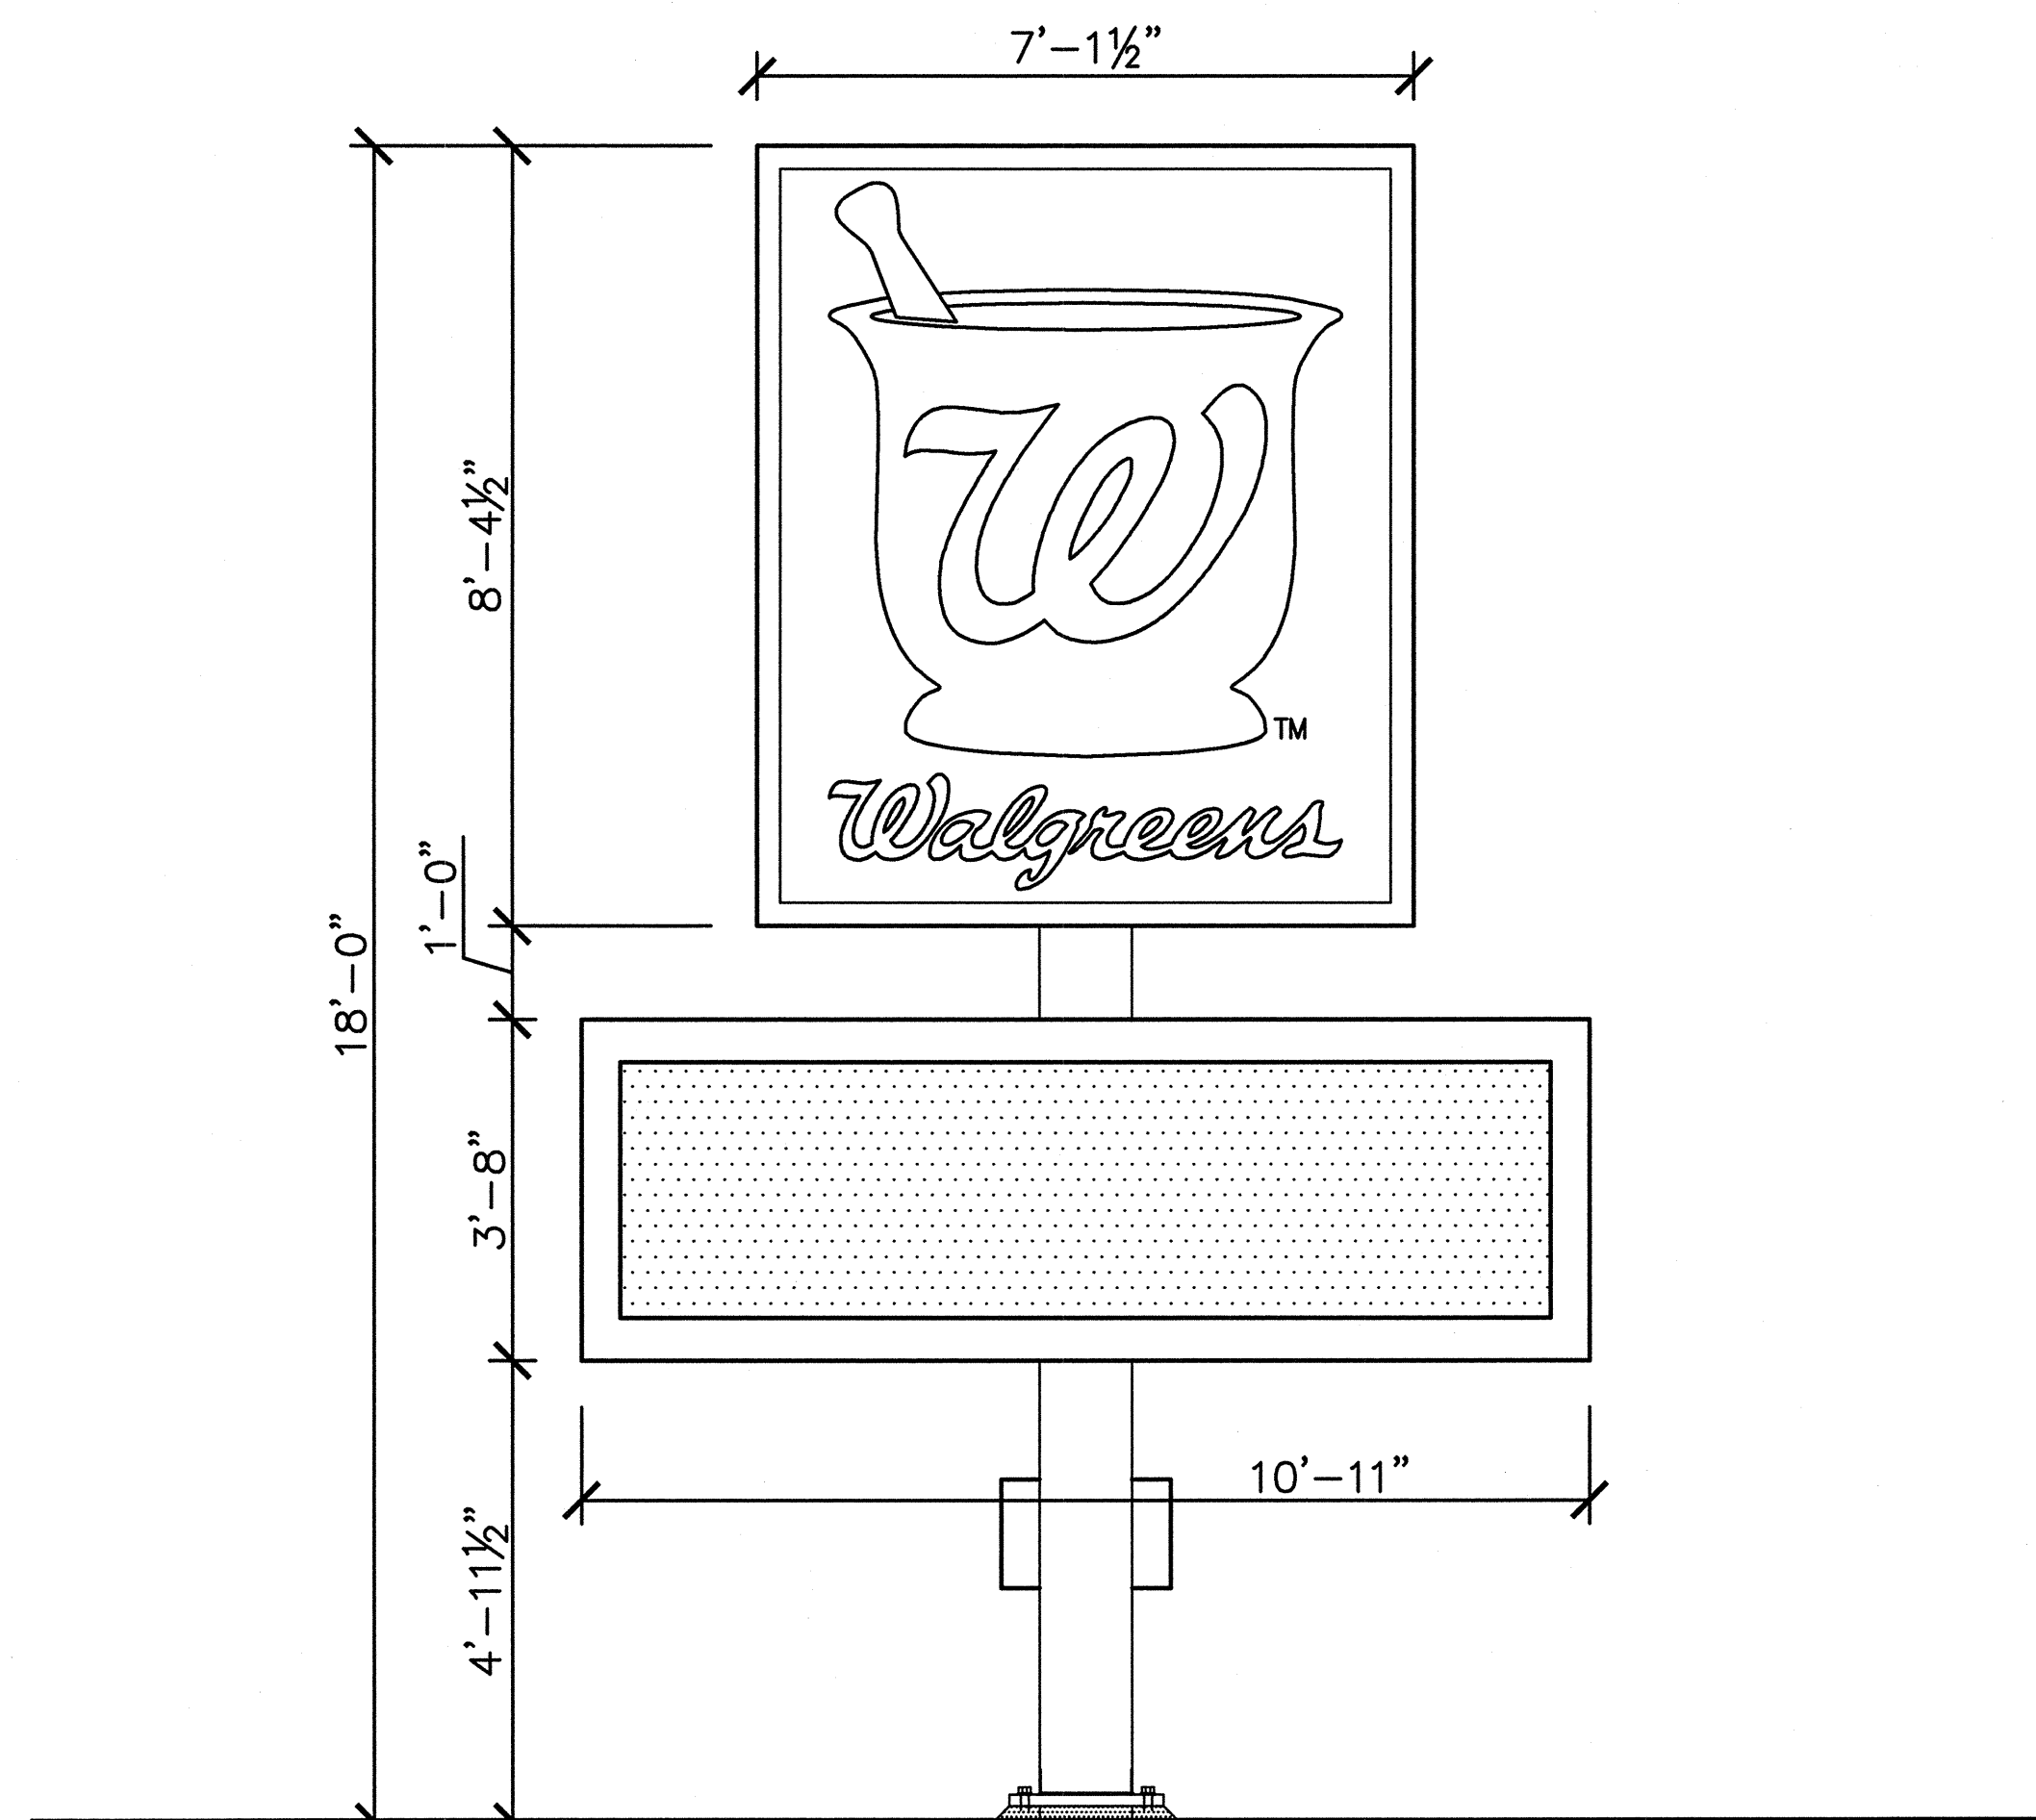


PRIMARY PANEL:	59.58 S.F.
LED READERBOARD:	40.03 S.F.
TOTAL SIGN AREA:	99.61 S.F.

1

## ELEVATION (FIRST CHOICE)

SCALE: 1/4" = 1'-0"

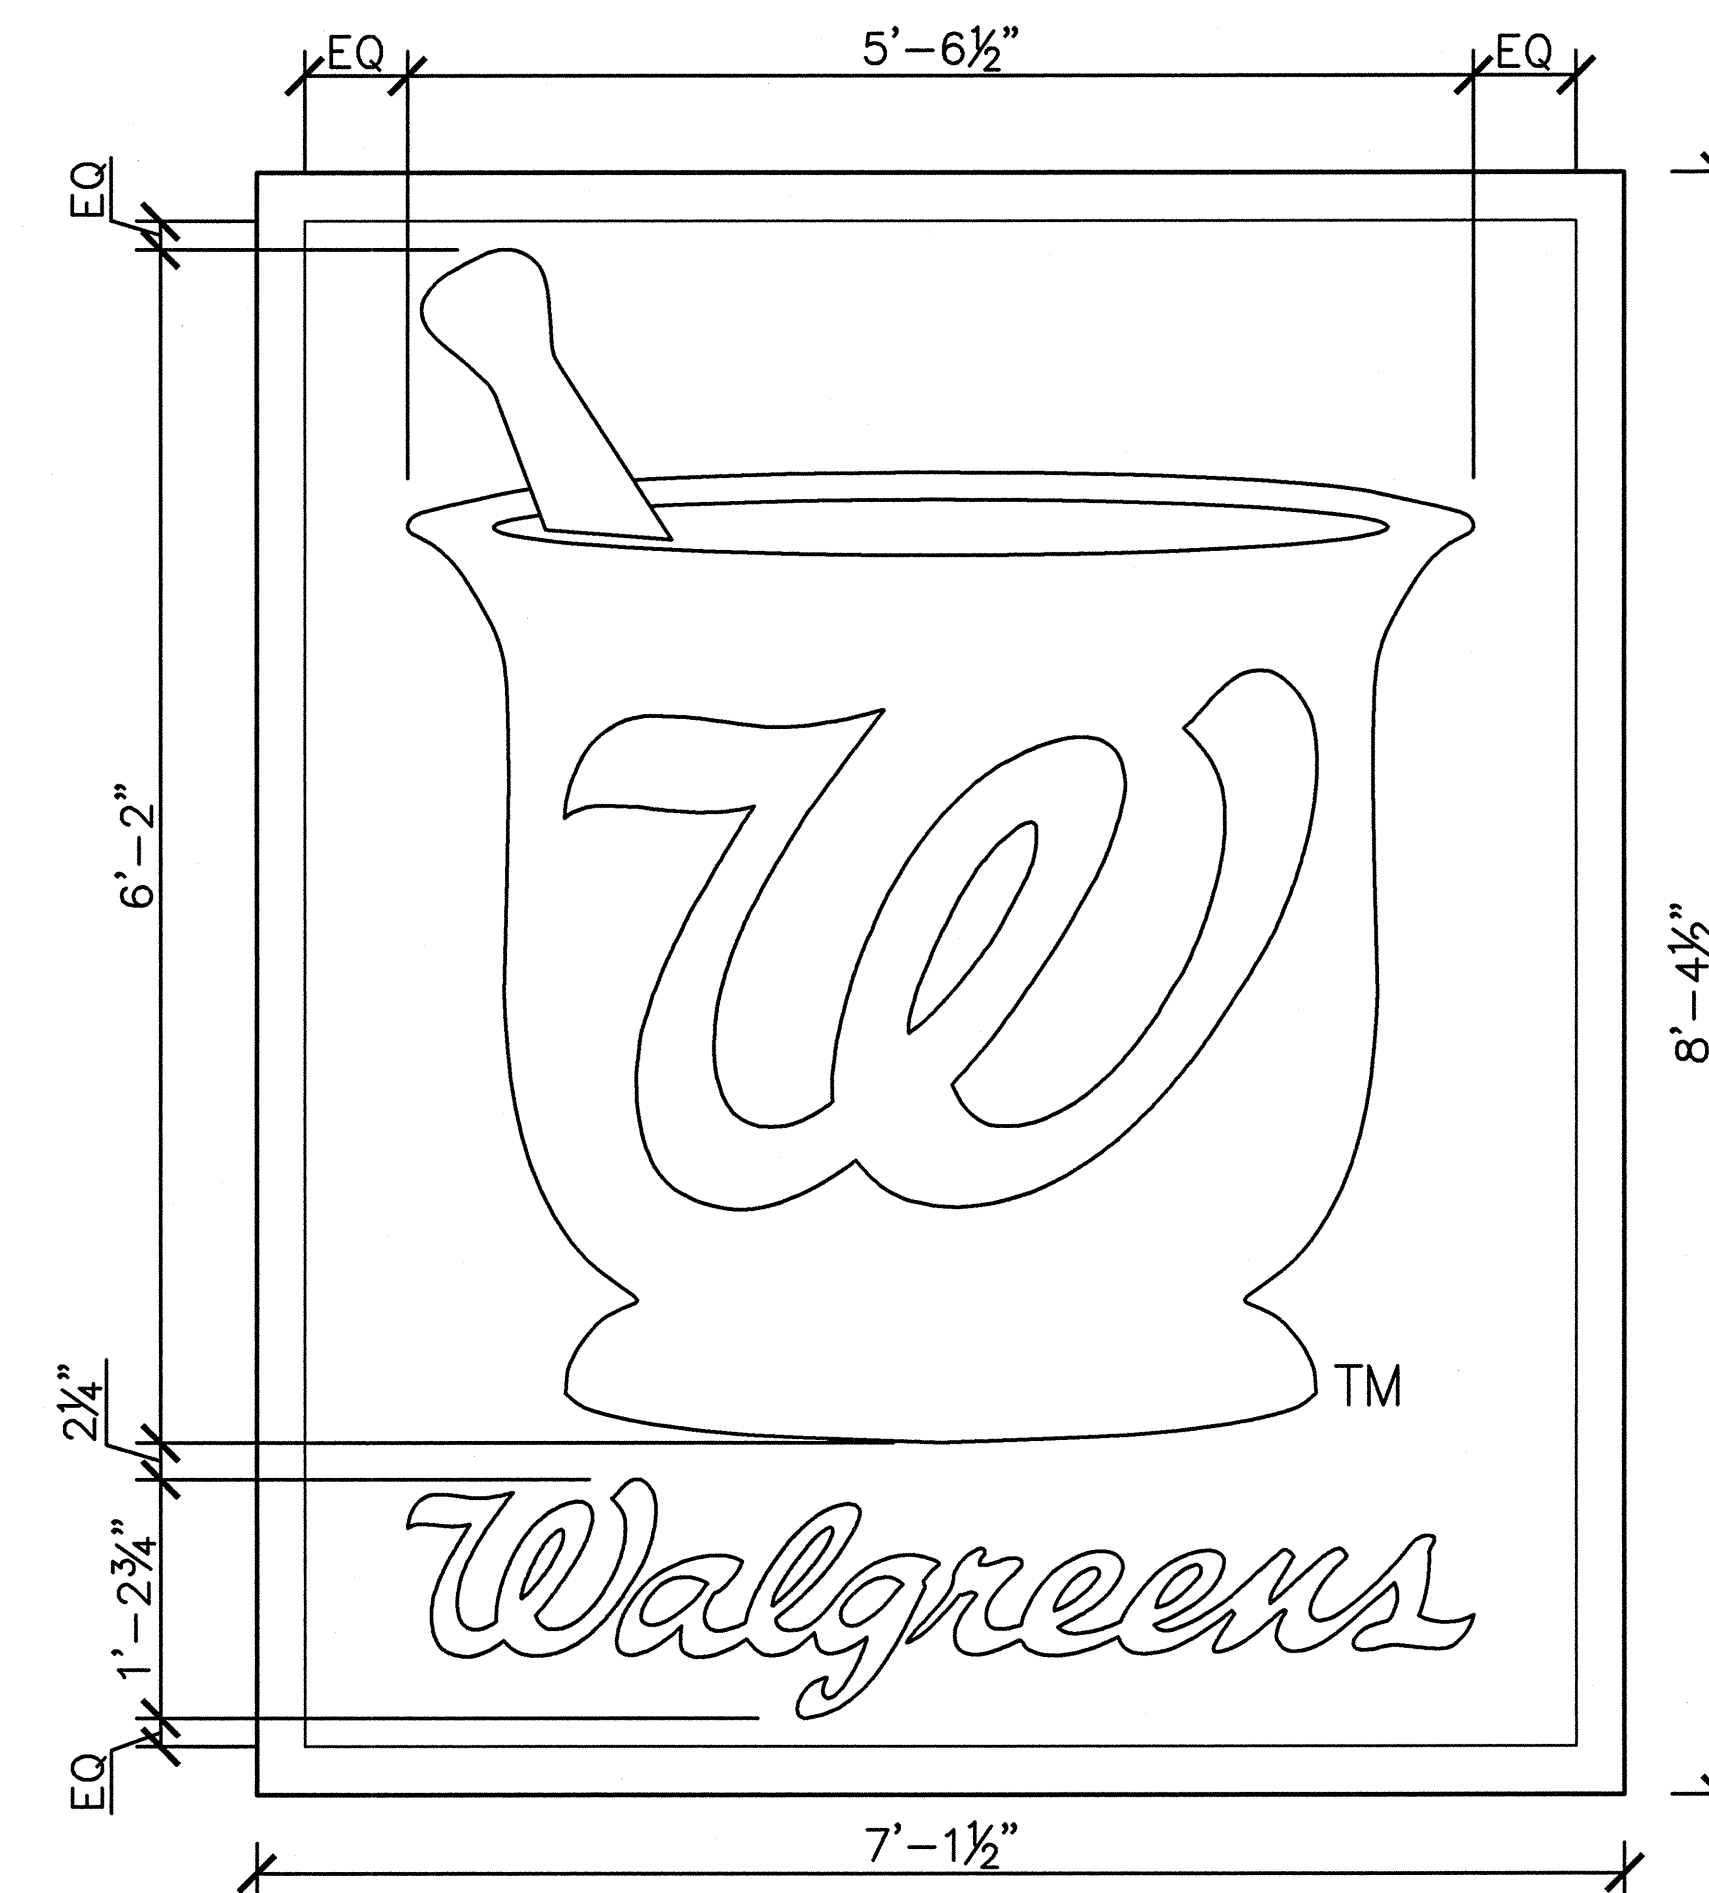

2

## SIGN FACE DETAIL

SCALE: 1/2" = 1'-0"

## PRELIMINARY

THIS DRAWING IS TO CONVEY DESIGN INTENT ONLY: THE REGISTERED ARCHITECT RESPONSIBLE FOR THIS PROJECT SHOULD INCORPORATE THIS DRAWING'S DATA ALONG WITH GRADES, OBSTRUCTIONS, STRUCTURAL REQUIREMENTS, GOVERNING CODE RESTRICTIONS OR ANY OTHER FACTORS THAT MAY ALTER THIS DRAWING.

**Walgreens**

FACILITIES PLANNING, DESIGN, & ENGINEERING  
108 WILMOT ROAD  
DEERFIELD, IL 60015-4616

NO.	DATE	BY	DESCRIPTION	CONST

REVISIONS

STORE NUMBER 12325

PROJECT NAME

**WALGREENS STORE**  
(SWC) FOREST & REVERE  
PORTLAND, ME

DRAWING TITLE  
FREESTANDING SIGNAGE-100SF

CADD PLOT:	SCALE: AS SHOWN	DRAWING NO.
VOID PLOT:	DRAWN BY: HERWEG	D5.1
SUPERSEDES PLAN DATED:	DATE: 5/FEB/08	
	REVIEWED BY:	OF DWGS.