PROJECT INFORMATION: The fire protection project consists of installing a wet sprinkler system in this 3 unit apartment at 77 Willams st. Portland. **WATER SUPPLY:** This is a wet sprinkler system supplied by a 1-1/4" poly line connected to a city water supply. A 2-1/2" fire dept connection will be installed for use by the fire dept. **CONSTRUCTION TYPE:** Construction type is "wood construction with gypsum wall board" **CODE REFERENCES:** NFPA 13R 2016 ed. SPRINKLER SYSTEM NOTES * DESIGN AND INSTALLATION SHALL CONFORM TO N.F.P.A. #13R (2016) & LOCAL FIRE AND BLDG. DEPTS. * HANGER INSTALLATION AND SPACING SHALL BE IN ACCORDANCE WITH N.F.P.A. #13 * FIELD FOREMAN TO VERIFY LOCATION OF HIGH TEMPERATURE SPRINKLERS AND INSTALL HIGH TEMPERATURE SPRINKLERS IN ACCORDANCE WITH N.F.P.A. #13 * OWNER SHALL PROVIDE ADEQUATE HEAT IN ALL AREAS ENCLOSING WET TYPE SPRINKLER PIPING TO PREVENT FREEZING AND FAILURE OF AUTOMATIC SPRINKLER SYSTEM. **DESIGN AREA #1** HYD. DESIGN CRITERIA

(NFPA 13R SPRINKLER SYS. WET)

LOCATION= KITCHEN / DINING / LIVING RM.

NO. OF SPRINKLERS= 4 MOST DEMANDING


HAZARD CLASSIFICATION: LIGHT


AREA OF OPERATION= 576 SQ. FT.

BASE OF RISER= 54.2-GPM 93.8-PSI

DENSITY= .05 GPM/SQ.FT.


HOSE DEMAND: 0 GPM

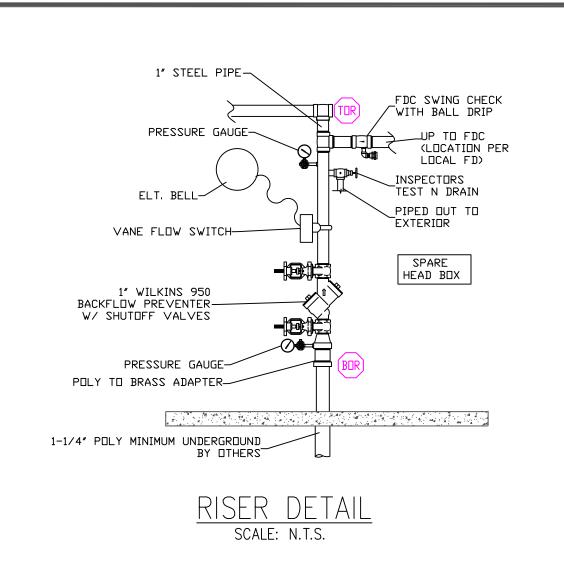


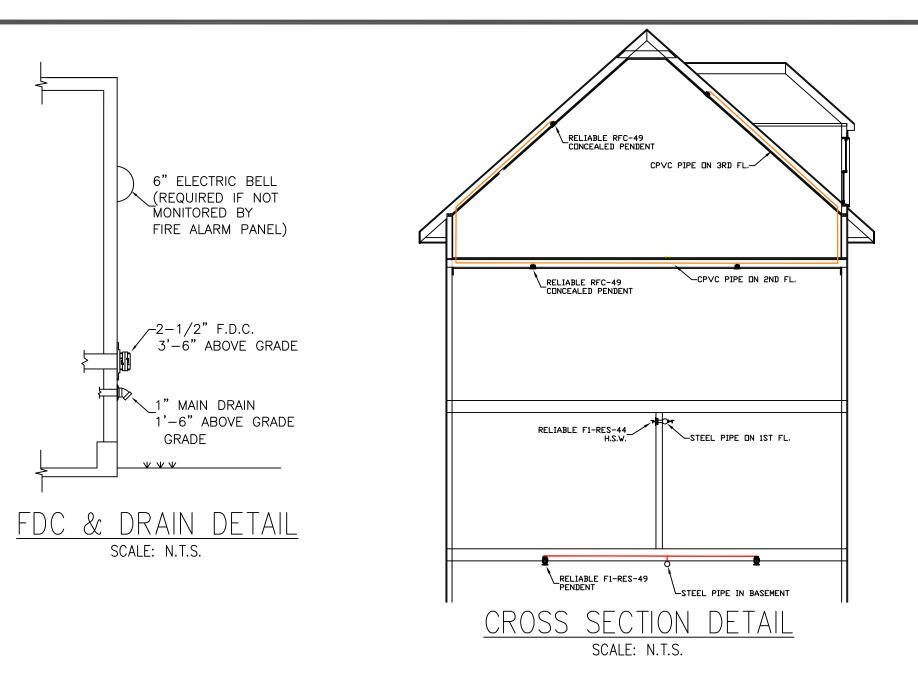






SCALE: N.T.S

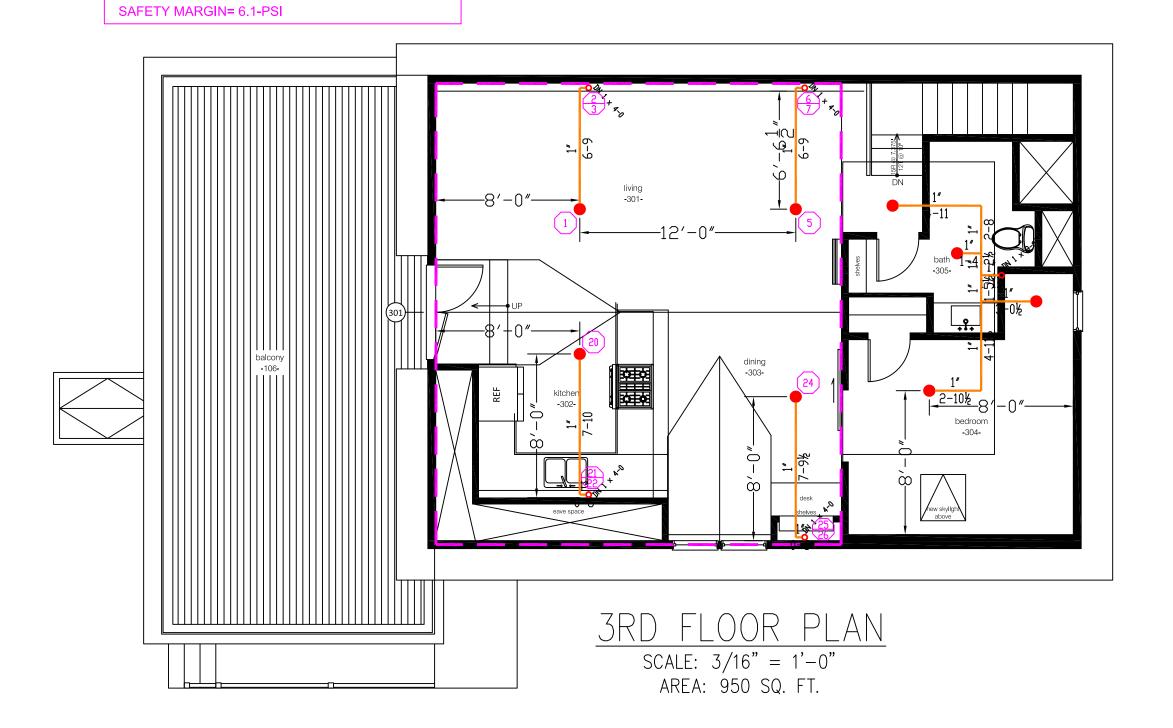

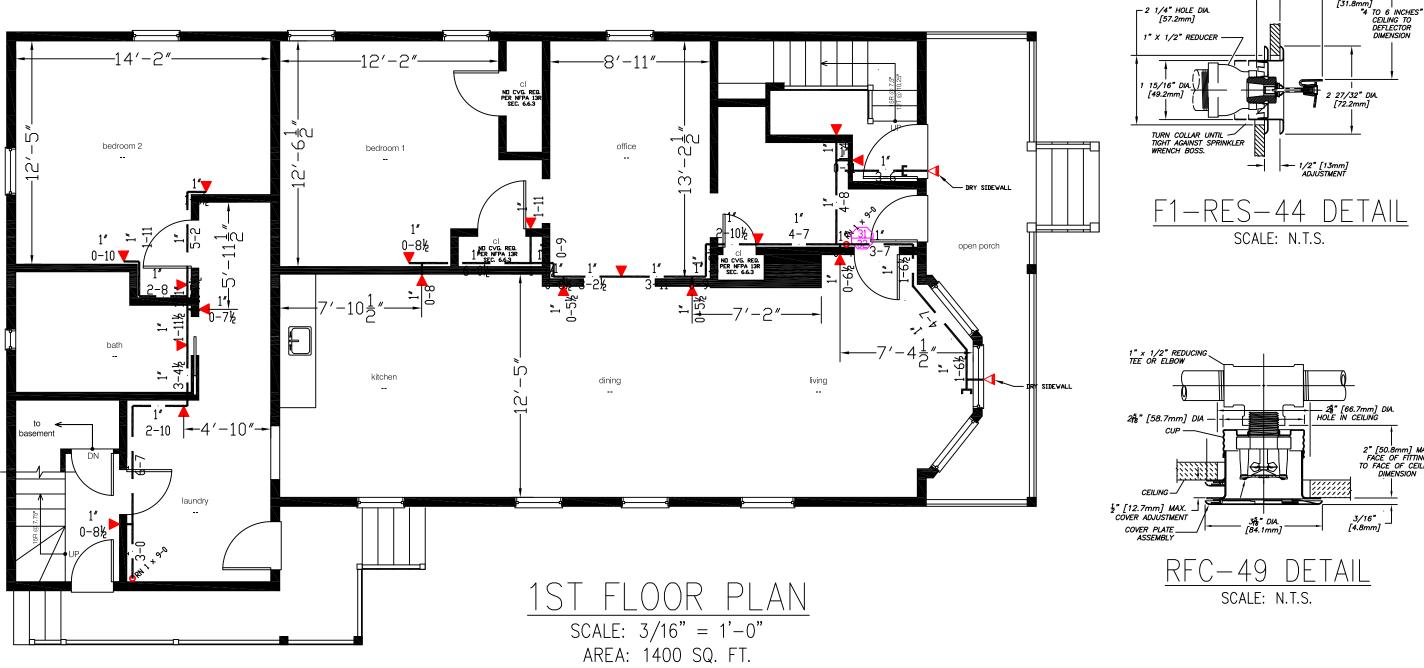

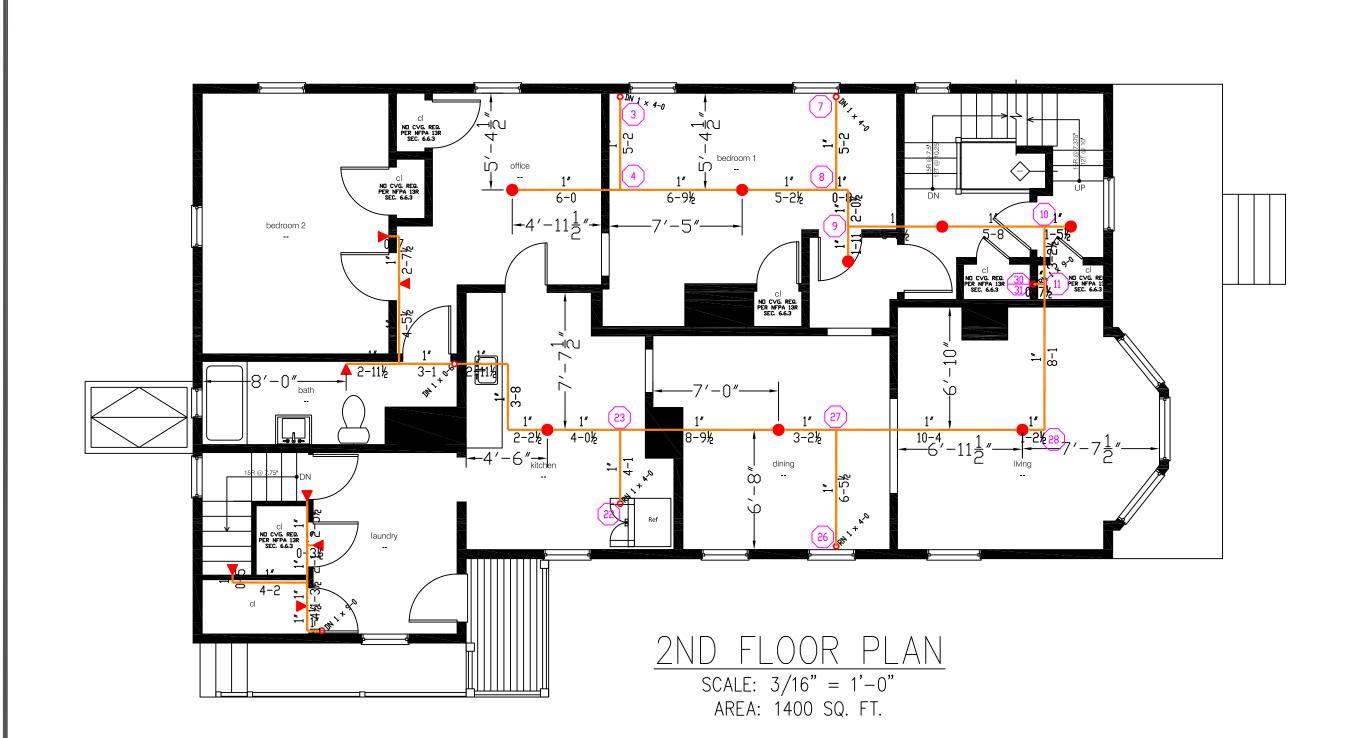

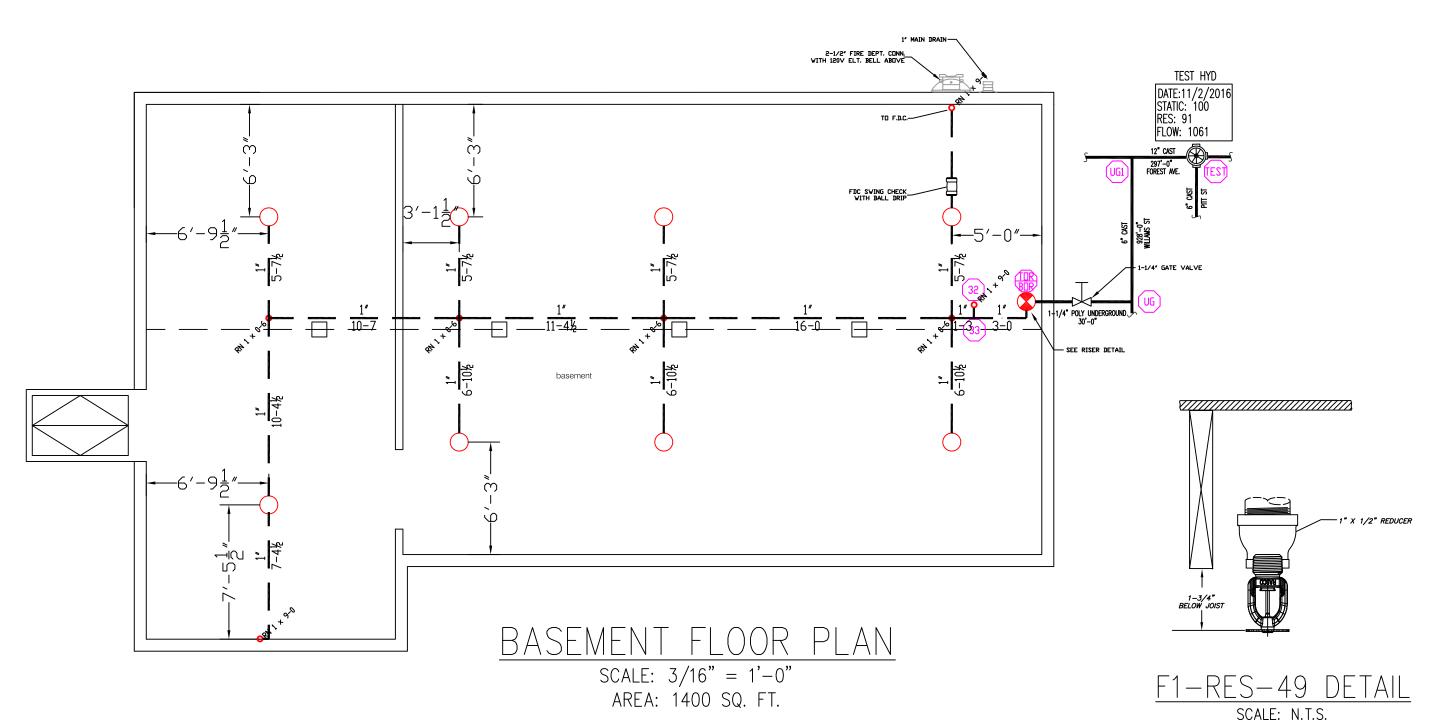

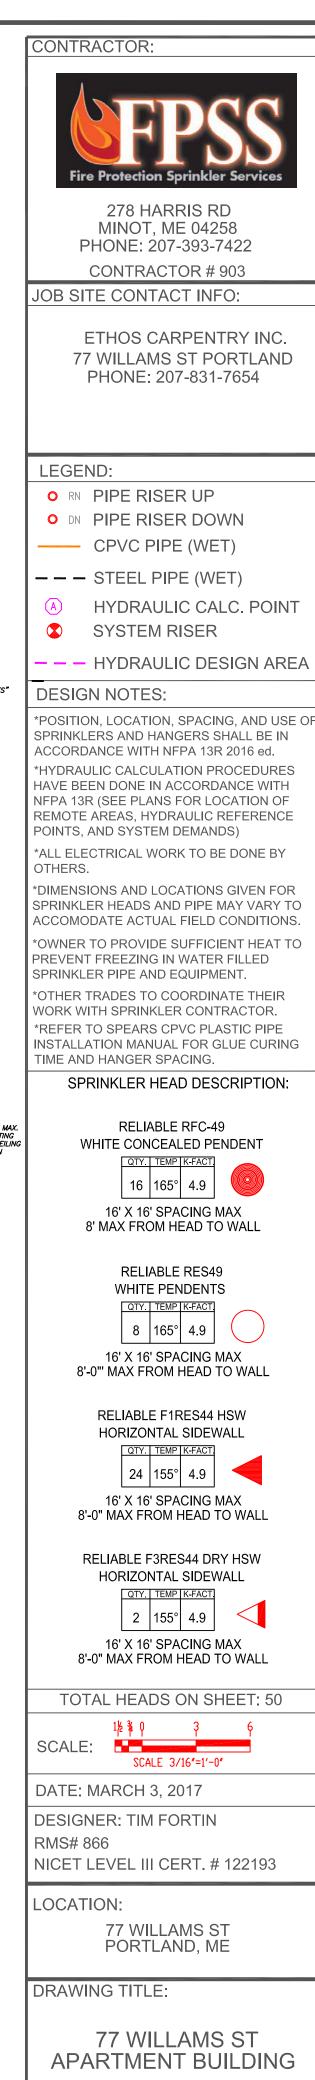

FIRE PROTECTION PLAN (NFPA 13R SPRINKLER SYS.)

DRAWING NO. 1 OF 1

DRAWING NO.: