PROJECT INFORMATION:

The fire protection project consists of installing a wet sprinkler system in this 4 unit apartment building that also has a mercantile space below on the ground floor. The mercantile space has its own entrance and has a fire barrier between the apartment

WATER SUPPLY:

This is a wet sprinkler system supplied by city water. A 4" underground water main will be brought into the building for the fire sprinkler sys. A 4" storz connection will be installed for use by the local fire dept.

CONSTRUCTION TYPE:

Construction type is "wood construction with gypsum wall board"

CODE REFERENCES:

NFPA 13 Wet Sprinkler System.

HOSE DEMAND: 0 GPM

SAFETY MARGIN= 32.9-PSI


NO. OF SPRINKLERS= 4 MOST DEMANDING

SYSTEM DEMAND (INCLUDING HOSE) @


BASE OF RISER= 54.2-GPM 67.0-PSI

SPRINKLER SYSTEM NOTES

- * DESIGN AND INSTALLATION SHALL CONFORM TO N.F.P.A. #13R (2016) & LOCAL FIRE AND BLDG. DEPTS.
- * HANGER INSTALLATION AND SPACING SHALL BE IN ACCORDANCE WITH N.F.P.A. #13 * FIELD FOREMAN TO VERIFY LOCATION OF HIGH TEMPERATURE SPRINKLERS
- AND INSTALL HIGH TEMPERATURE SPRINKLERS IN ACCORDANCE WITH N.F.P.A. #13
- * OWNER SHALL PROVIDE ADEQUATE HEAT IN ALL AREAS ENCLOSING WET TYPE SPRINKLER PIPING TO PREVENT FREEZING AND FAILURE OF AUTOMATIC SPRINKLER SYSTEM.

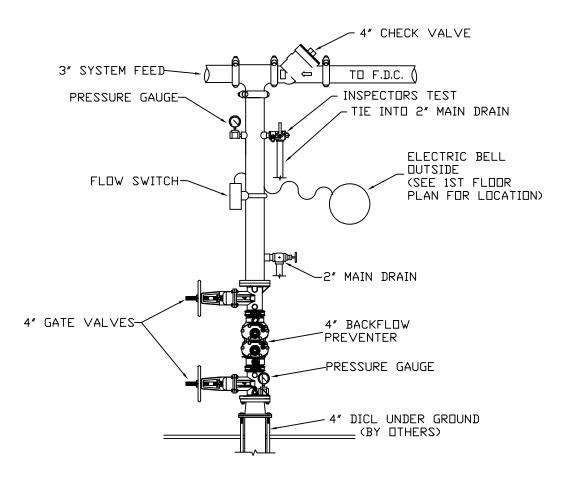


SCALE: N.T.S.

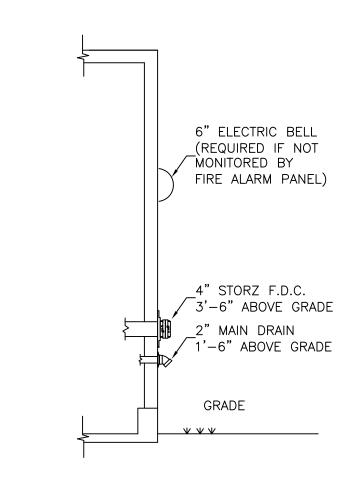

FDC & DRAIN DETAIL SCALE: N.T.S.



VIEW OF BLDG SCALE: N.T.S.

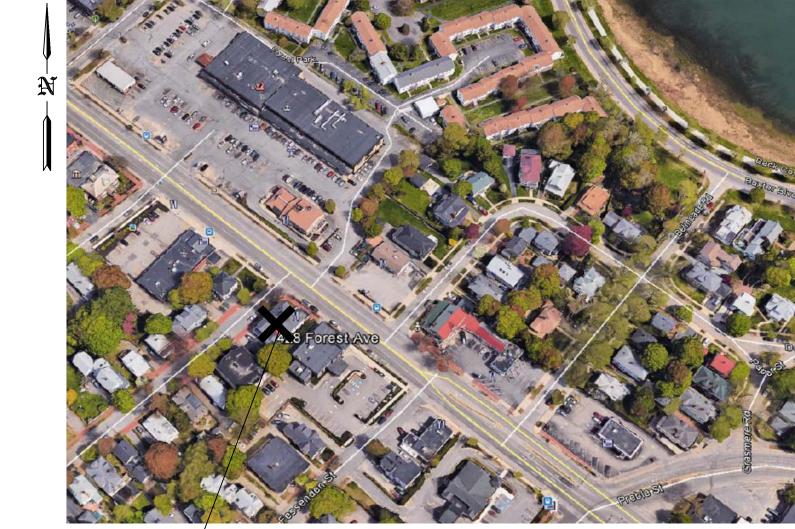

PROJECT SITE

19 200° 5.6 1/2" BRASS UPRIGHT EFLECTORS 1" TO 6" BELOW COMBUSTIBLE CEILINGS SCALE: N.T.S. 130' SPACING



D. DATE: DESCRIPTION


ECIAL APPLICATIONS:

PRINKLER HEAD DESCRIPTION

RELIABLE MODEL F1FR56

DESCRIPTION:



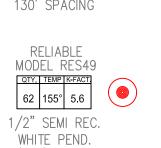

16'X16' SPACING

LEGEND:

Contractor:

SYSTEM RISER ORN PIPE RISER UP

ODN PIPE RISER DOWN

HYDRAULIC CALC. POINT

PROPOSED CPVC PIPING

PROPOSED STEEL PIPING ■ ■ ■ UNDERGROUND PIPING

Alternative Sprinkler Fire Protection 39 Jackson Rd. Poland Spring Me 04274 207-838-8930

428 FOREST AVE PORTLAND ME 04101

NFPA 13 SPRINKLER SYSTEM

Drawn by: TIMOTHY FORTIN

NICET LEVEL III CERT. # 12219

Local Fire Dept.

State Of Maine


428 FOREST AVE

PORTLAND ME 04101

RMS # 866

LOCATION:


Date: DEC 20, 2016

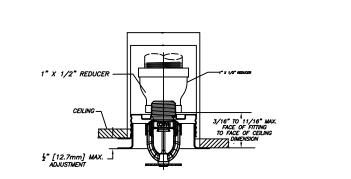


RES49 PENDENT DETAIL SCALE: N.T.S.

DESIGN AREA #2 HYD. DESIGN CRITERIA (NFPA 13 SPRINKLER SYS. WET) LOCATION= 2ND FL APT. UNIT HAZARD CLASSIFICATION: LIGHT DENSITY= .05 GPM/SQ.FT. AREA OF OPERATION= 442 SQ. FT.


F1FR56 PENDENT DETAIL SCALE: N.T.S.

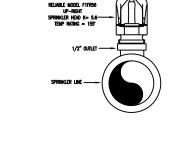


F1FR56 UPRIGHT DETAIL SCALE: N.T.S.

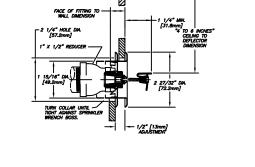



F1FR56 HSW DETAIL SCALE: N.T.S.

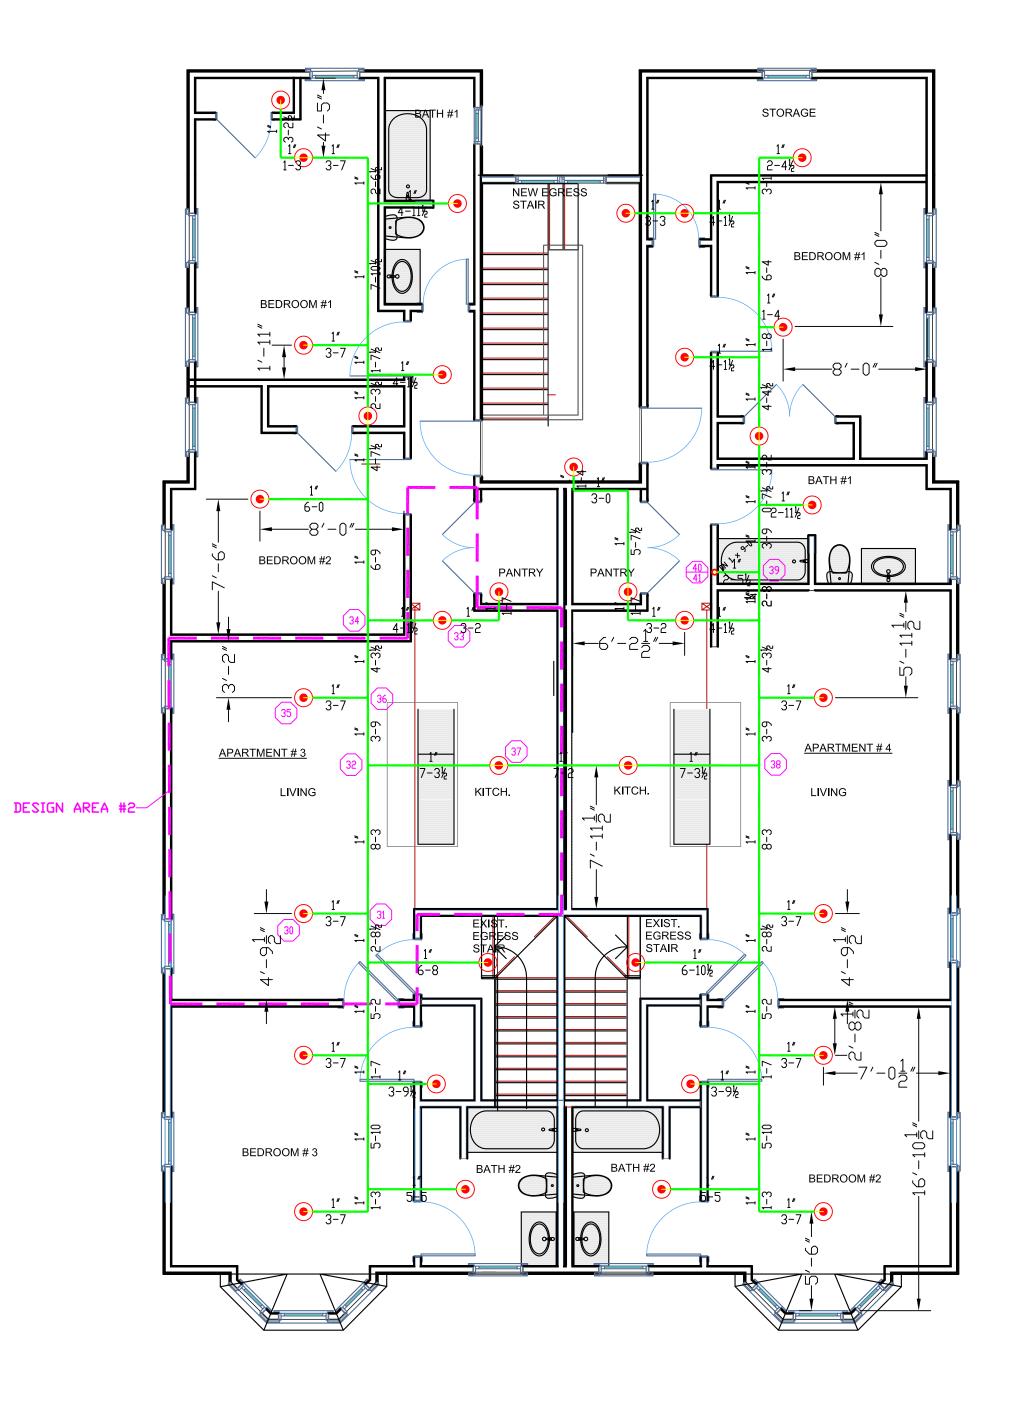

SECOND FLOOR PLAN TOTAL PROTECTED AREA 2,859 SQ.FT. SCALE 3/16" = 1'-0"

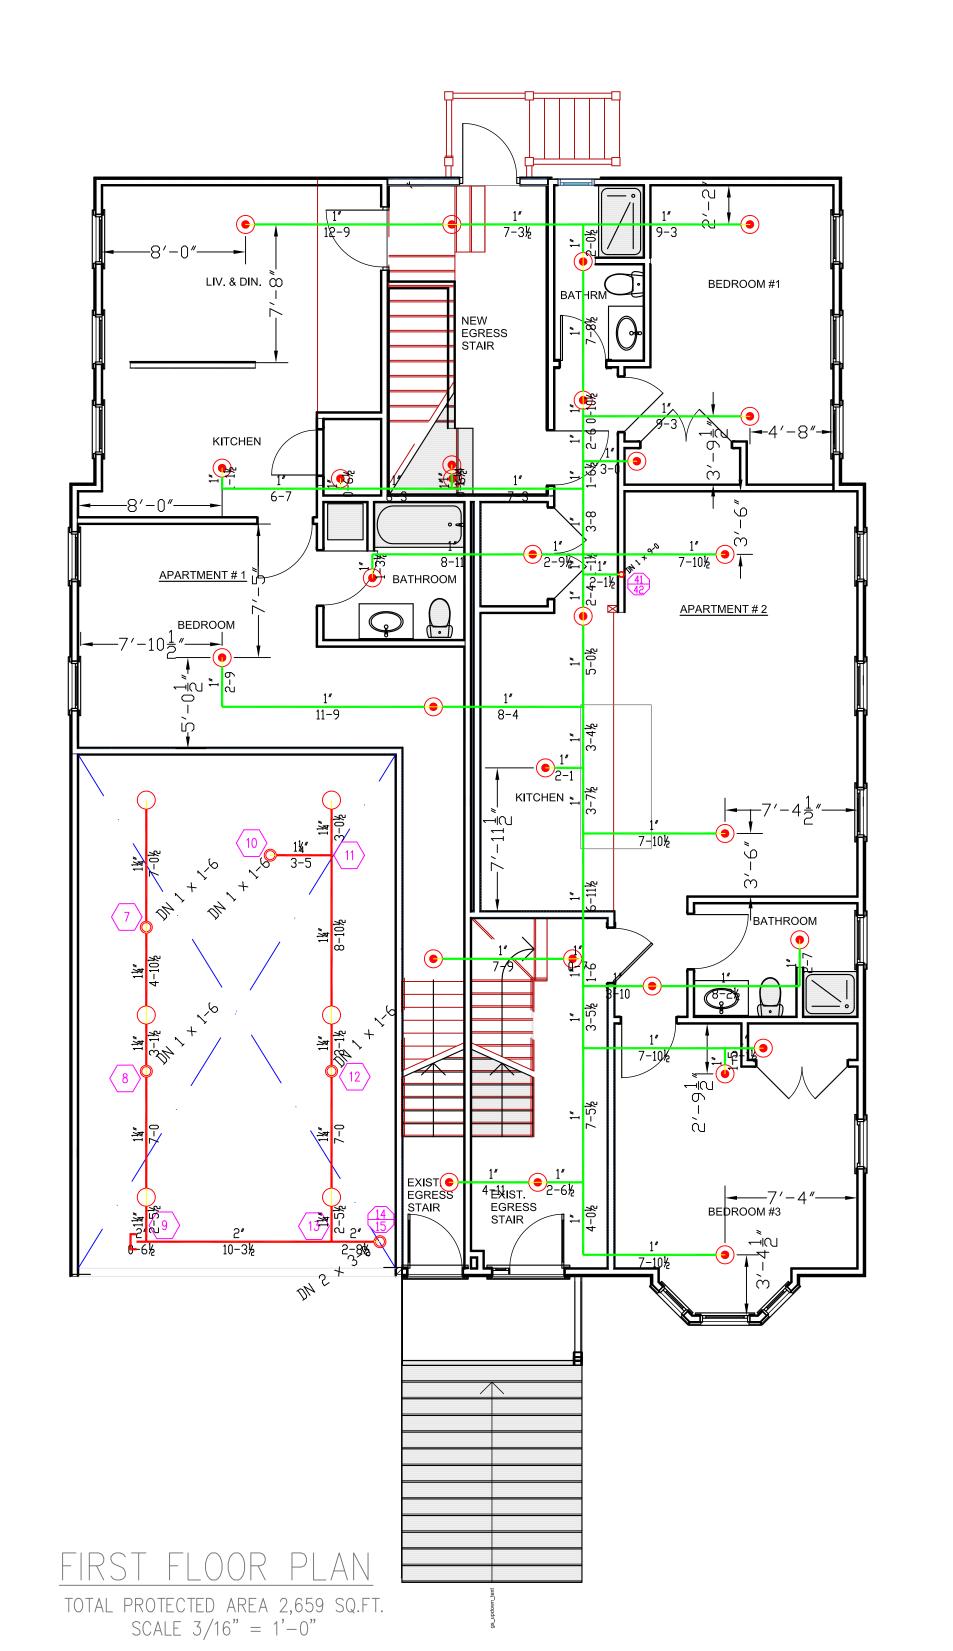

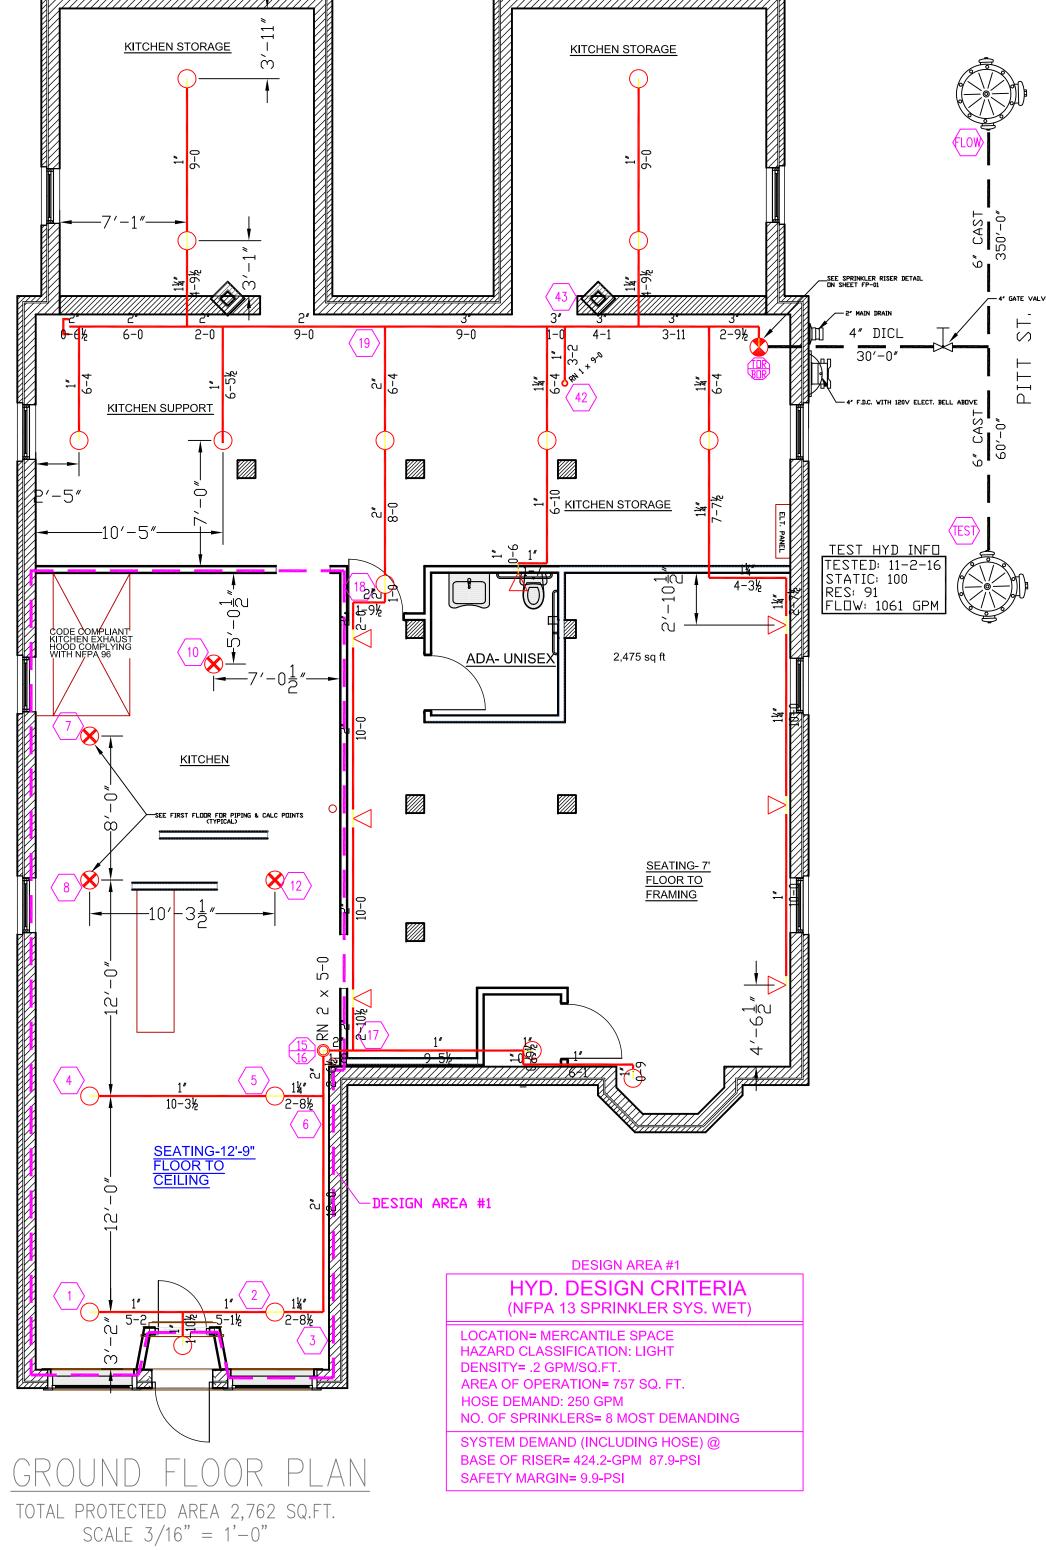

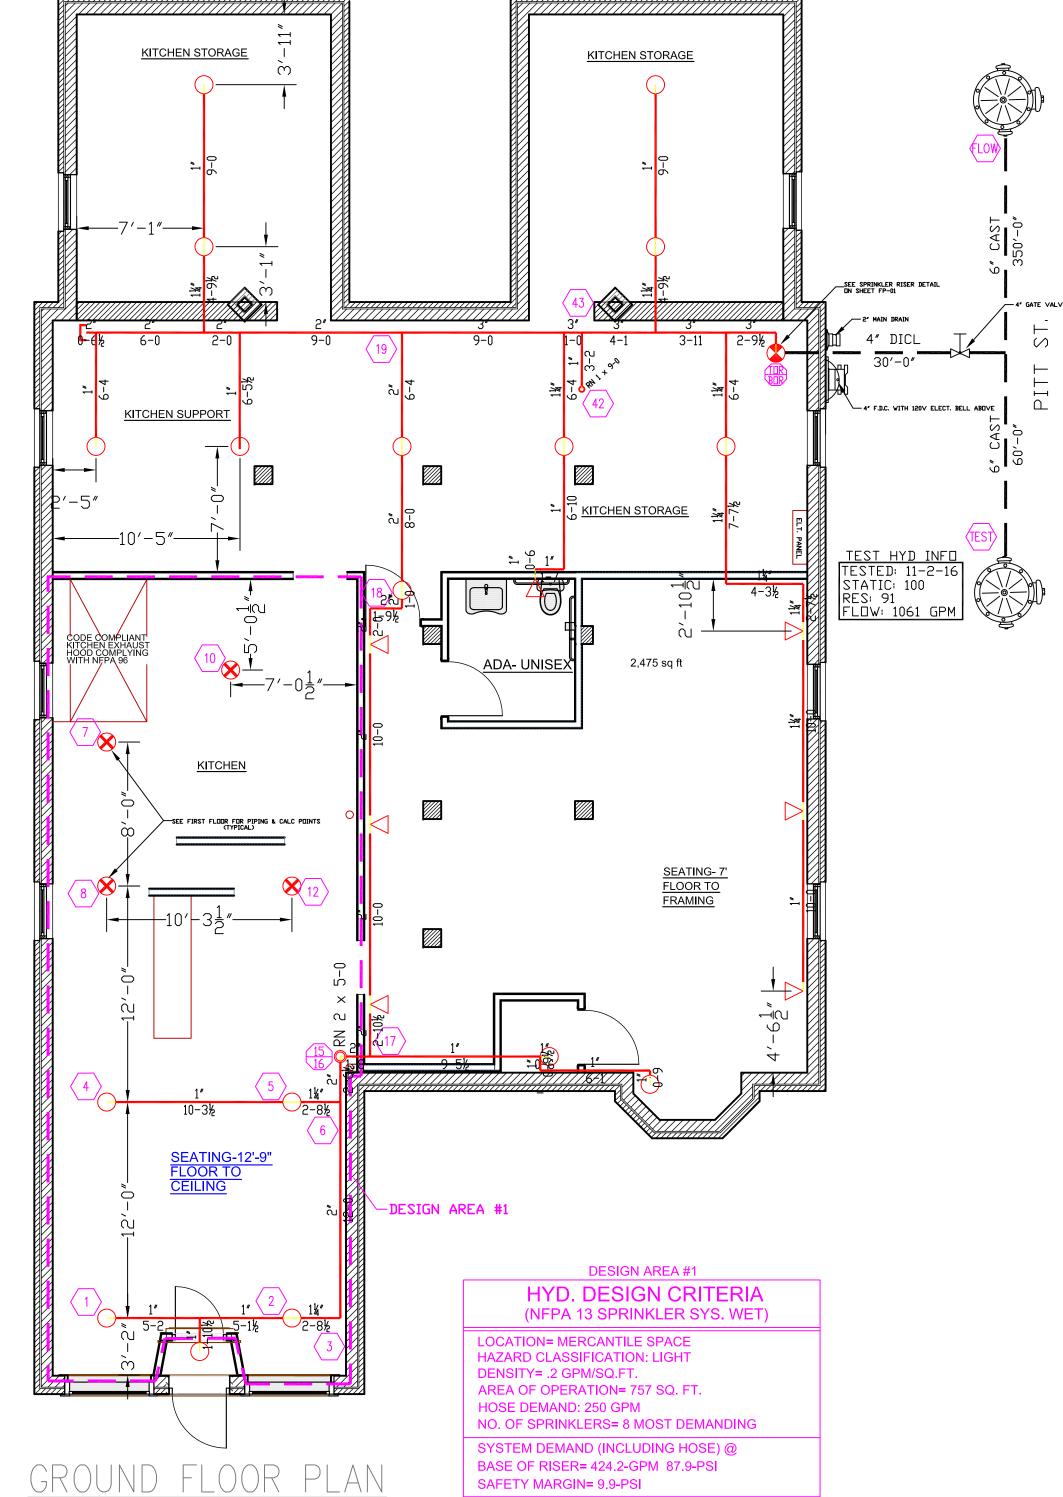

SHEET NUMBER

FP-01 1 OF 1

NOTE: USE OF THESE PLANS BY THE INSTALLING CONTRACTOR SHALL INDICATE ACCEPTANCE OF ALL THE INFORMATION PROVIDED ON THESE PLANS AND SHALL TRANSFER FINAL RESPONSIBILITY OF THE CORRECTOR'S EXPENSE.

NOTE: ADDITIONAL SPRINKLER HEADS OVER AND ABOVE THOSE SPECIFICALLY NOTED ON THESE DRAWINGS MAYBE REQUIRED COMPLIANT SYSTEM.