


PV SUPPORT FRAMING PLANS

SCALE: 1/8" = 1'-0"

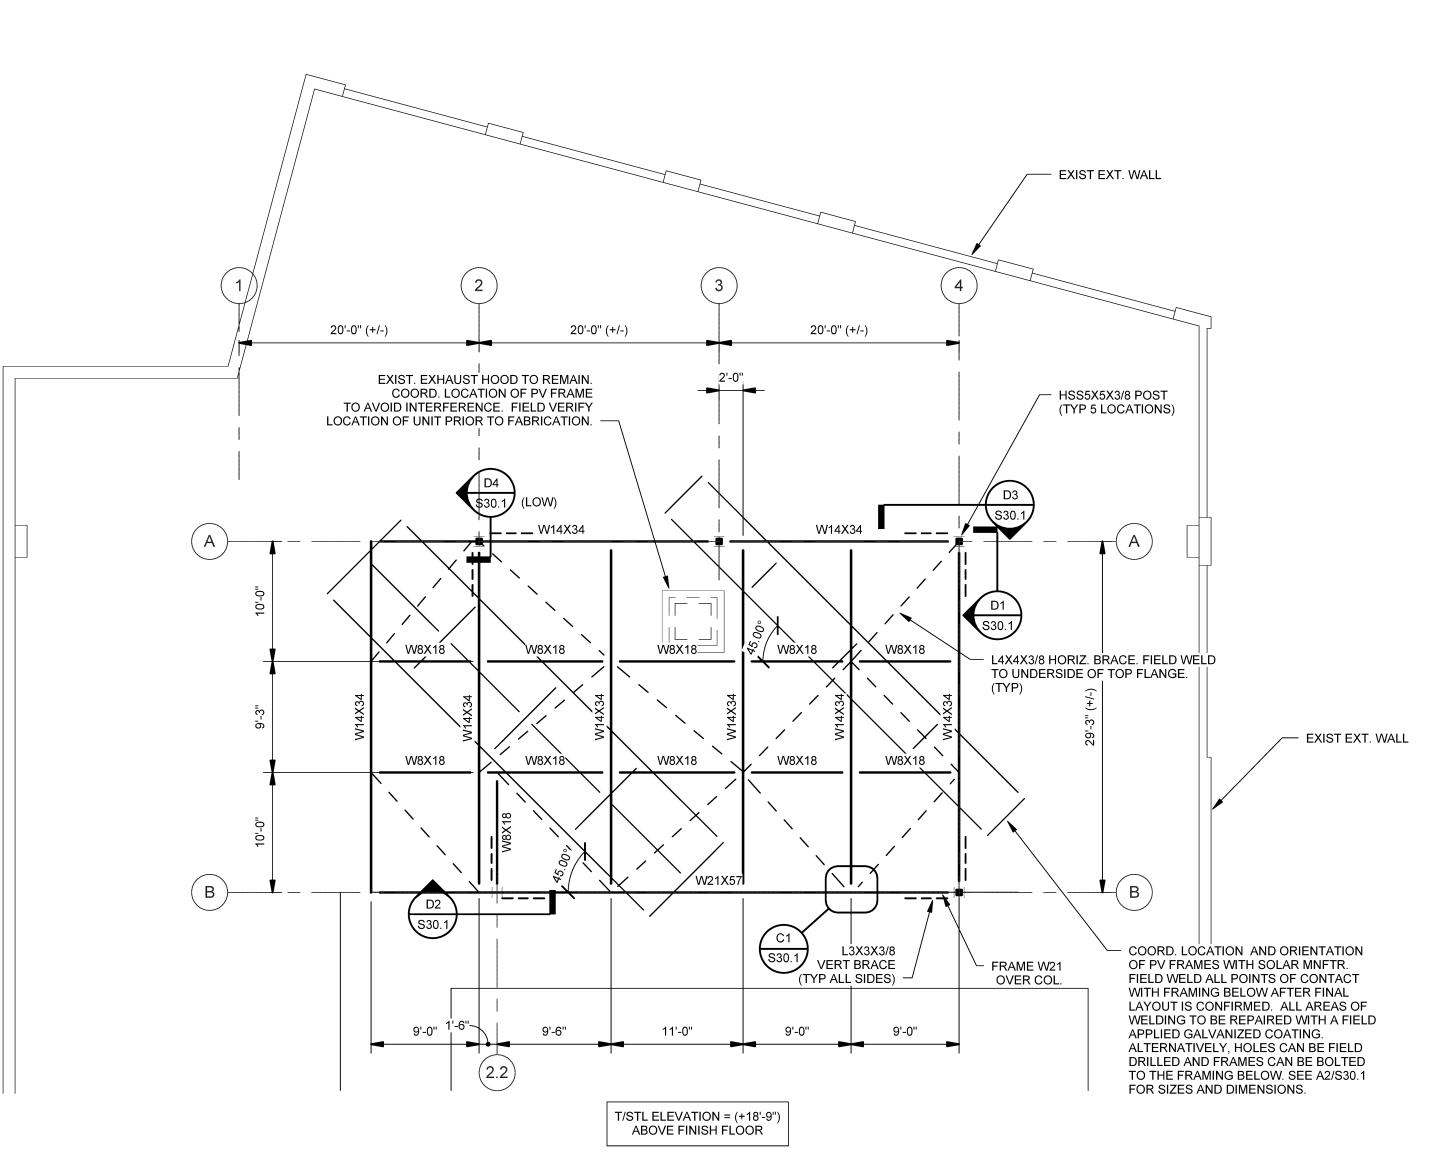

GRILLAGE FRAMING PLAN

SCALE: 1/8" = 1'-0"

HARRIMAN

**UNIVERSITY OF** SOUTHERN MAINE

AUBURN PORTLAND MANCHESTER

WOODBURY CAMPUS CENTER **EXTERIOR UPGRADES** 2014-011

PHASE II - PV ARRAY

PORTLAND, ME Harriman Project No.

## NOTES:

- 1. ALL STEEL BEAMS TO CONFORM WITH ASTM A992
- ALL HSS COLUMNS TO CONFORM WITH ASTM A500 GR. B (Fy=46 KSI)
- WITH ASTM A36 (Fy=36 KSI) 4. ALL STEEL MEMBERS AND CONNECTION
- MATERIAL TO BE GALVANIZED.
- 5. GC TO VERIFY ALL EXISTING DIMENSIONS AND ELEVATIONS PRIOR TO STEEL FABRICATION

3. ALL STEEL ANGLES AND PLATES TO CONFORM


- LENGTH AND WITH OF PV FRAMES SHALL BE COORDINATED WITH ACTUAL PANELS SELECTED 7. T/STL. ELEVATION IS BASED ON MAINTAINING 2' CLEAR TO THE UNDERSIDE OF THE DEEPEST BEAM (W21). VERIFY MINIMUM CLEARANCE PRIOR TO STEEL FABRICATION.
- 8. DESIGN OF SUB-FRAMES TO SUPPORT THE ACTUAL PV PANELS AT THE DESIRED ANGLE IS THE RESPONSIBILITY OF THE PANEL MNFTR.

**DESIGN WIND LOAD:** 

Issues and Revisions

BASIC WIND SPEED = 100 MPH (3 SEC GUST) IW = 1.15 (OCC. CAT. III) EXPOSURE CATEGORY = C INT. PRESSURE COEF. (GCPi) = +/- 0.18

Mark	Date	Description	
-	08-29-14	ISSUED FOR BID	

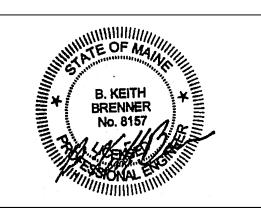

Drawing Scales As indicated	Audit No.	
	had has	
No. of the Control of	Name And	
PA / PE: BKB	© 2014 Harriman Associates	
Drawn By: ZPP		

**ROOF GRILLAGE** FRAMING PLAN AND **DETAILS** 

S30.1