


ELECTRICAL POWER PLAN

SCALE: 1/8" = 1'-0"

- ⊕ PLAN KEY NOTE:
1. PULLBOX DISCONNECT SWITCH FOR STORAGE ELECTRICAL MACHINE (S-E-1) SEE ELECTRICAL SCHEDULE FOR DETAILS. DISCONNECT TO BE MADE BY THE CONTRACTOR. DISCONNECT TO BE MADE BY THE CONTRACTOR. DISCONNECT TO BE MADE BY THE CONTRACTOR.
 2. REFER TO DRAWING T-207 FOR SECOND FLOOR & FINISH/USE POWER PLANS
 3. SEE DRAWING E-201 FOR BOON LEXCELER HEAT TRACE PLAN.
 4. REFER TO STRUCTURAL DRAWINGS FOR LOCATIONS OF BEAMS ABOVE THE CEILING. REFER TO ELECTRICAL SCHEDULE FOR SMALL VAMP CONDUIT ROUTES TO BE MADE BY THE CONTRACTOR. REFER TO ELECTRICAL SCHEDULE FOR BEAMS (BOTH WEB AND/OR FLANGE) IS EXPRESSLY PROHIBITED.

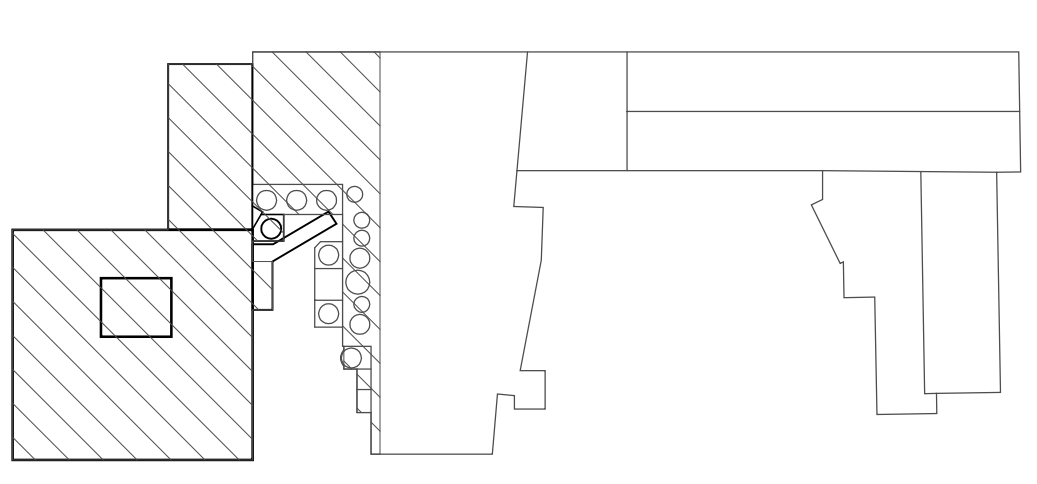

KEY PLAN

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REVISIONS	DATE	BY	REASON
0	08/29/03		ISSUED FOR BIDDING
1	07/21/03		ISSUED FOR OWNER REVIEW

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Do not scale drawing. Contractor shall verify all dimensions and conditions prior to construction. All dimensions shall be consistent with FACILITIES DESIGN, INC. drawings and specifications. All dimensions shall be consistent with FACILITIES DESIGN, INC. drawings and specifications. All dimensions shall be consistent with FACILITIES DESIGN, INC. drawings and specifications.

PROJECT NUMBER:	2003.1141.0
DESIGNED BY:	CEJL
DRAWN BY:	MAJL
CHECKED BY:	MDJ/MW/SLS
PROJECT:	

NEW MILK COOLER

Oakhurst DAIRY

364 FOREST AVENUE
 PORTLAND, MAINE 04101

PROJECT NUMBER: 2003.1141.0

DATE: AUGUST 29, 2003

DRAWING TITLE: FIRST FLOOR POWER PLAN

DRAWING NUMBER: E400

REVISION: 0