


OVERALL ROOF PLAN
SCALE: 1/8" = 1'-0"

ROOF INSULATION SCHEDULE

OVERALL THICKNESS	DESCRIPTION	TYPE
3"	TYPE 'A'	(2) LAYERS OF 1 1/2" POLYISOCYANURATE
6"	TYPE 'B'	(2) LAYERS OF 3" ENHANCED POLYSTYRENE WITH 7/8" COVER BOARD

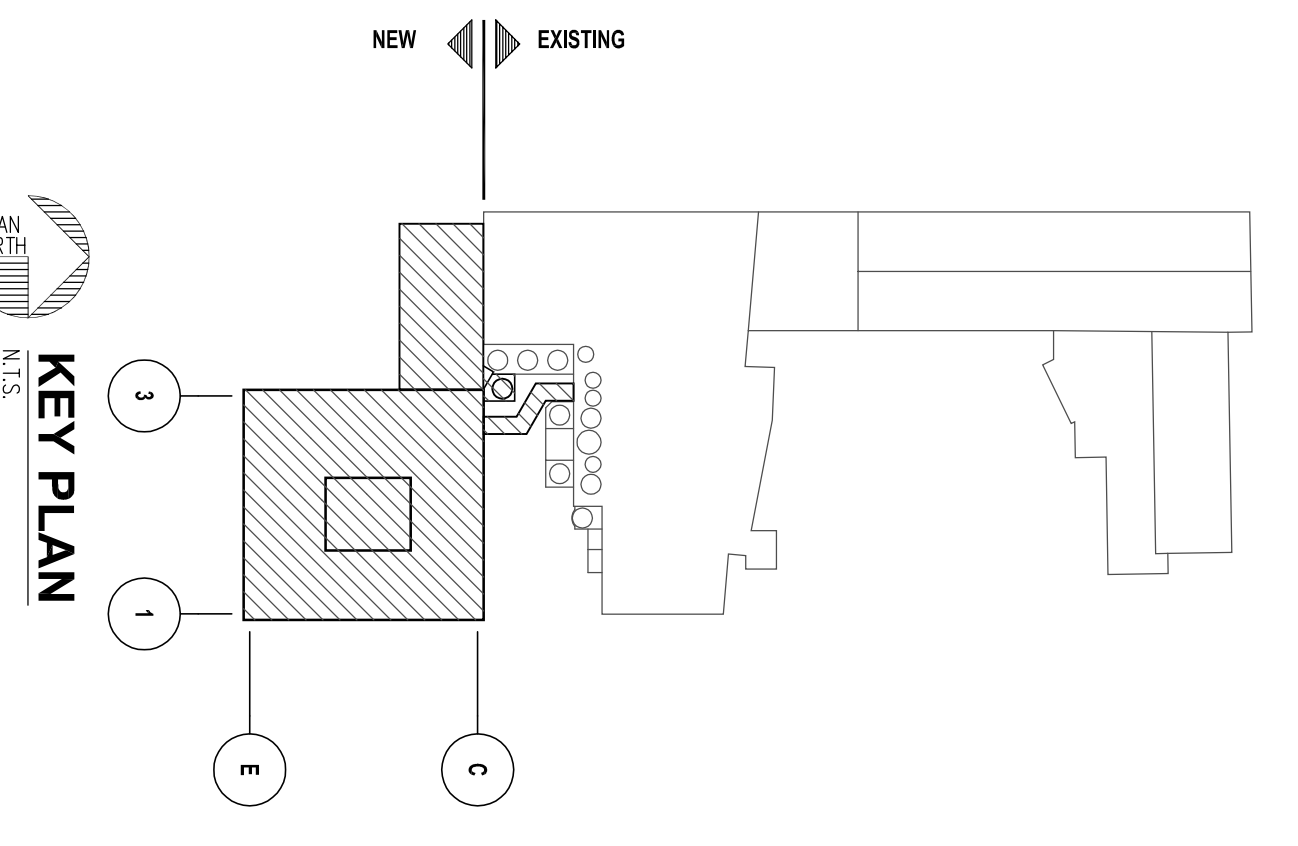

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- Wastewater Treatment

Project Services

- Project Planning
- Project Management
- Facility Relocation
- Facility Renovation
- Material Handling System Studies

REVISIONS

NO.	DATE	DESCRIPTION
0	3-01-04	ISSUED FOR BID

PROJECT INFORMATION

PROJECT: NEW MILK COOLER

DESIGNED BY: MSL

TRAINED BY: MSL

CHECKED BY: MSL

Oakhurst DAIRY

364 FOREST AVENUE
PORTLAND, MAINE 04101

PROJECT NUMBER: 0167.00

DATE: MARCH 1, 2004

DRAWING TITLE: OVERALL ROOF PLAN

DRAWING NUMBER: B102

REVISION: 0

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