


6/3/2013 9:58 AM I:\3801-3900\384210 USM FIRE ALARM SYSTEM UPGRADES\DESIGN\DWGS\BLDG\PAYSON SMITH FIRE ALARM UPGRADES\SHEETS\3842.12-FA103 THIRD FLOOR FIRE ALARM PLAN.DWG KYLE MAHAR

- TECHNICAL NOTES:**
- (1) APPROXIMATE LIMITS OF MECHANICAL MEZZANINE AND PLENUM SPACE ABOVE.
  - (2) LOCATE IN MECHANICAL MEZZANINE AND PLENUM SPACE.
  - (3) OBTAIN POWER FROM AVAILABLE 120V CIRCUIT WITHIN BOILER ROOM 024 OR POWER CLOSET 004A.

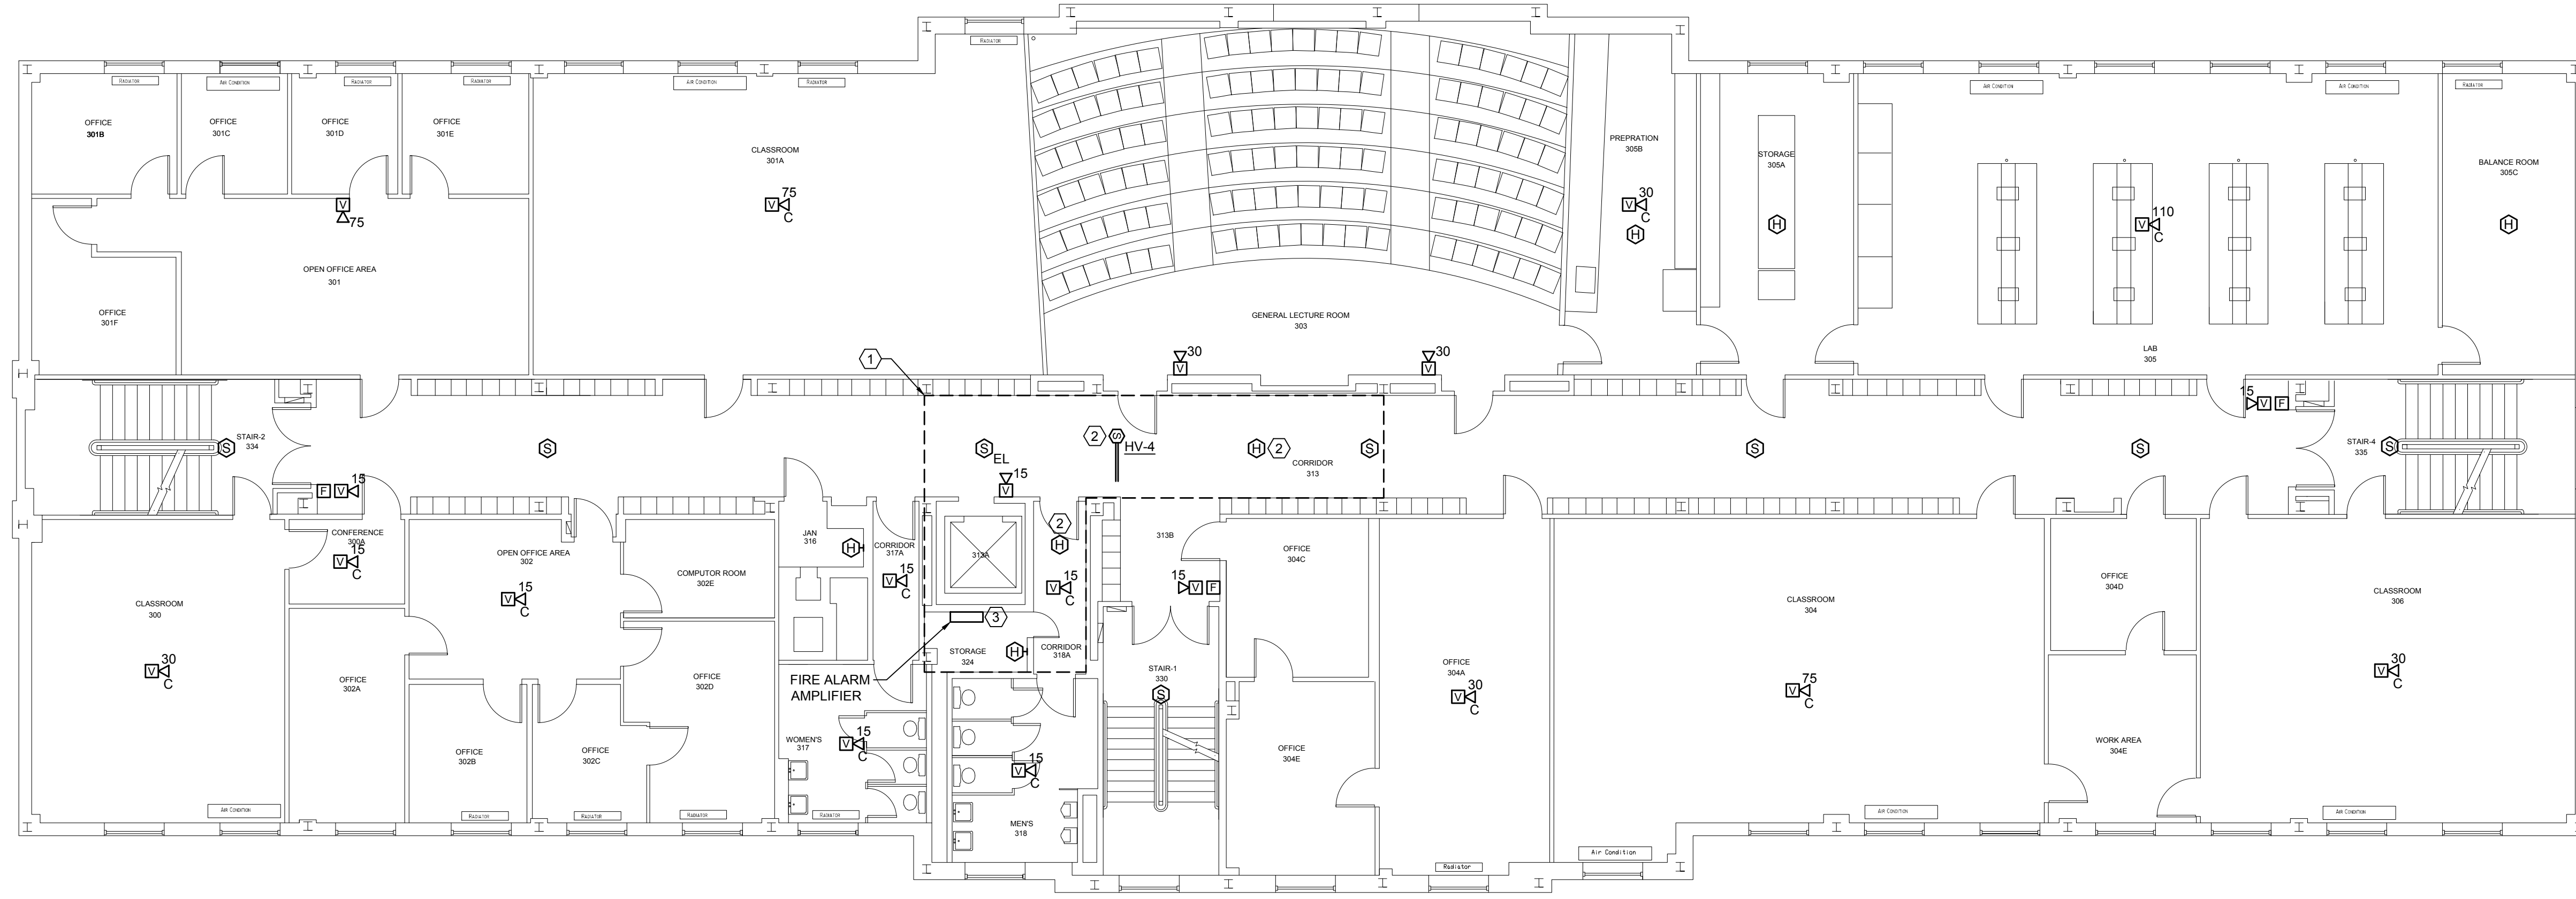

REV.	DESCRIPTION	DATE
0	CONSTRUCTION DOCUMENTS	05.10.13

**CONSTRUCTION DOCUMENTS**  
05.10.13

PROJECT NORTH

05.10.13

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**PAYSON SMITH FIRE ALARM UPGRADES**

PROJECT: PORTLAND, MAINE  
**THIRD FLOOR FIRE ALARM PLAN**

SHEET TITLE:	3842.12 - FA103
WBRC CAD FILE:	3842.12
PROJECT No.:	3842.12
SCALE:	AS NOTED
PM:	SJL
DRAWN BY:	KRM
A/E OF RECORD:	SJL
GRAPHIC SCALE:	0" = 1"
SHEET No.:	FA103

**A1**      **THIRD FLOOR FIRE ALARM PLAN**

1/8" = 1'-0"