


6/3/2013 10:08 AM I:\3801-3900\384210 USM FIRE ALARM SYSTEM UPGRADES\2 DESIGN\DWGS\BUDG\MASTERTON\_6P035\MASTERON\_HALL\_FIRE\_ALARM\_UPGRADE\3842.11-FA102 SECOND FLOOR FIRE ALARM PLAN.DWG KYLE MAHAR

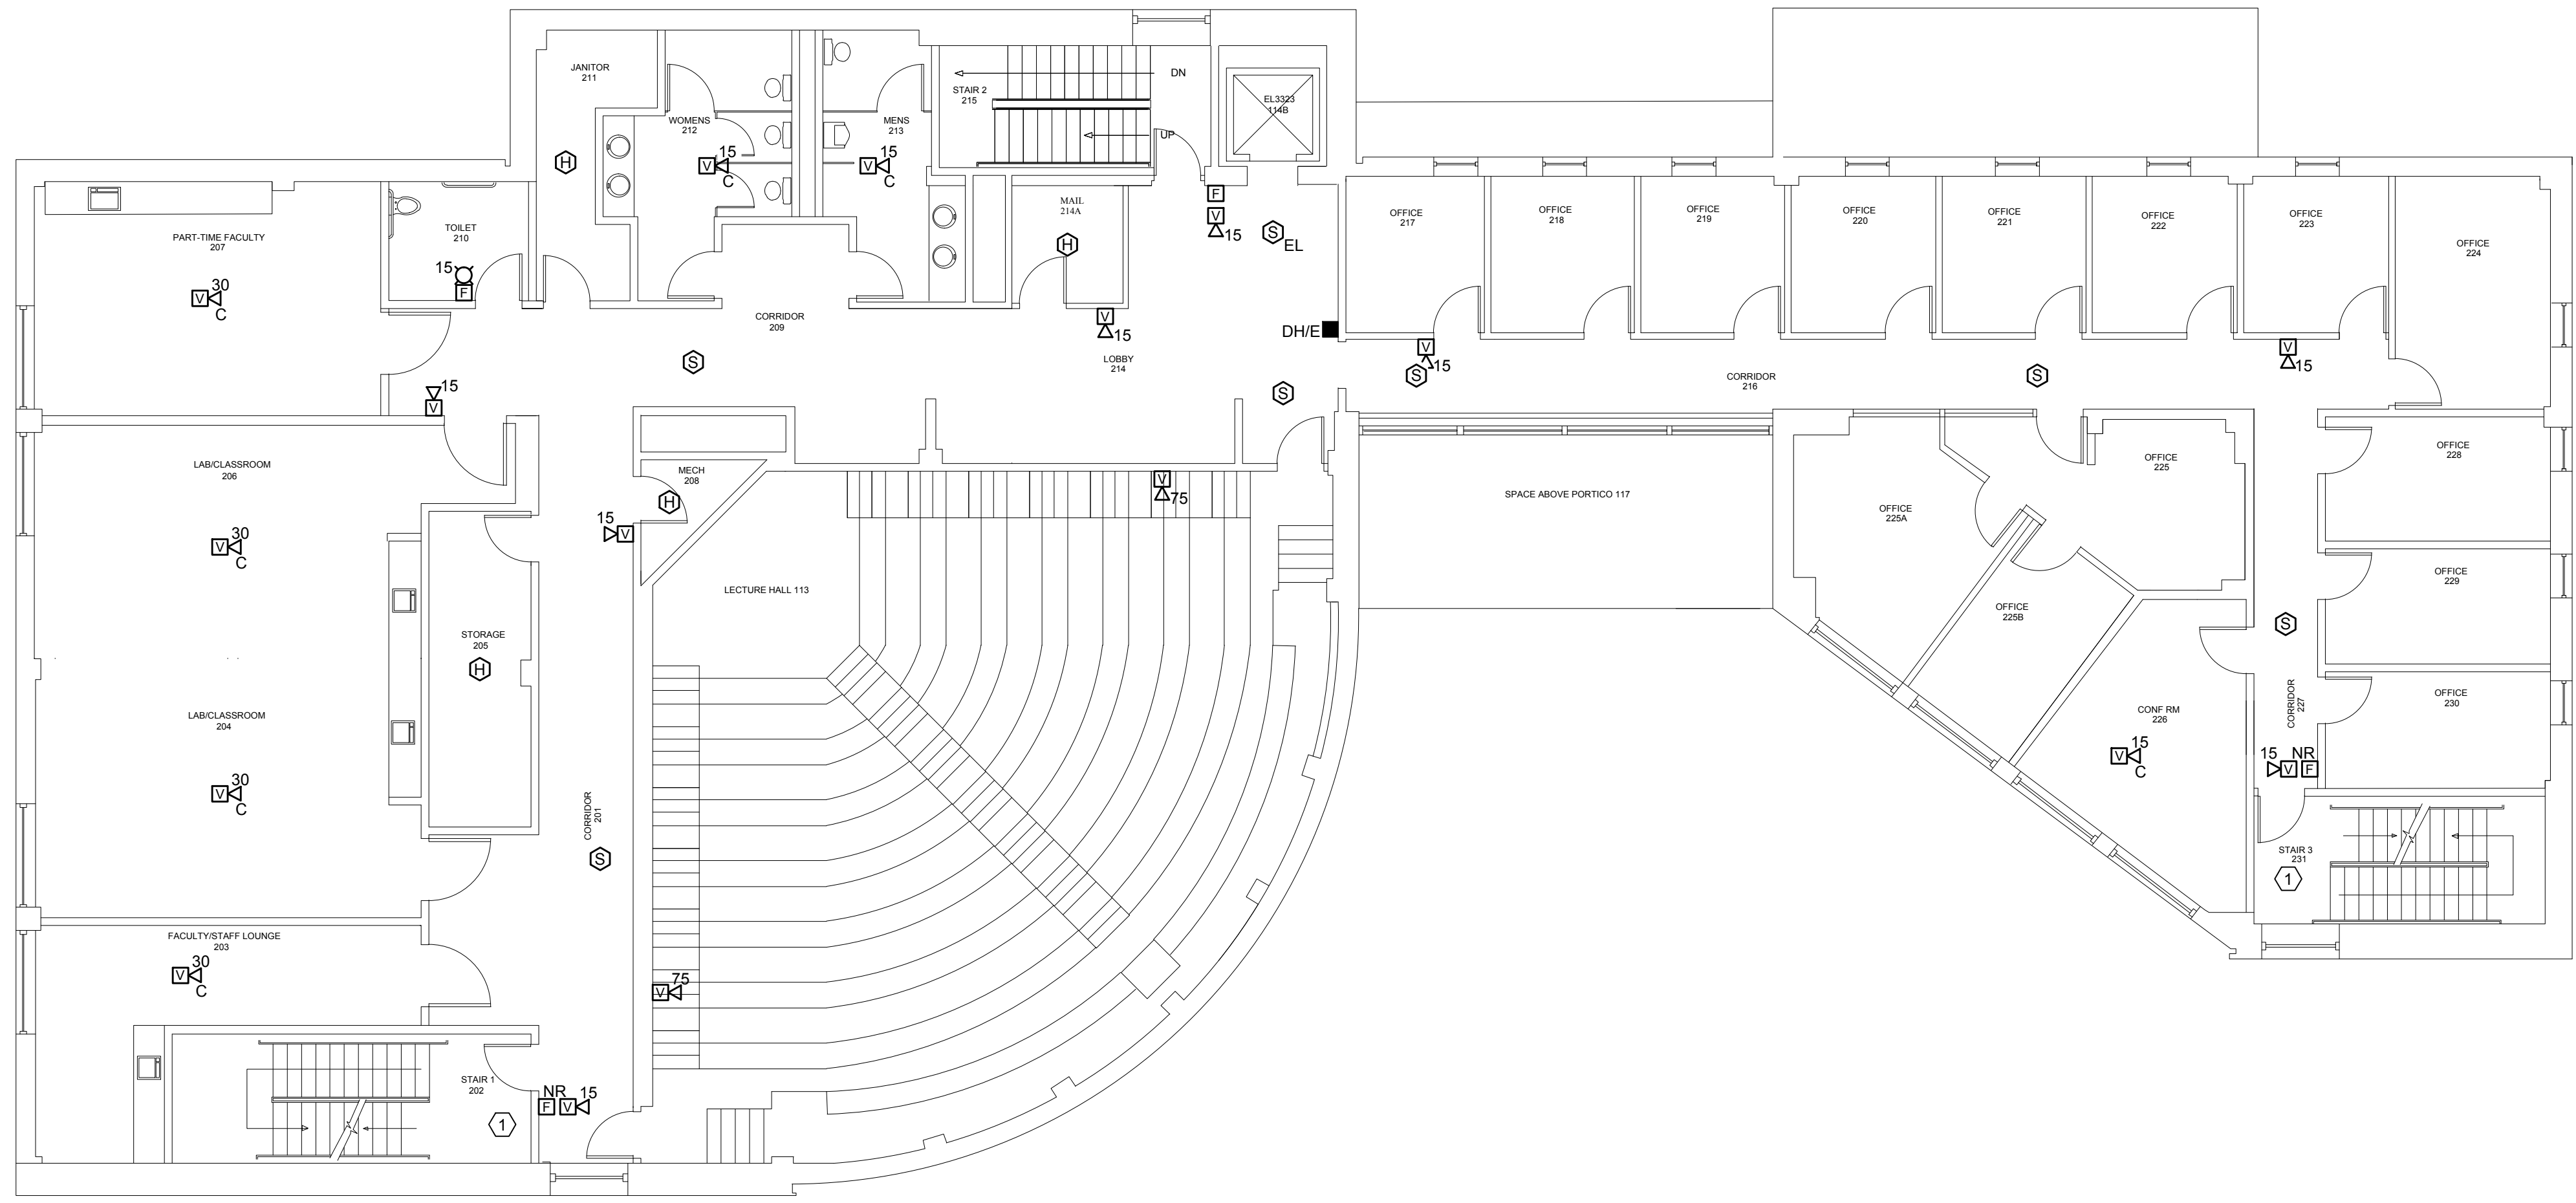

**TECHNICAL NOTES:**  
 ① MAINTAIN EXISTING FLOW AND TAMPER SWITCHES AND OTHER SPRINKLER SYSTEM DEVICE CONNECTIONS.

0	CONSTRUCTION DOCUMENTS	05.10.13
REV.	DESCRIPTION	DATE

**CONSTRUCTION DOCUMENTS**  
05.10.13

CURRENT ISSUE STATUS:

PROJECT NORTH

STATE OF MAINE  
STEPHANIE LAPLANT  
No. 10272  
LICENSED PROFESSIONAL ENGINEER

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**MASTERTON HALL FIRE ALARM UPGRADE**

PROJECT: PORTLAND, MAINE

**SECOND FLOOR FIRE ALARM PLAN**

WBRC CAD FILE:	3842.11 - FA102
PROJECT No.	3842.11
SCALE:	AS NOTED
PM:	SJL
DRAWN BY:	KRM
A/E OF RECORD:	SJL

FA102

**A1**      **SECOND FLOOR FIRE ALARM PLAN**

1/8" = 1'-0"