


6/3/2013 10:08 AM I:\3801-3900\384210 USM FIRE ALARM SYSTEM UPGRADES\2 DESIGN DWGS\BUDG\MASTERON 6P035\MASTERON HALL FIRE ALARM UPGRADE\3842.11-FA101 FIRST FLOOR FIRE ALARM PLAN.DWG KYLE MAHAR

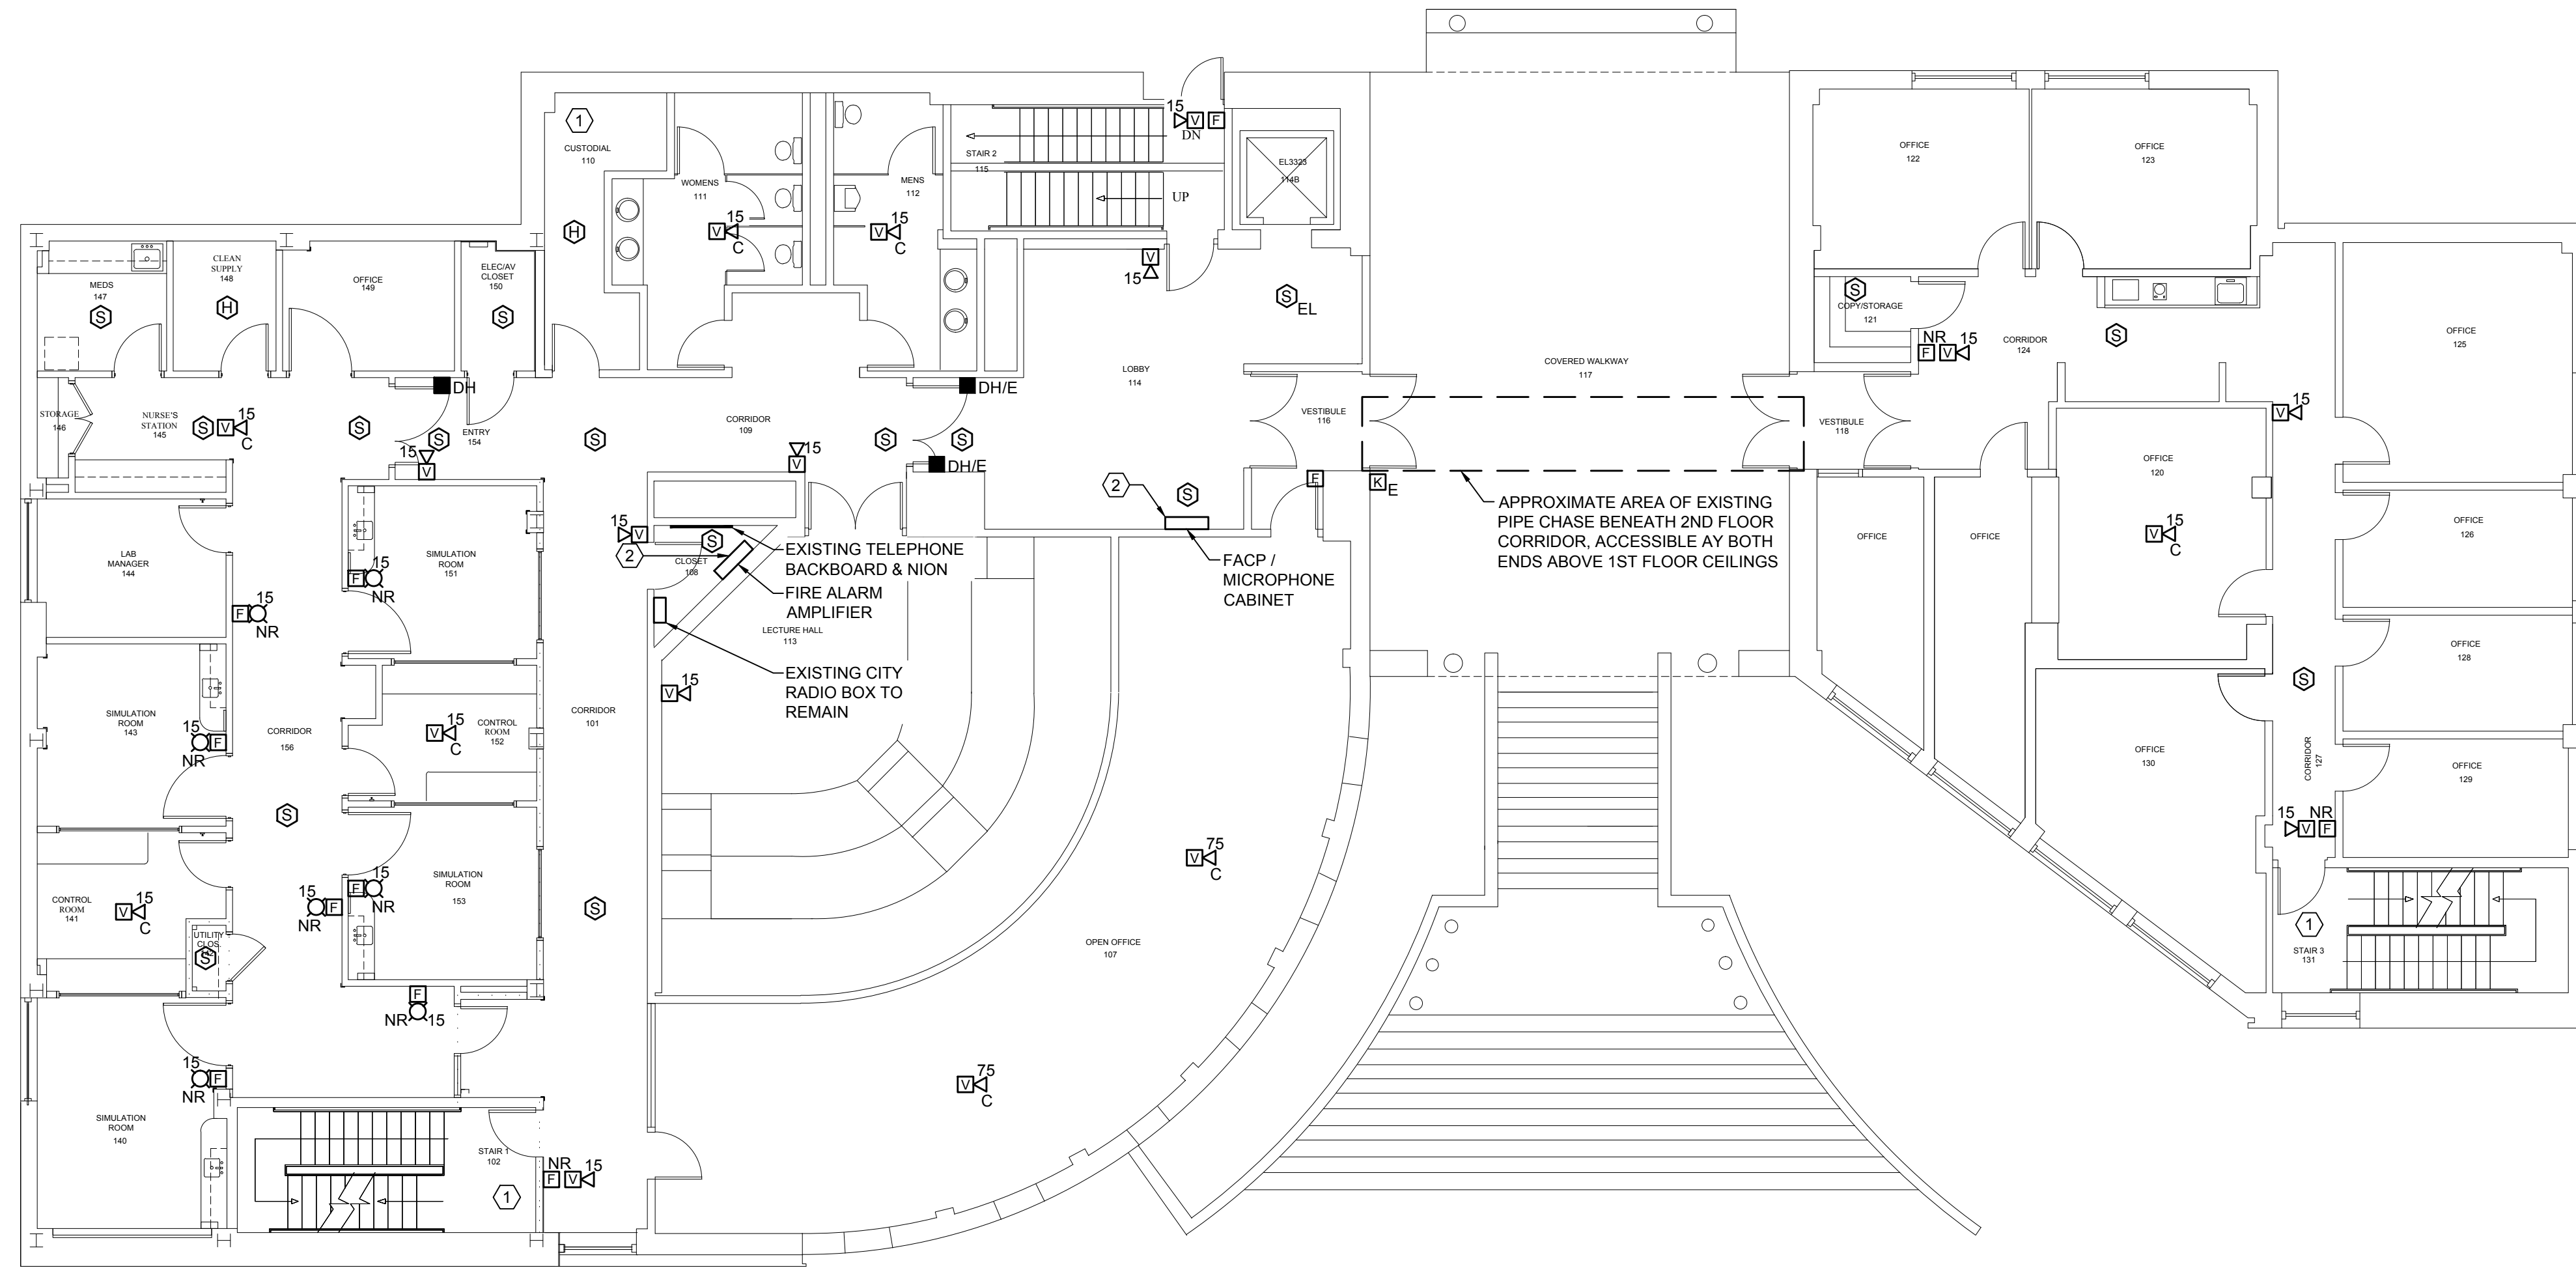

TECHNICAL NOTES:

- ① MAINTAIN EXISTING FLOW AND TAMPER SWITCHES AND OTHER SPRINKLER SYSTEM DEVICE CONNECTIONS.
- ② OBTAIN POWER FROM AVAILABLE 120V CIRCUIT WITHIN ELEC/AV CLOSET 150.

REV.	DESCRIPTION	DATE
0	CONSTRUCTION DOCUMENTS	05.10.13

CONSTRUCTION DOCUMENTS
05.10.13

CURRENT ISSUE STATUS:

PROJECT NORTH

STATE OF MAINE
STEPHANIE L. LAPLANT
No. 10272
LICENSED PROFESSIONAL ENGINEER

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MASTERON HALL FIRE ALARM UPGRADE

PROJECT: PORTLAND, MAINE

FIRST FLOOR FIRE ALARM PLAN

WBRC CAD FILE:	3842.11 - FA101
PROJECT No.	3842.11
SCALE:	AS NOTED
PM:	SJL
DRAWN BY:	KRM
A/E OF RECORD:	SJL

GRAPHIC SCALE: 1" = 10'
SHEET No. **FA101**

A1 **FIRST FLOOR FIRE ALARM PLAN**

1/8" = 1'-0"