


6/3/2013 9:42 AM I:\3801-3900\384210 USM FIRE ALARM SYSTEM UPGRADES\DESIGN\DWGS\BLDG\LUTHER BONNEY BLDG\LUTHER FIRE ALARM UPGRADES\SHEETS\FA101 - FIRST FLOOR FIRE ALARM PLAN - SEG A.DWG KYLE MAHAR

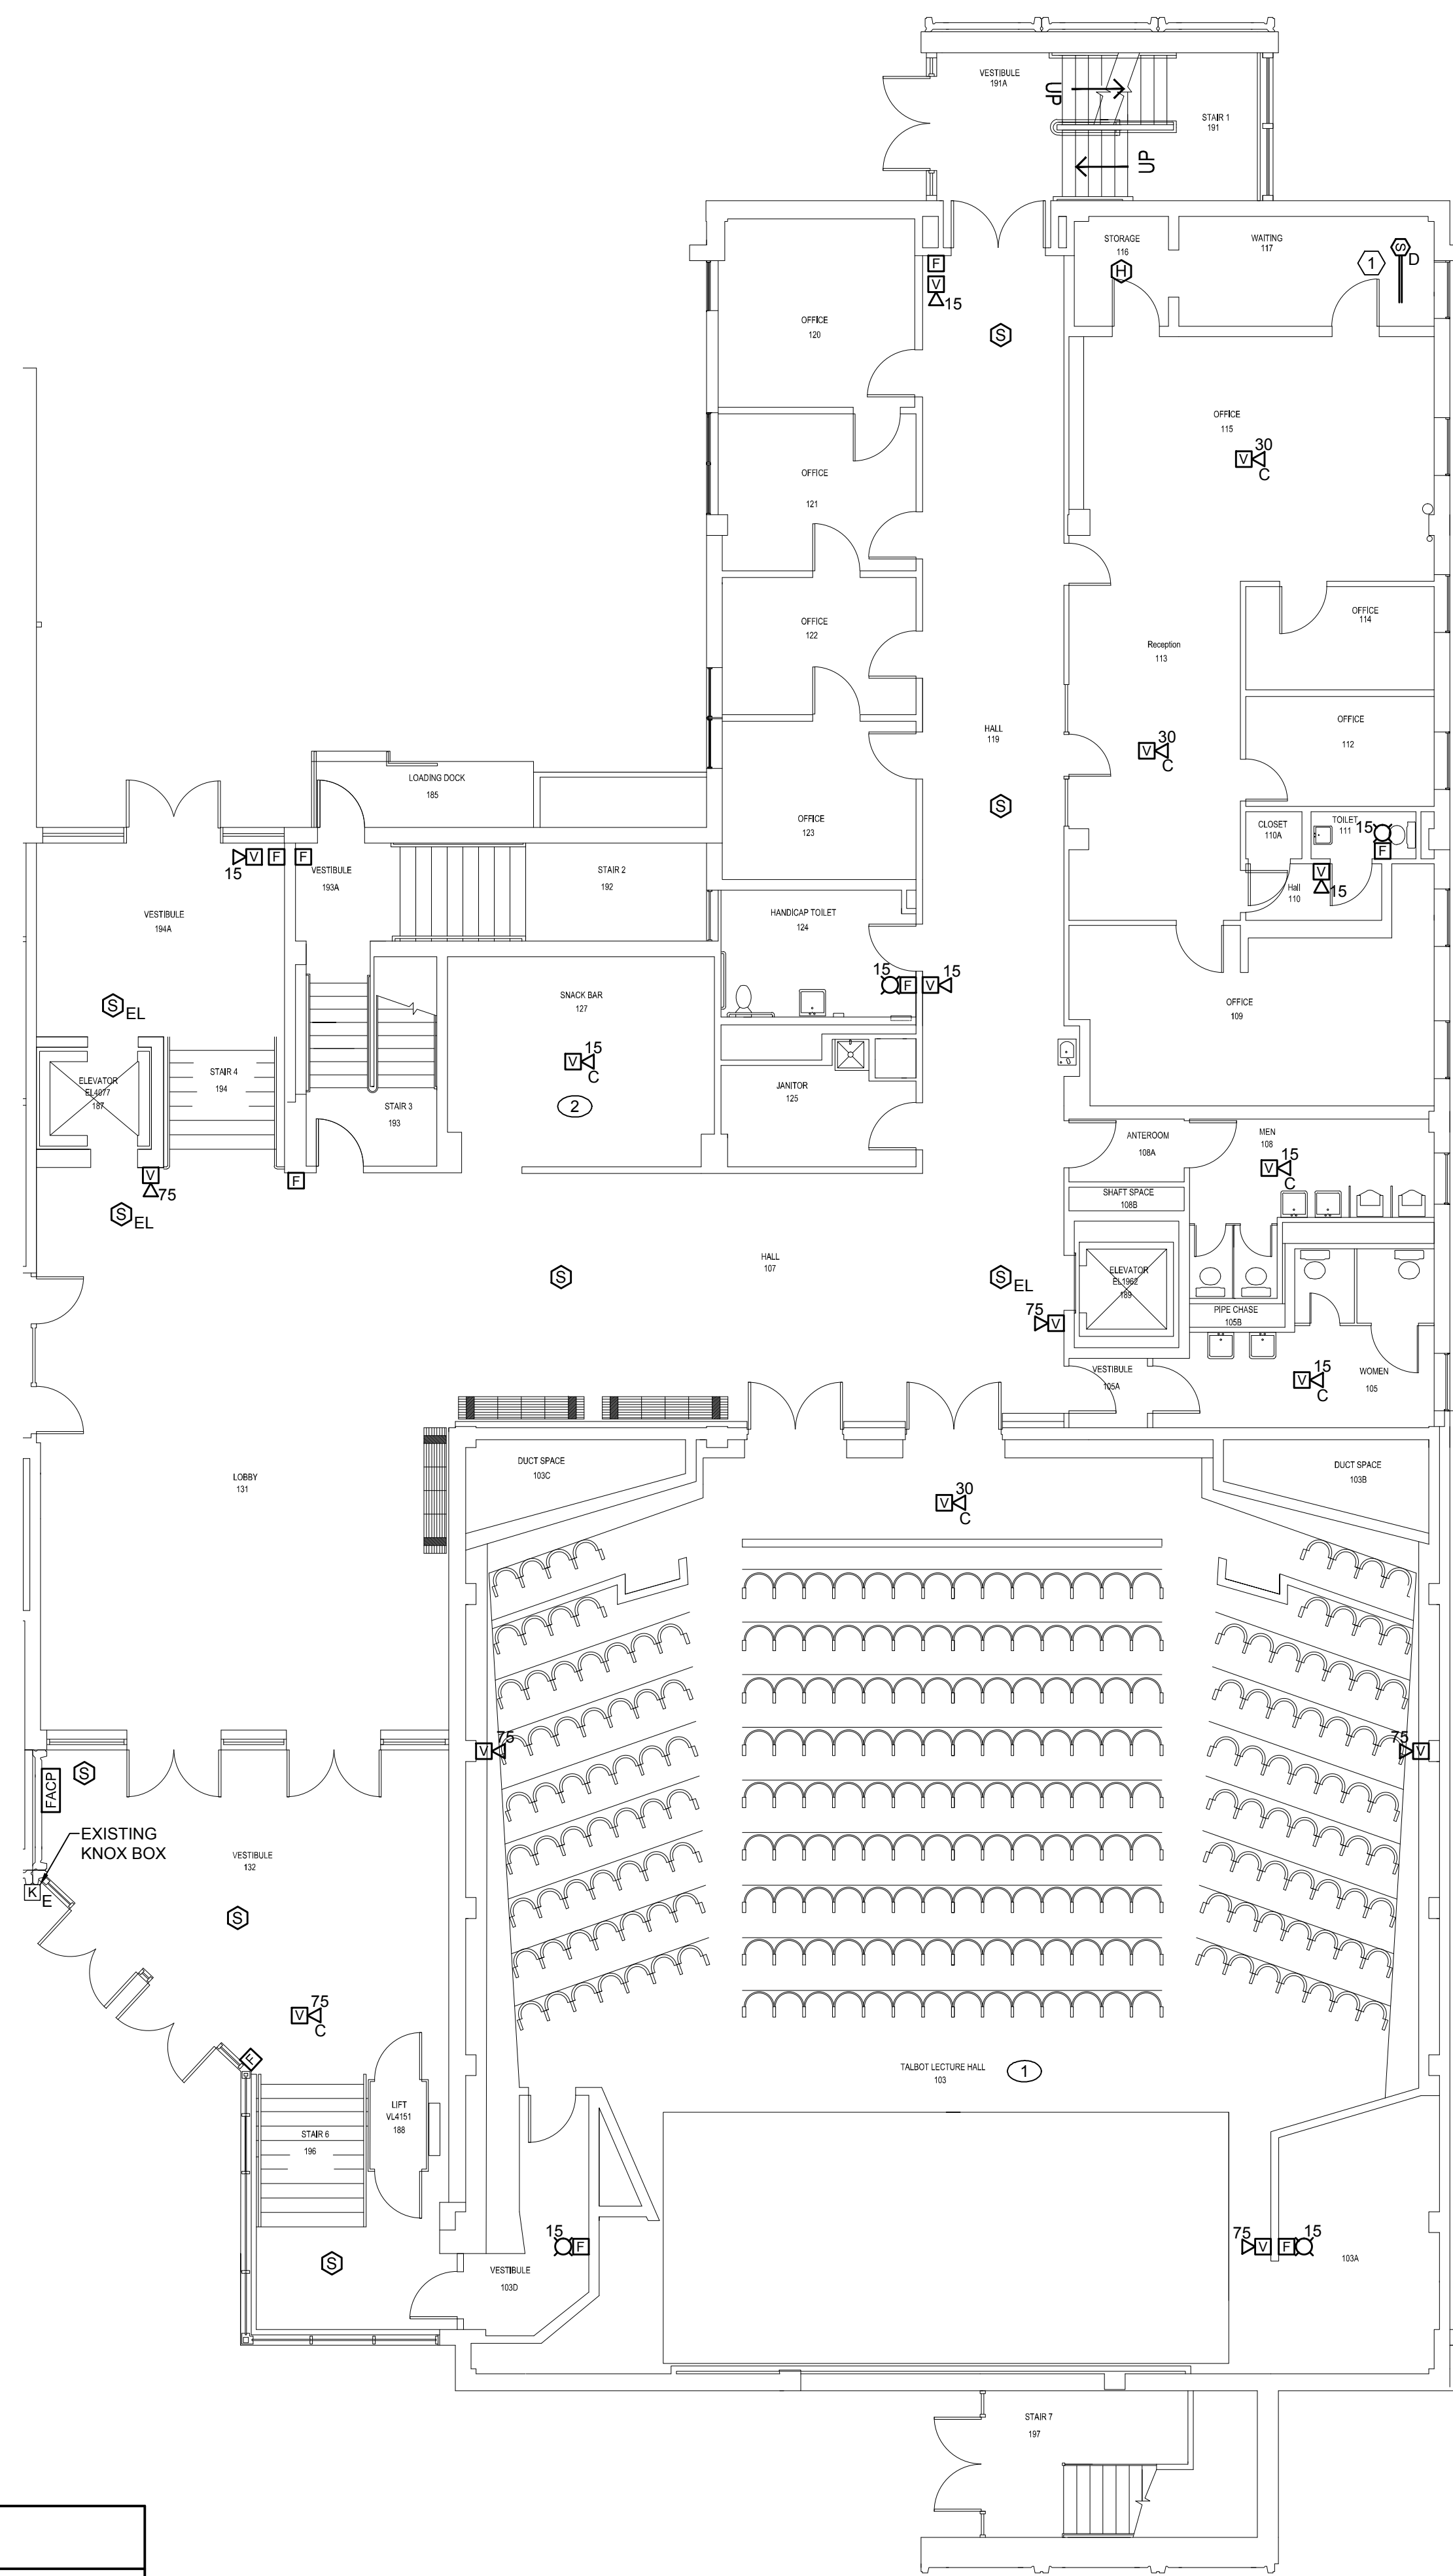


HAZARDOUS MATERIAL NOTES:

- ① HAZARDOUS MATERIALS HAVE BEEN IDENTIFIED WITHIN THE FIREPROOFING MATERIAL IN AND AROUND THIS SPACE. CONTRACTOR SHALL AVOID DISTURBING THIS MATERIAL.
- ② HAZARDOUS MATERIALS HAVE BEEN IDENTIFIED WITHIN THE PIPE INSULATION IN AND AROUND THIS SPACE. CONTRACTOR SHALL AVOID DISTURBING THIS MATERIAL.

TECHNICAL NOTES:

- ① DUCT SMOKE DETECTORS ARE IS NOTED DIAGRAMMATICALLY IN THIS SPACE. REPLACE EXISTING DUCT SMOKE DETECTOR WITH A NEW DEVICE AND CONNECT TO NEW FIRE ALARM SYSTEM. CONTRACTOR SHALL FIELD VERIFY THE EXACT LOCATION OF EACH EXISTING DETECTOR. IF 120V POWER IS REQUIRED, CONNECT TO NEARBY RECEPTACLE CIRCUIT.

AREA OF RENOVATION

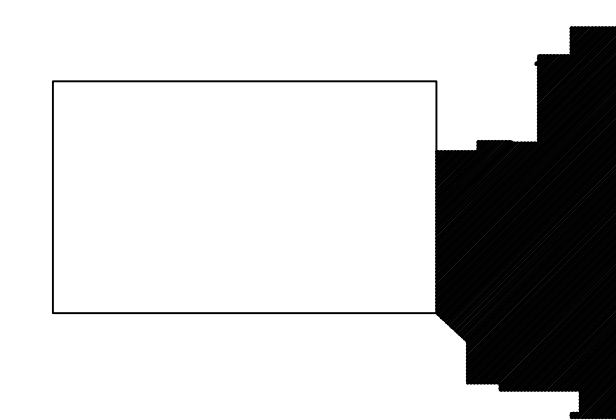


KEY PLAN


0	CONSTRUCTION DOCUMENTS	05.10.13
REV.	DESCRIPTION	DATE

CONSTRUCTION DOCUMENTS
05.10.13

CURRENT ISSUE STATUS:

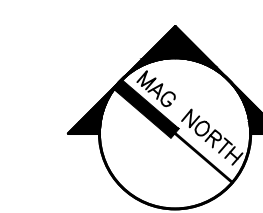

PROJECT NORTH

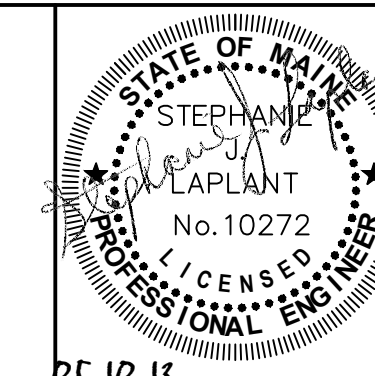

P.C. ID. 13

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LUTHER BONNEY FIRE ALARM UPGRADES

PROJECT: PORTLAND, MAINE

FIRST FLOOR FIRE ALARM PLAN - SEG A

SHEET TITLE: WBRC CAD FILE: 3842.13 - FA101A

PROJECT No. 3842.13 GRAPHIC SCALE: 0" 1"

SCALE: AS NOTED SHEET No.

PM: SJL

DRAWN BY: KRM **FA101A**

A/E OF RECORD: SJL © COPYRIGHT 2013 WBRC

A1 FIRST FLOOR FIRE ALARM PLAN - SEG A

1/8" = 1'-0"