

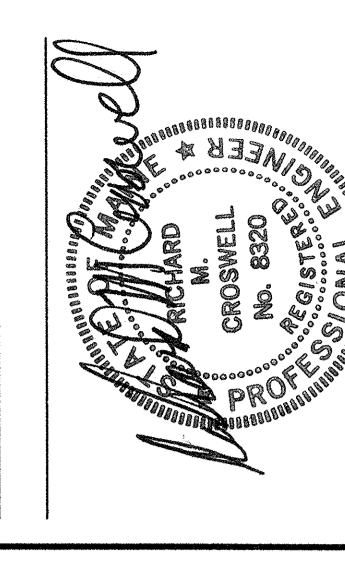


OWNER REVIEW _____ DATE _____
 NAME _____


NO. 2-20-04 CONTRACT DOCUMENTS
 NO. DATE DESCRIPTION
 ISSUES
 = CLOSED CHANGE
 UNIVERSITY OF SOUTHERN MAINE
 70 Fairmount Street
 Portland, Maine

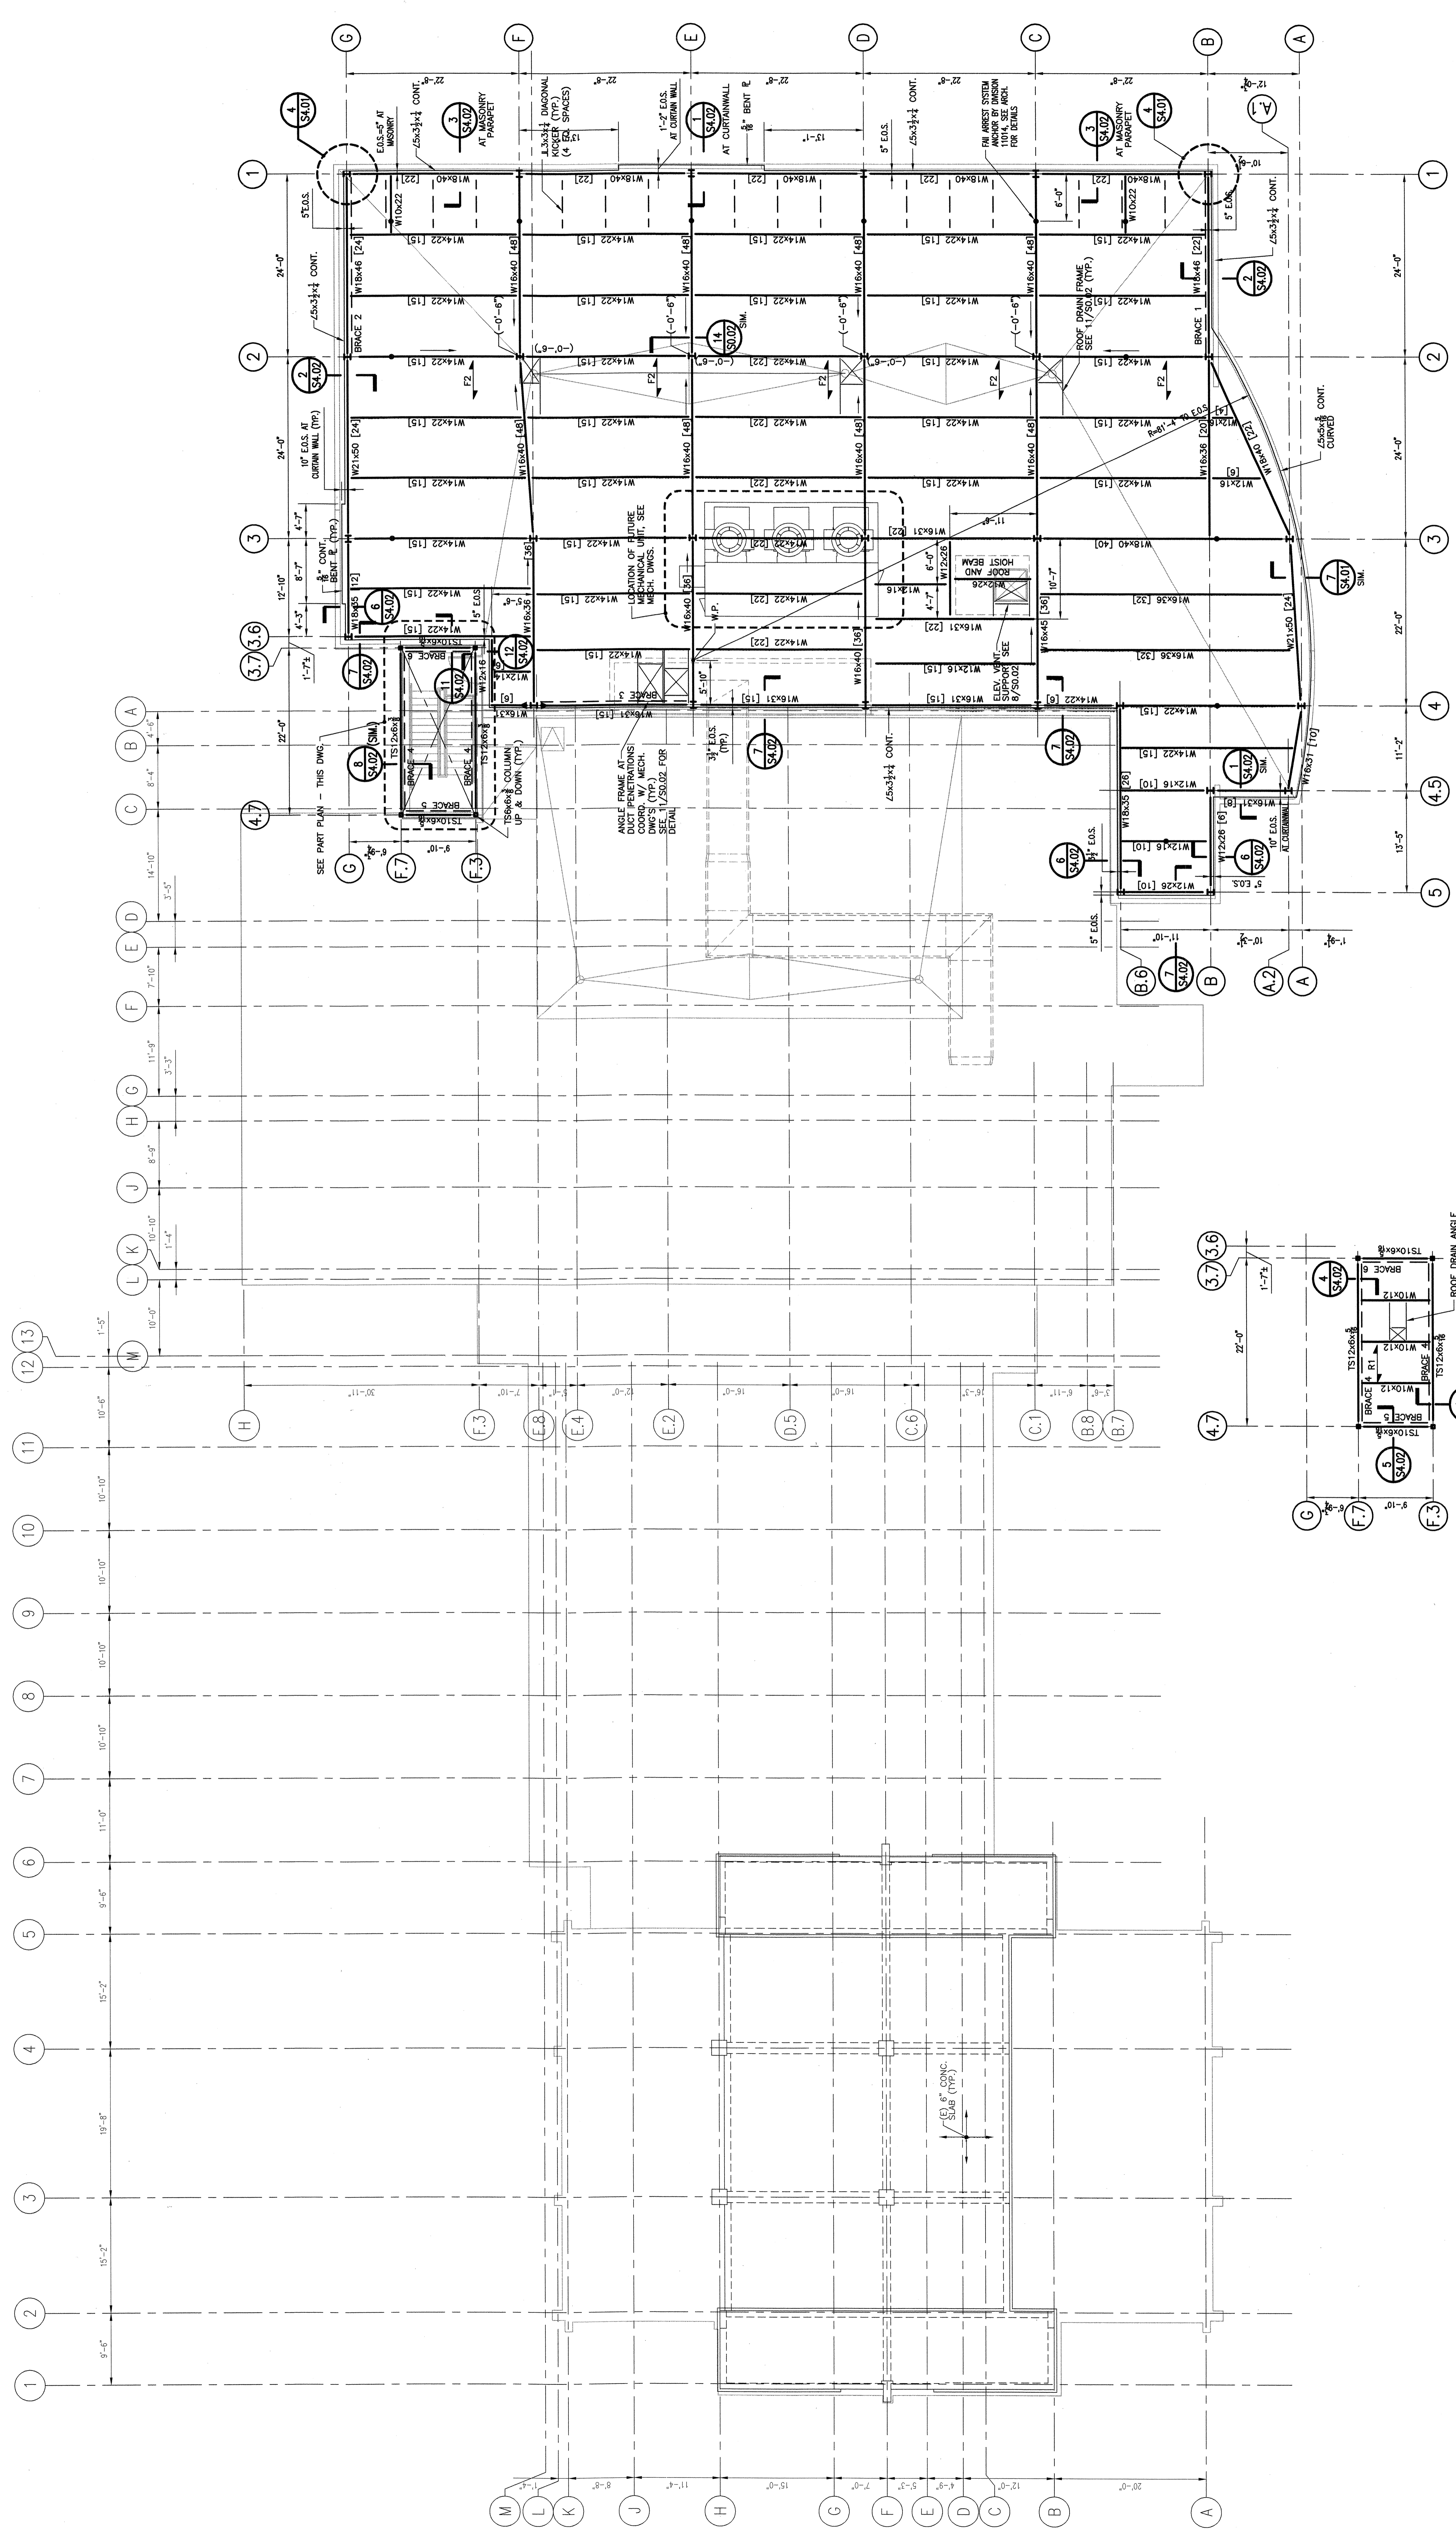

NEW ROOF FRAMING PLAN
 SCALE 1/8"=1'-0"
 DRAWN BY RLU/TMA
 CHECKED BY PROJ. ARCH./ENGR. PROJ. ARCH. RCH.
 PROJ. MGR. RCH.
 JOB NO. 03040.00
 © SYMMES MANU & MCKEE ASSOCIATES, INC. 2005

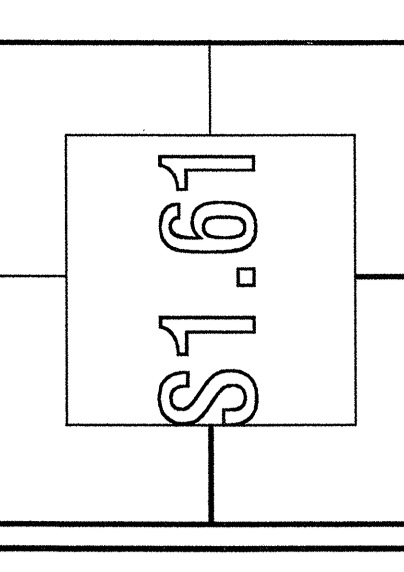

- NOTES:**
1. TOP OF STEEL ELEVATION. UNDERSIDE OF DECK SHALL BE EL. 122'-10" UNLESS OTHERWISE NOTED THERE (40'-0").
 2. R1 INDICATES SPAN DIRECTION OF 1 1/2" X 20 GAGE WIDE RIB METAL ROOF DECK SUPPORTED BY WIDE FLANGE BEAMS AND BRACES.
 3. FZ INDICATES SPAN DIRECTION OF 2" LIGHT WEIGHT CONCRETE SLAB ON 2" X 8 GAGE GALVANIZED CHANNELS AND DECK JOINTS REINFORCED WITH 6# X 20# @ 24" O.C. W/W.F.
 4. [] INDICATES BRACED FRAME LOCATIONS.
 5. [] INDICATES MOMENT CONNECTION.
 6. C.C. SHALL COORDINATE THE SIZE AND LOCATION OF ALL ROOF TOP EQUIPMENT AND OPENINGS WITH THE MECHANICAL DRAWINGS AND THE MECHANICAL UNIT VENDOR (TYP.).
 7. [] INDICATES NUMBER OF 3/4" X 4" LONG HEADED SHEAR CONNECTORS.
 8. LOCATE WBX18 HOIST BEAM AT ELEVATOR SHAFT AS REQUIRED BY ELEVATOR MANUFACTURER.

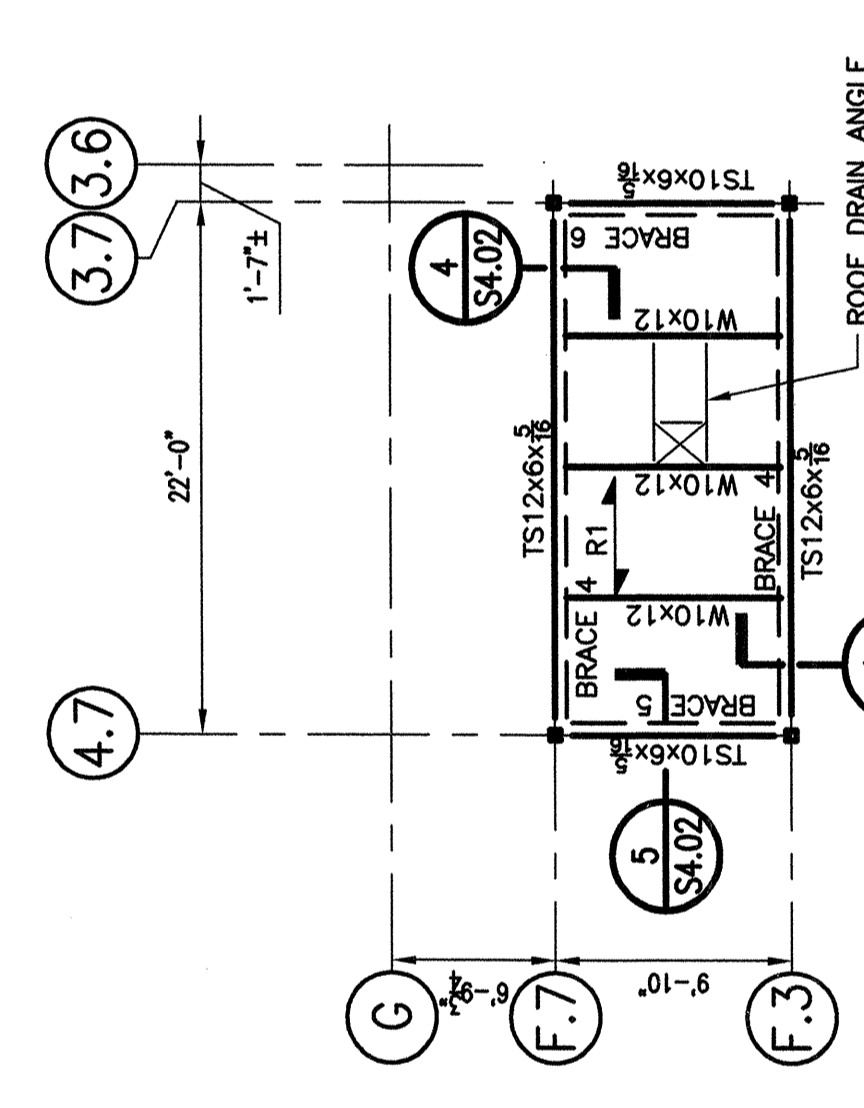

STAIR ROOF PART PLAN
 TOP OF STEEL EL. 133'-3"