


OWNER REVIEW
NAME _____ DATE _____




NO. 2-20-04 CONTRACT DOCUMENTS
NO. DATE DESCRIPTION
REVISIONS

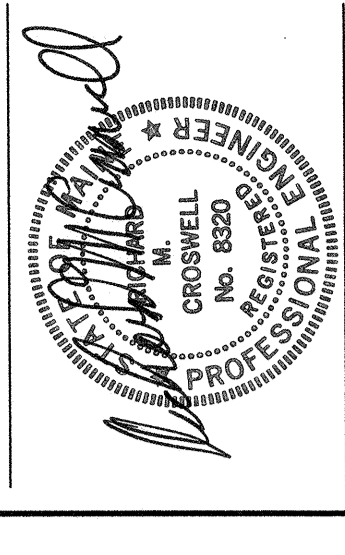

UNIVERSITY OF SOUTHERN MAINE
SCHOOL OF ARCHITECTURE
70 Fairbanks Street
Portland, Maine

NEW FIFTH FLOOR FRAMING PLAN

SCALE 1/8"=1'-0"
DRAWN BY RLU/TMM
CHECKED BY
PROJ. ARCH./ENGR. PROJ. ARCH.
PROJ. MGR. RCH
JOB NO. 03048.00
© SYMMES MANI & MOSEF ASSOCIATES, INC. 200

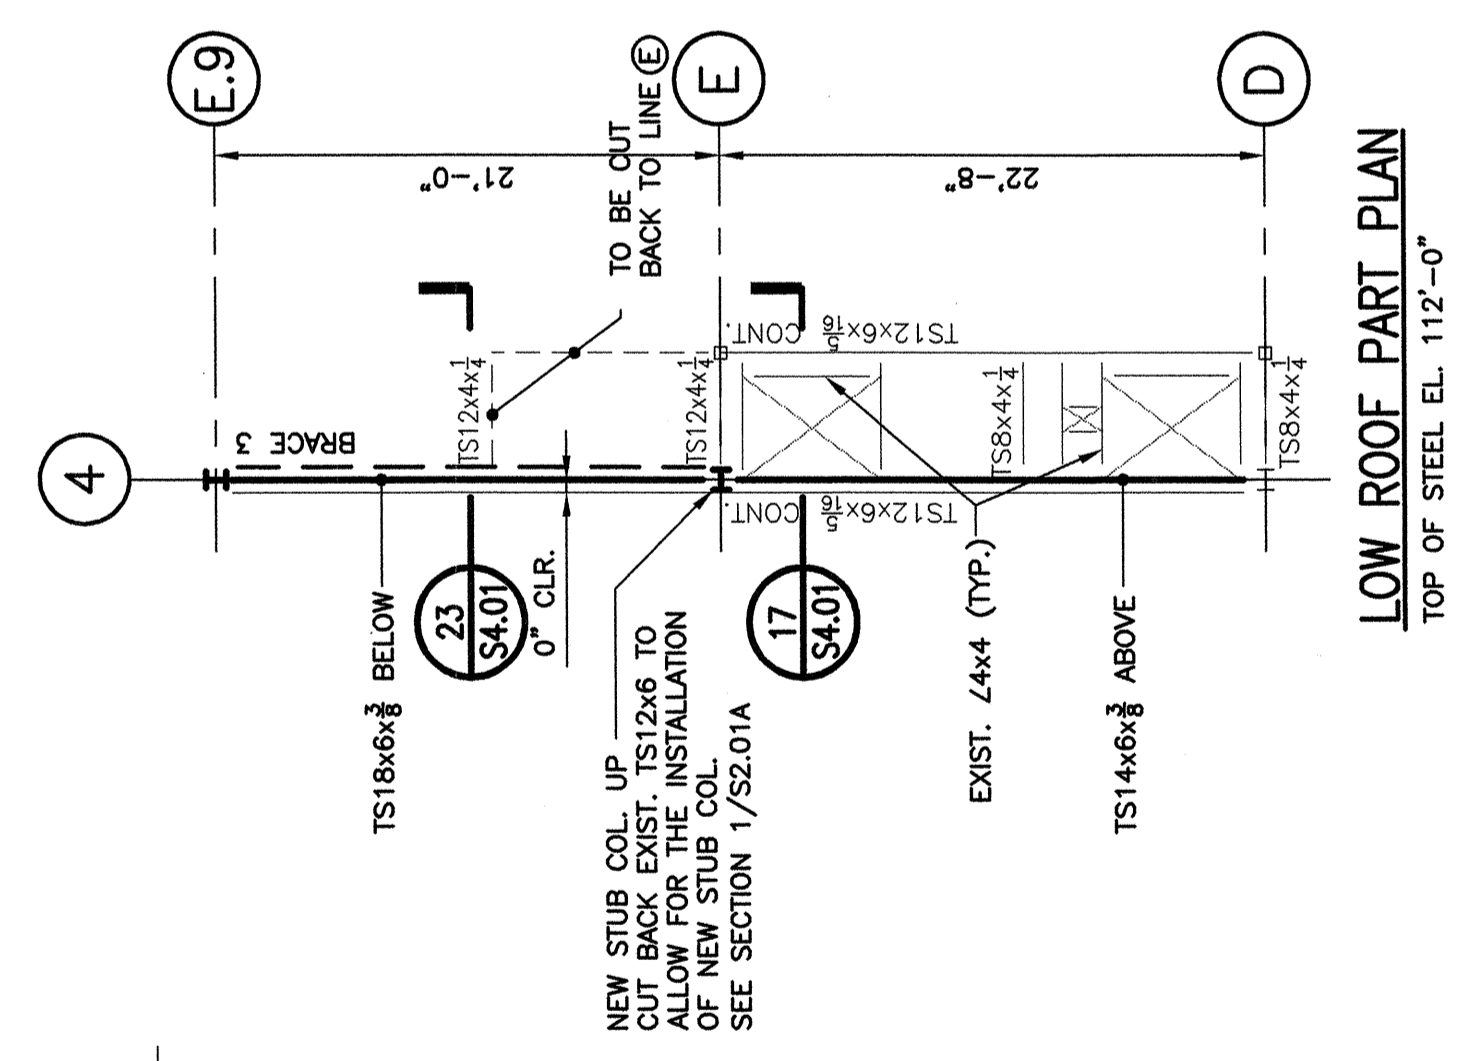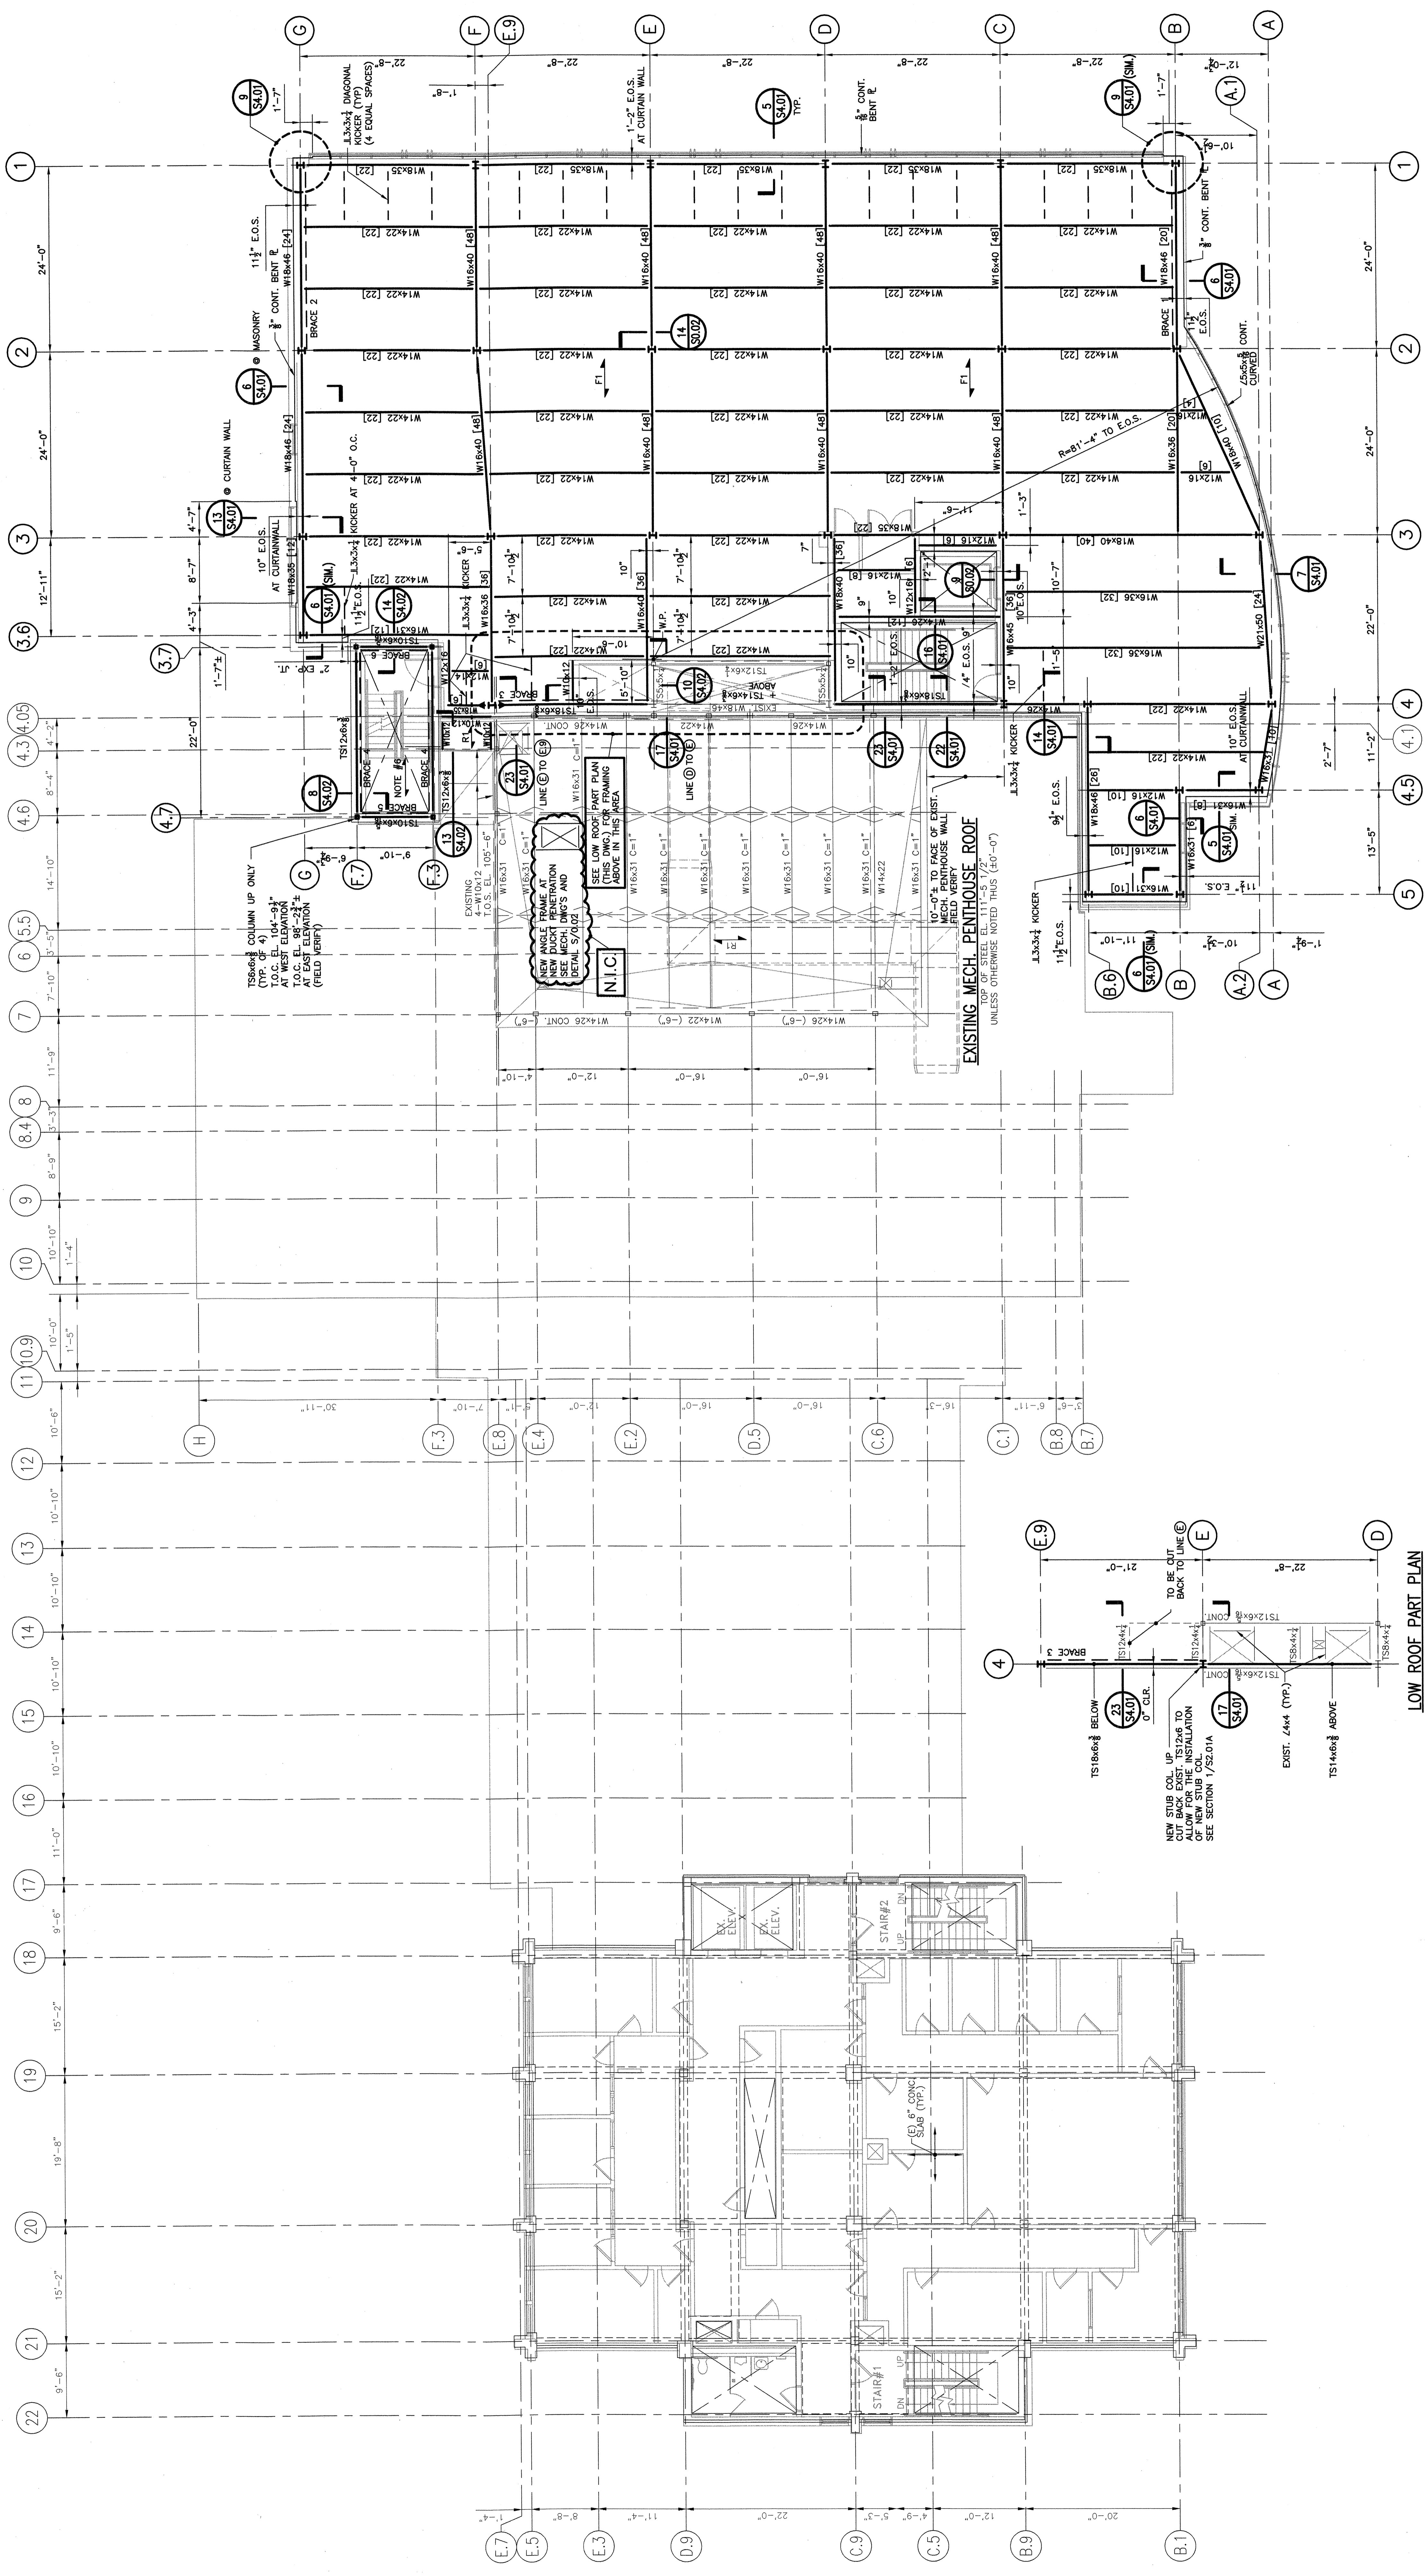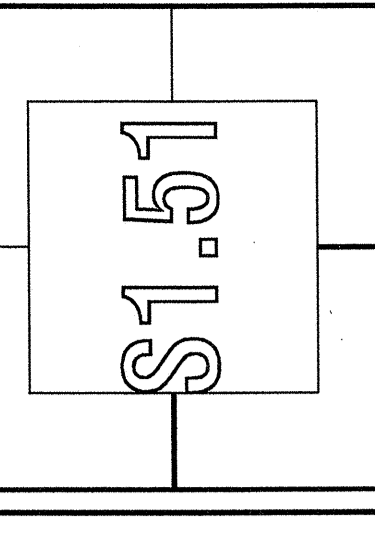

- NOTES:**
1. TOP OF STEEL ELEVATION, UNDERSIDE OF DECK SHALL BE EL. 108'-10" UNLESS OTHERWISE NOTED THIS (40'-0").
 2. FL INDICATES SPAN DIRECTION OF 2" LIGHT WEIGHT CONCRETE SLAB ON 2" x 6" S4S.
 3. CALCULATED COMPOSITE AREA (A_c) TOTAL THICKNESS) REINFORCED WITH 6#6-W2.8Wx2.9 WWF.
 4. [] INDICATES NUMBER OF 3/4" x 4" LONG HEADED SHEAR CONNECTORS.
 5. [] INDICATES BRACED FRAME LOCATIONS.
 6. [] INDICATES MOMENT CONNECTION.
 7. N.I.S. INDICATES FUTURE WORK "NOT IN THIS CONTRACT".