CODE COMPLIANCE

CODE REVIEW SUMMARY

PROJECT DESCRIPTION:

REMOVALS AND RENOVATIONS TO EXISTING CLASSROOM AREAS FOR USE AS LEARNING LABORATORIES WHERE STUDENTS INTERACT WITH ELECTRONICALLY CONTROLLED PATIENT MANNEQUINS WITHIN A SIMULATED HEALTHCARE ENVIRONMENT.

FIRE: NFPA INCLUDING 101 LIFE SAFETY CODE, 2009 EDITION

BUILDING: INTERNATIONAL BUILDING CODE, 2009 EDITION

ACCESSIBILITY: ADA, ACCESSIBILITY GUIDELINES FOR BUILDINGS AND FACILITIES.

PLUMBING: MAINE STATE PLUMBING CODE, 2009 EDITION

ELECTRICAL: NATIONAL ELECTRICAL CODE, 2008 EDITION

USE GROUP CLASSIFICATION(S):

IBC: BUSINESS GROUP B — EDUCATIONAL OCCUPANCY ABOVE 12TH GRADE NFPA: BUSINESS — COLLEGE AND UNIVERSITY INSTRUCTIONAL BUILDINGS

SPECIFIC OCCUPANCY AREAS/HAZARDOUS AREA PROTECTION:

IBC CHAPTER 3, TABLE 302.1.1 NFPA 101 CHAPTER 38

STORAGE ROOMS > 100 SQ FT 1 HOUR SEPARATION OR AUTO SPRINKLERS

TYPE OF CONSTRUCTION:

IBC: CHAPTER 6, TABLE 601: NON-COMBUSTABLE

MINIMUM NUMBER OF EXITS REQUIRED PER FLOOR LEVEL: 2

PER ROOM WITH >50 OCCUPANTS: 2

EGRESS CAPACITY:

EXIT ACCESS CORRIDOR WIDTH:

DOOR WIDTH

MINIMUM ALLOWABLE
44 IN. CLEAR
32 IN. CLEAR

100 FT.

300 FT.

ARRANGEMENT: MAXIMUM ALLOWABLE 50 FT.

COMMON PATH OF TRAVEL
TRAVEL DISTANCE TO EXIT

EMERGENCY LIGHTING: EXISTING BATTERY BACK-UP FIXTURES WILL BE RELOCATED AND SUPPLEMENTED AS NECESSARY TO PROVIDE MINIMUM LIGHT LEVELS REQUIRED BY NFPA 101/7.9.2.

EXIT SIGNAGE: INTERNALLY ILLUMINATED EXIT SIGNS WITH BATTERY BACK-UP WILL BE RELOCATED AND SUPPLEMENTED AS NECESSARY IN RESPONSE TO THE REQUIREMENTS OF NFPA 101/7.10.

INTERIOR FINISH: IBC - CHAPTER 8, NFPA 101 - CHAPTERS 10 & 19

WALL AND CEILING FINISHES: (IBC TABLE 803.5)
VERTICAL EXITS & PASSAGEWAYS: NOT APPLICABLE
EXIT ACCESS CORRIDORS: CLASS A OR B
ROOMS & ENCLOSED SPACES: CLASS A, B OR C
FLOOR FINISHES: NO REQUIREMENTS

DETECTION, ALARM, AND COMMUNICATIONS SYSTEMS: EXISTING ZONED FIRE ALARM SYSTEM.

OCCUPANT: NOTIFICATION DEVICES CONFORMING WITH NFPA 9.6 WILL BE RELOCATED AND/OR SUPPLEMENTED AS REQUIRED BY THE PARTITION LAYOUT.

EXTINGUISHMENT REQUIREMENTS:


AUTOMATIC FIRE SUPRESSION: EXISTING WATER BASED SPRINKLER SYSTEM WILL HAVE HEAD LOCATIONS MODIFIED AS REQUIRED BY THE PARTITION LAYOUT.

PORTABLE FIRE EXTINGUISHERS: EXISTING PORTABLE FIRE EXTINGUISHERS WILL REMAIN.


CORRIDORS: NO REQUIREMENTS.

NEW CONSTRUCTION SHALL MAINTAIN 1 HOUR FIRE RESISTANCE RATING OF EXISTING CORRIDOR

ENGINEERING
PLANNING
INTERIOR DESIGN
COMMISSIONING

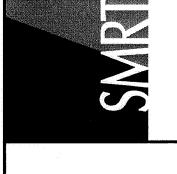




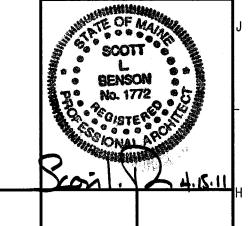

CONSTRUCTION

FOR BIDDING 4-15-

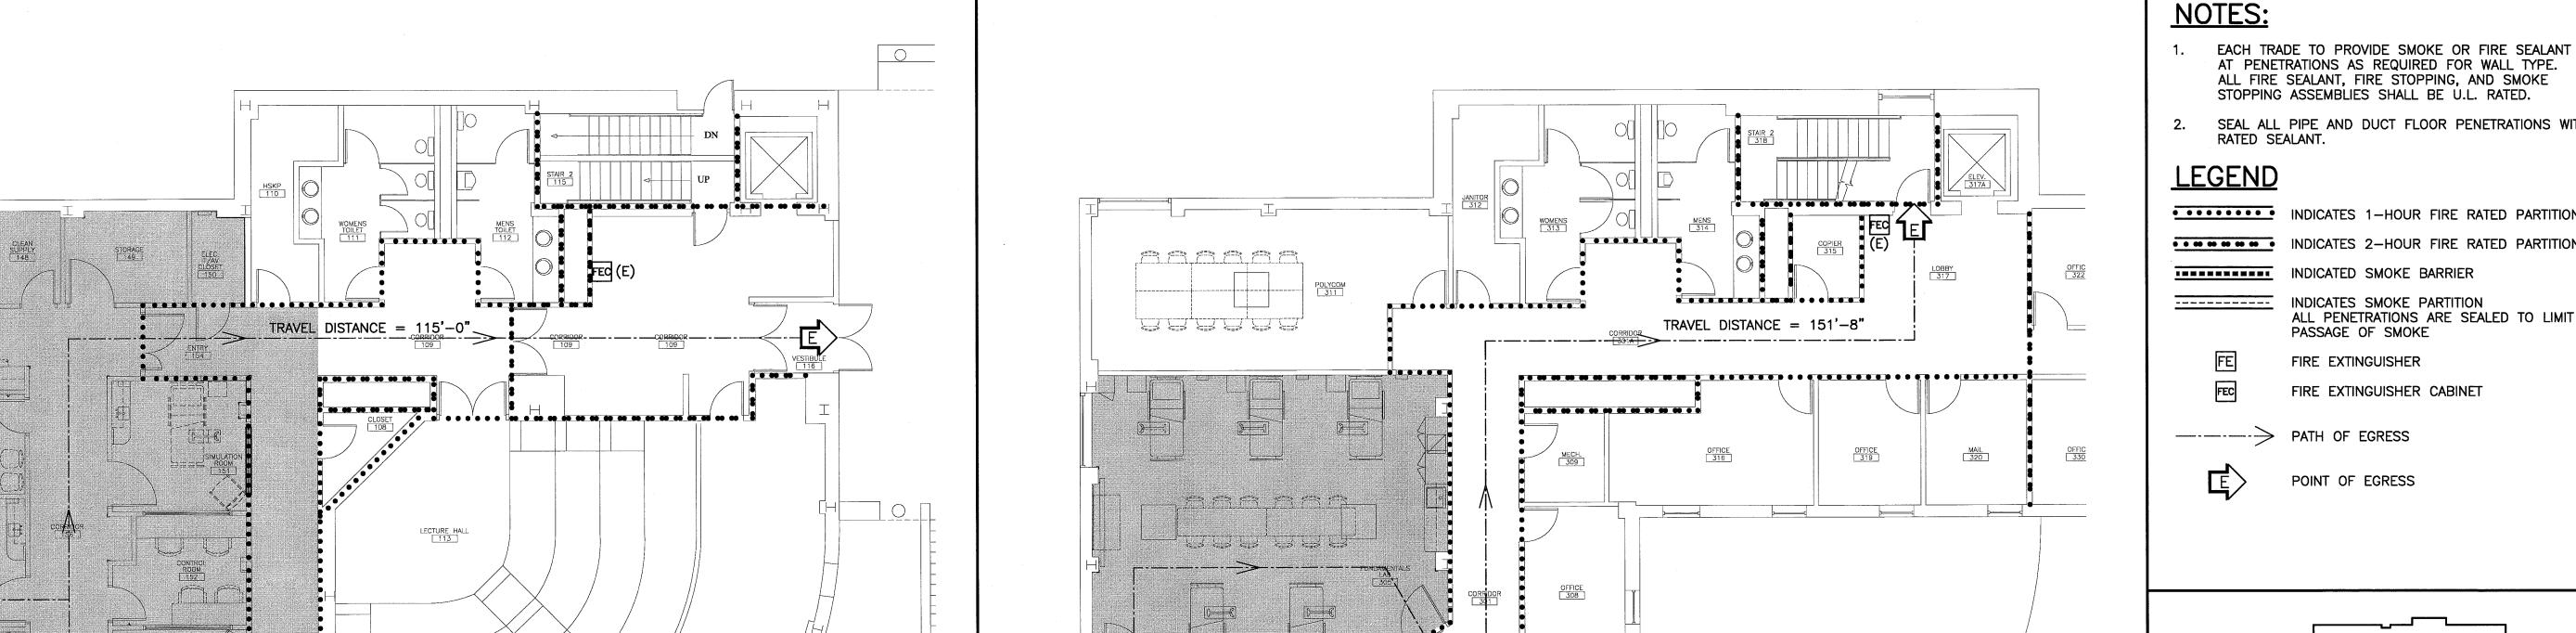

DEBRIEFING

在1962年1823年1962年1

A7

1/8" = 1'-0"

2. SEAL ALL PIPE AND DUCT FLOOR PENETRATIONS WITH RATED SEALANT.

LEGEND

INDICATES 1—HOUR FIRE RATED PARTITION
INDICATES 2—HOUR FIRE RATED PARTITION
ALL PENETRATIONS ARE SEALED TO LIMIT THE PASSAGE OF SMOKE

FE FIRE EXTINGUISHER
FIRE EXTINGUISHER CABINET

PATH OF EGRESS

POINT OF EGRESS

MASTERTON HALL
THIRD FLOOR

MASTERTON HALL
FIRST FLOOR

MASTERTON HALL
FIRST FLOOR

MASTERTON HALL
FIRST FLOOR

MASTERTON HALL
FIRST FLOOR

GRAPHIC SC.

COLLE
PROJECT MA
JC/ORAWN E
JC

GRAPHIC SCALE:

O" 1"

SCALE: AS NOTED

PROJECT MANAGER: SLB

JC/DRAWN BY: CAH

A/E OF RECORD: SLB

CAD FILE: A-001-10150

PROJECT NO: 10150-00

DATE: 4-15-11

SHEET TITLE:

CODE

COMPLIANCE PLAN

A1 FIRST FLOOR CODE COMPLIANCE PLAN

1/8" = 1'-0"

TRAVEL DISTANCE = 67'-5"

THIRD FLOOR CODE COMPLIANCE PLAN

NOT TO SCALE

KEY PLAN

- AREA OF WORK

SHEET No.

A-001
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