




1 ENLARGED LECTURE HALL ELECTRICAL PLAN
EP101 SCALE: 1/4"=1'-0"

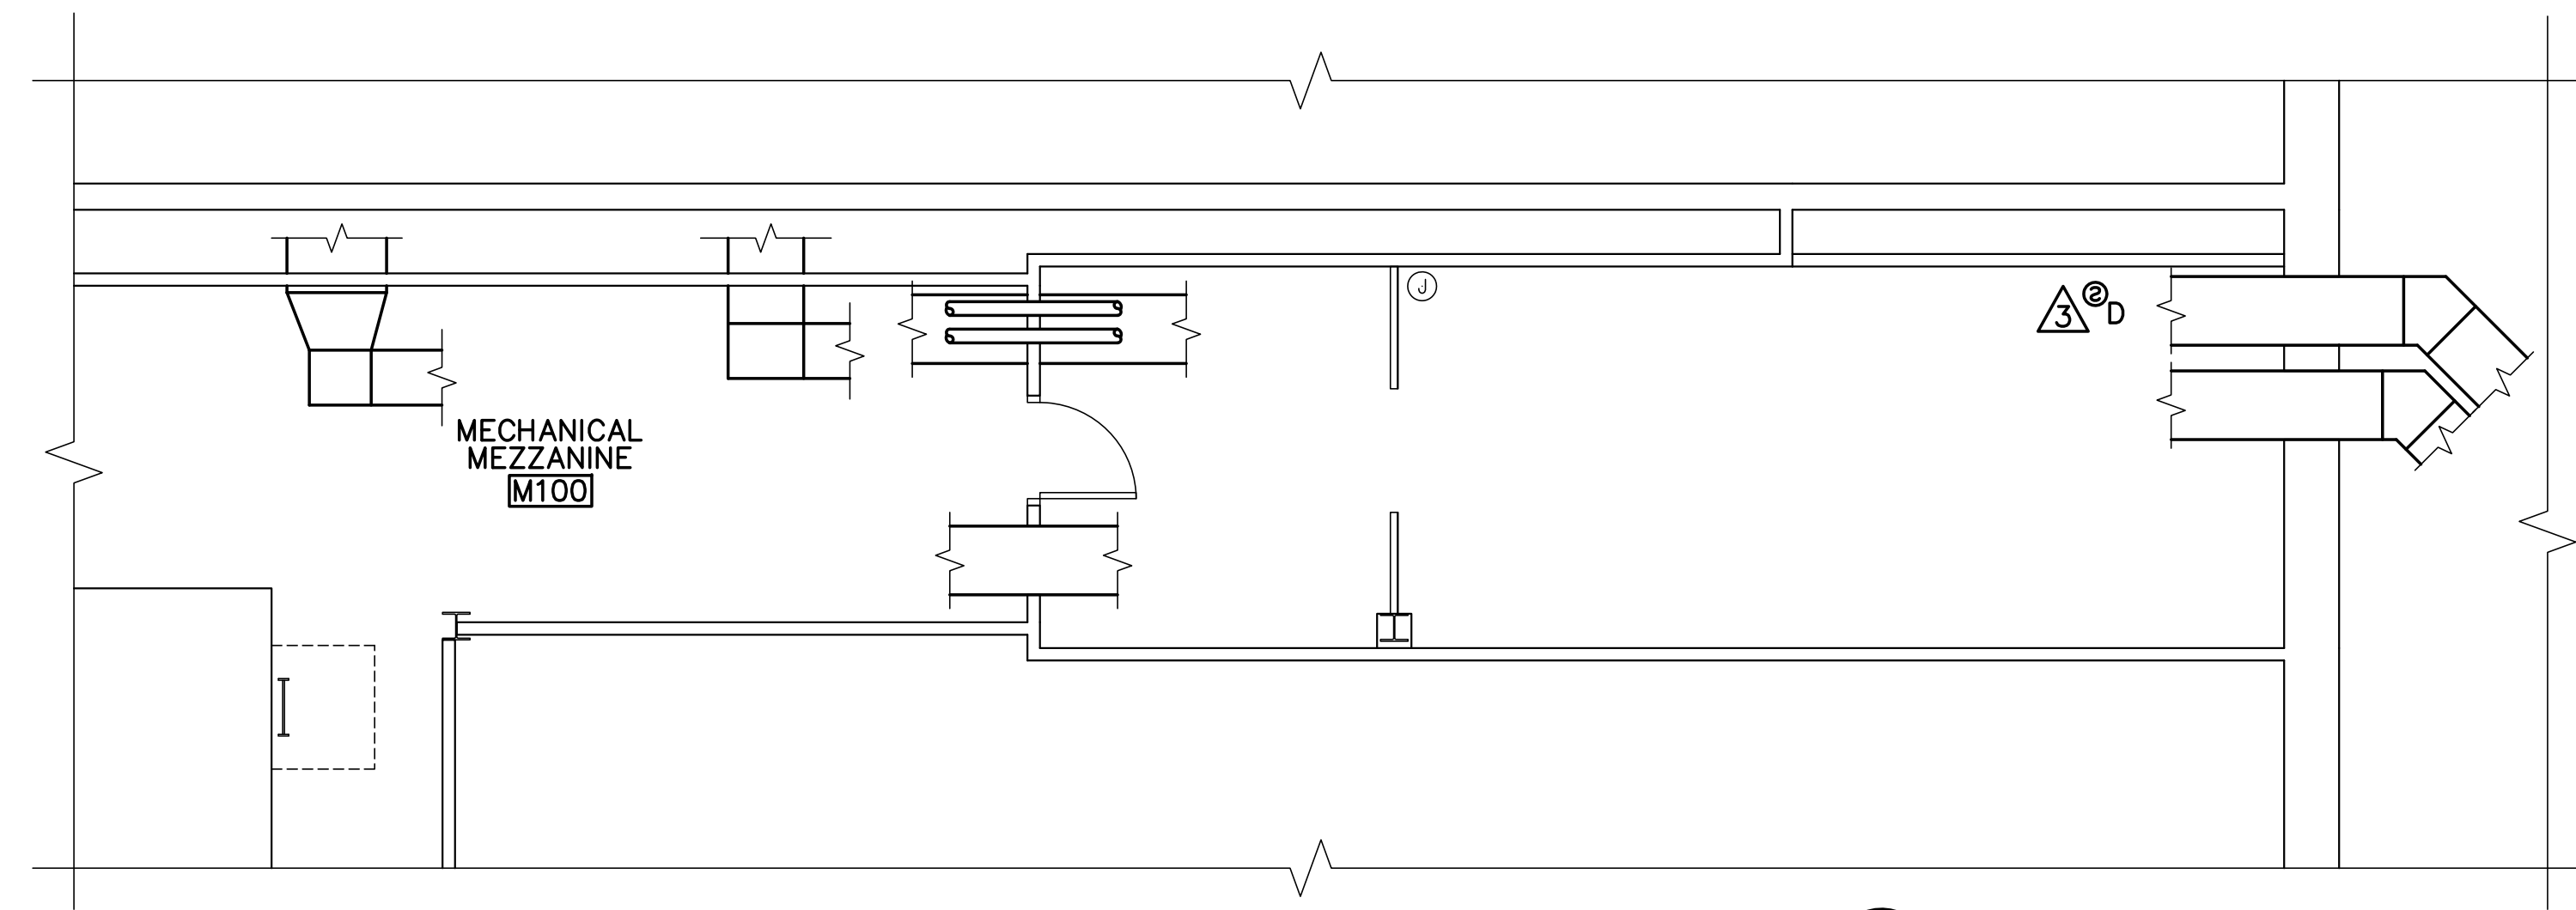

2 ENLARGED EQUIPMENT ROOM ELECTRICAL PLAN
EP101 SCALE: 1/4"=1'-0"

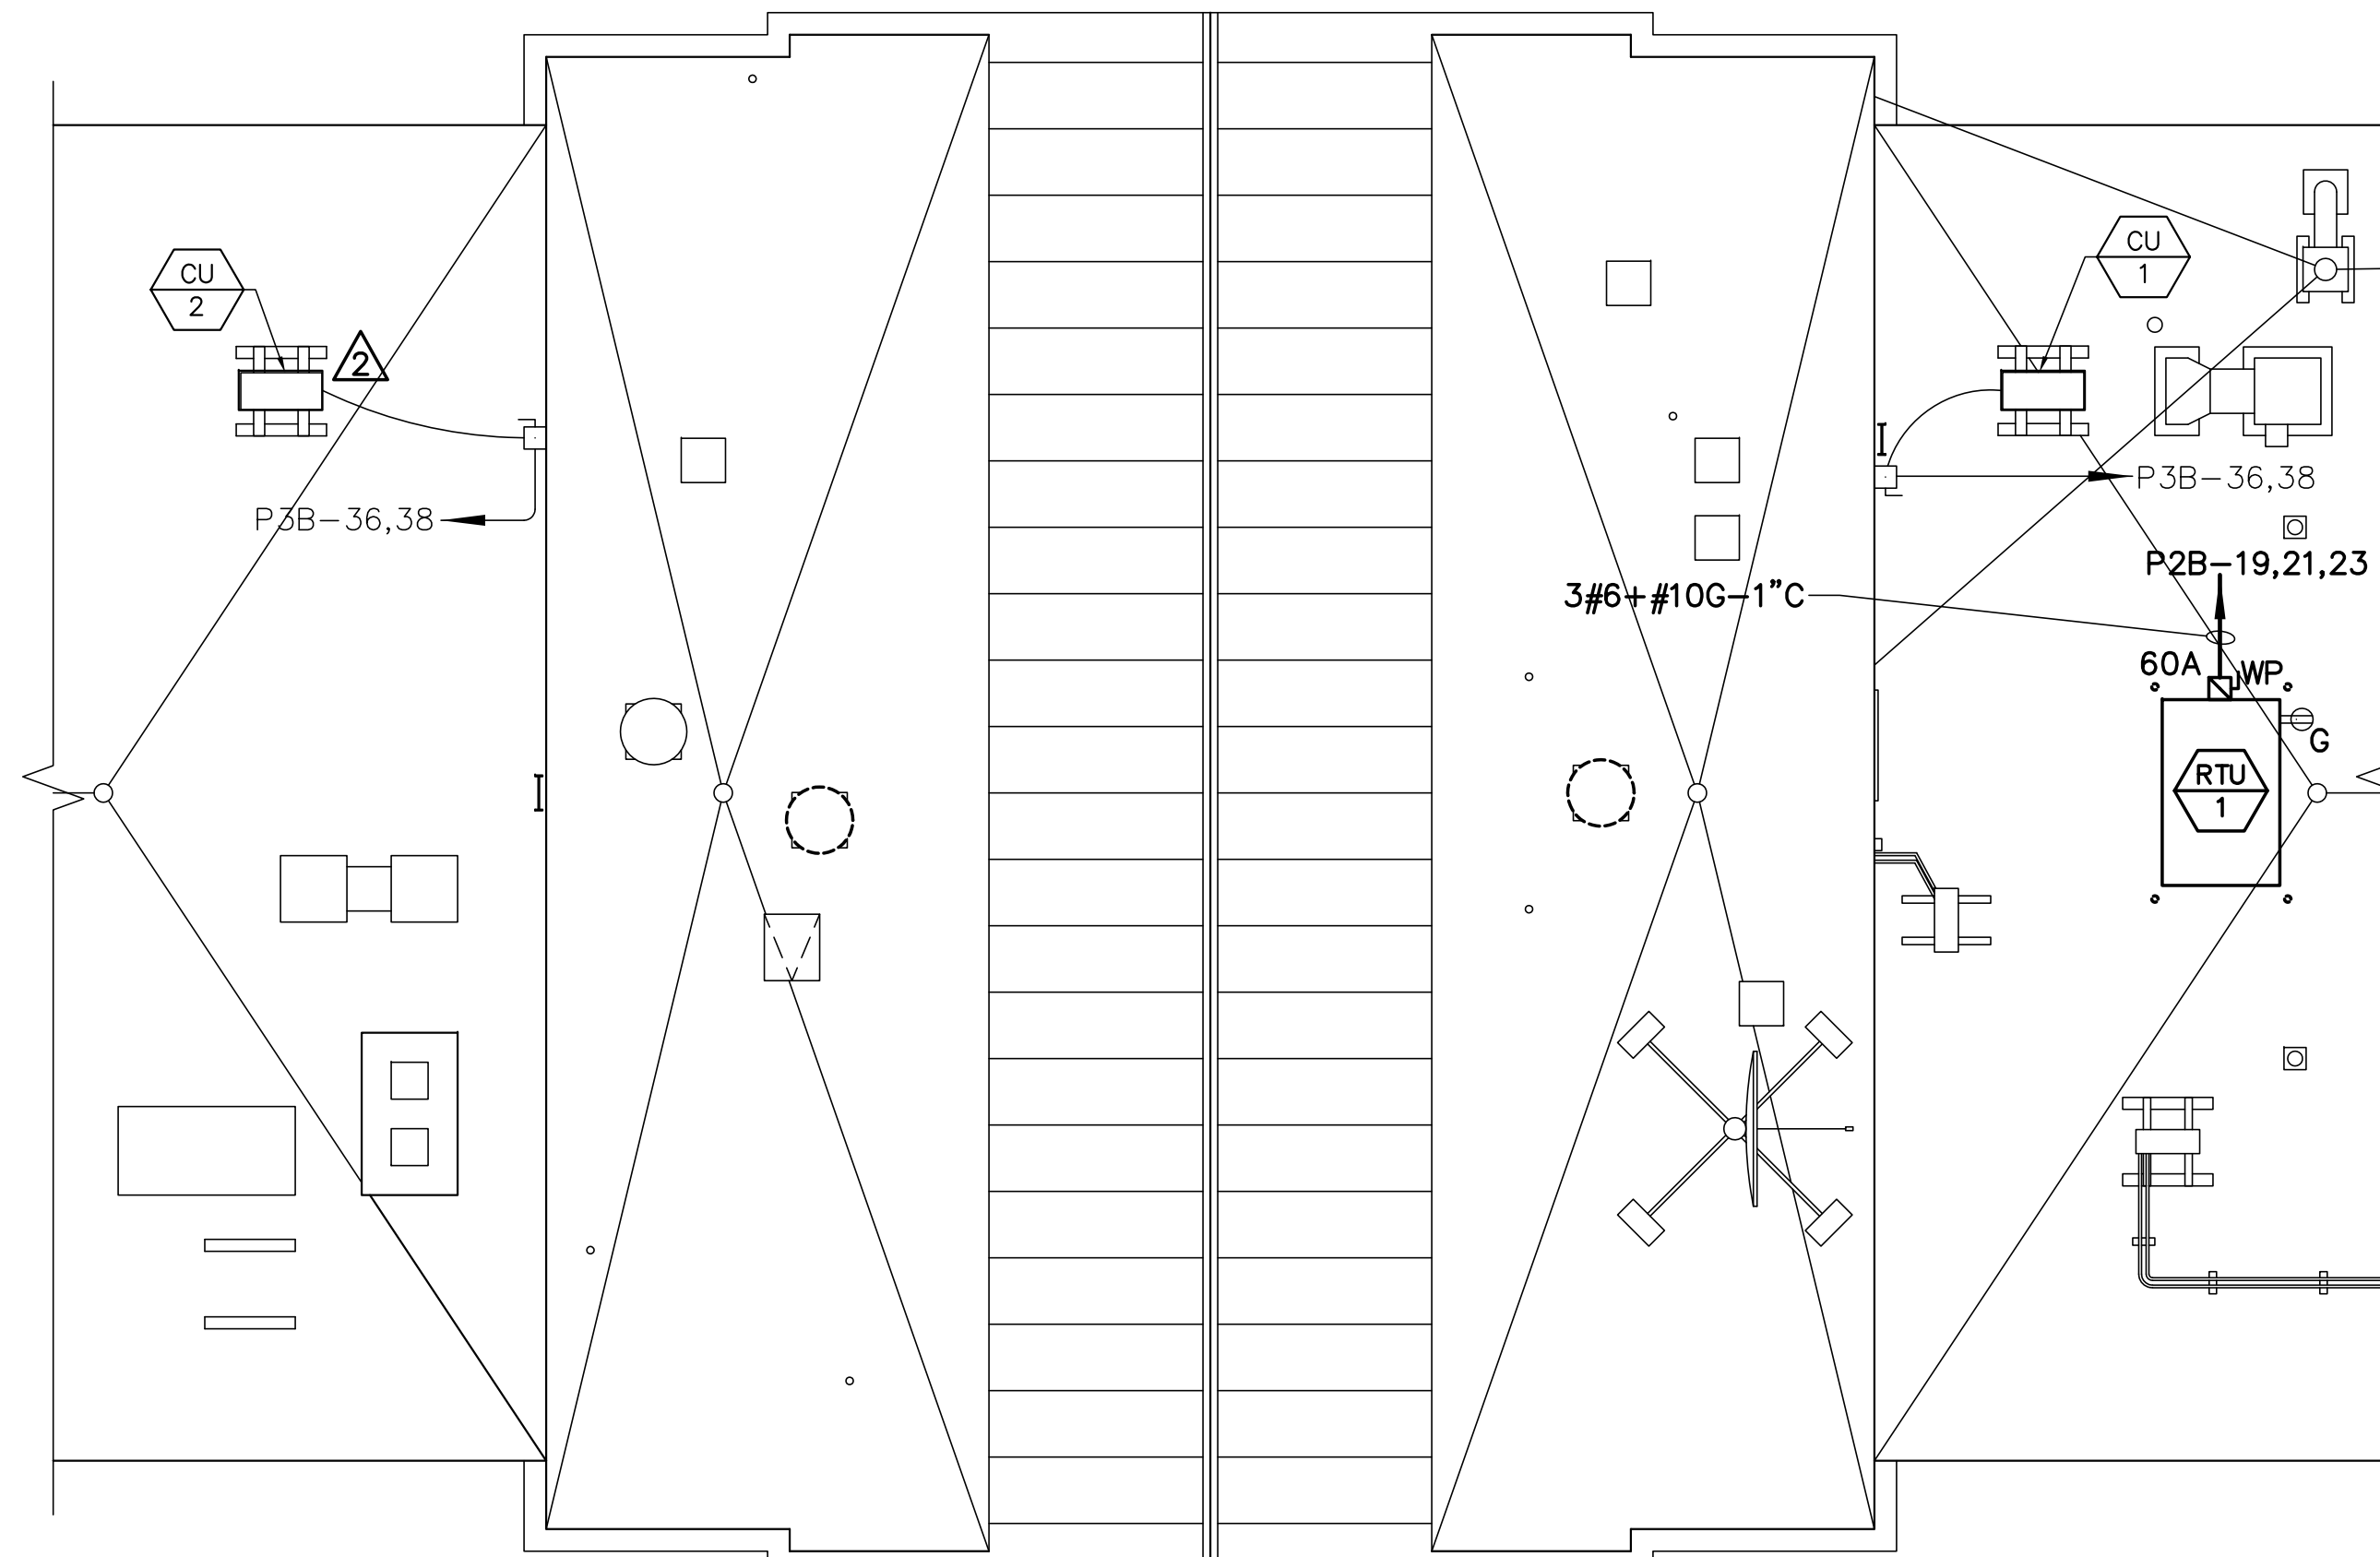

3 ENLARGED ELECTRICAL ROOF PLAN
EP101 SCALE: 1/8"=1'-0"

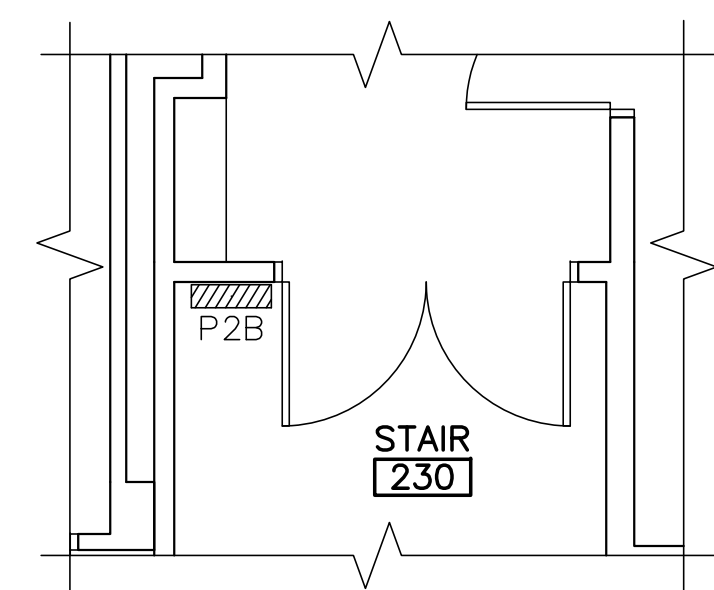

4 2ND FLOOR PART PLAN
EP101 SCALE: 1/4"=1'-0"




GENERAL NOTE


- REFER TO SHEET E-001 FOR SYMBOLS, ABBREVIATIONS, AND GENERAL NOTES.

DRAWING KEYNOTES


- INSTALL SALVAGED EMERGENCY FIXTURE, CONNECT TO EXISTING WIRING. TEST FOR PROPER OPERATION PER NFPA 101.
- PROVIDE CONDUIT AND WIRING FROM AC-2 TO EXISTING CU-2 ON ROOF.
- PROVIDE DUCT SMOKE DETECTOR AND COORDINATE LOCATION WITH MECHANICAL TRADE. CONNECT TO EXISTING DUCT DETECTOR CIRCUIT, EXTEND AS REQUIRED.

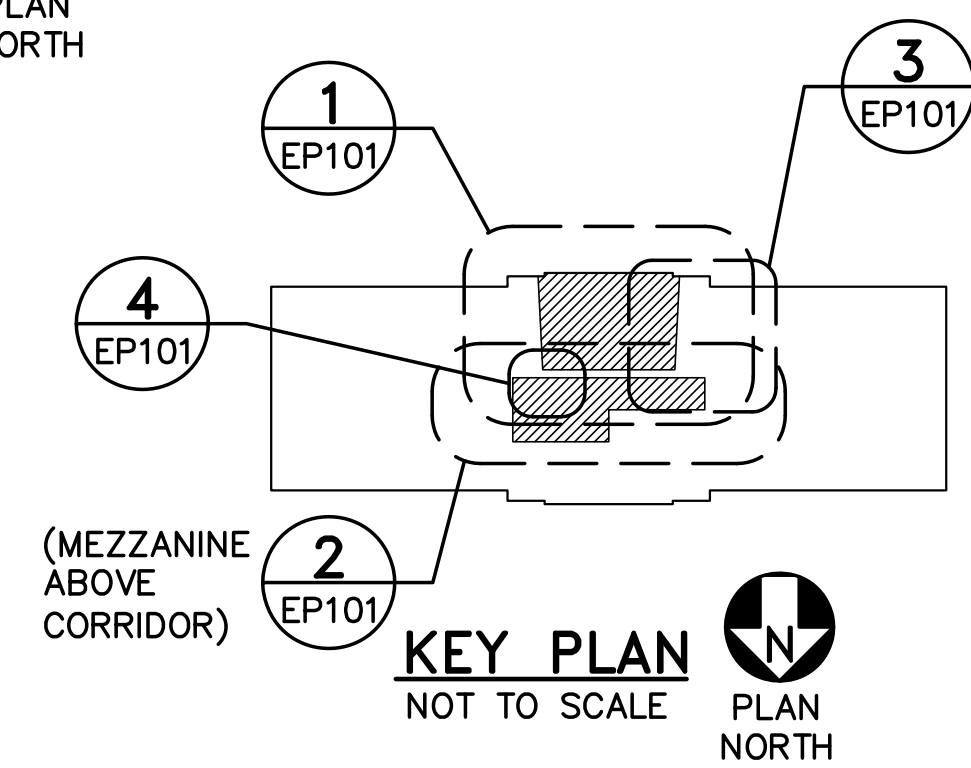

KEY PLAN
NOT TO SCALE
PLAN NORTH

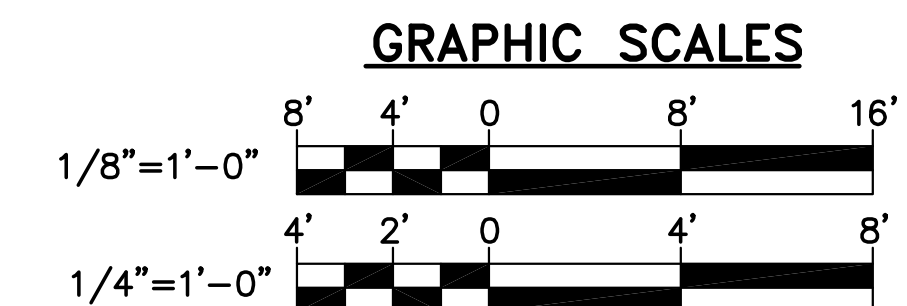

CHECK GRAPHIC SCALES BEFORE USING

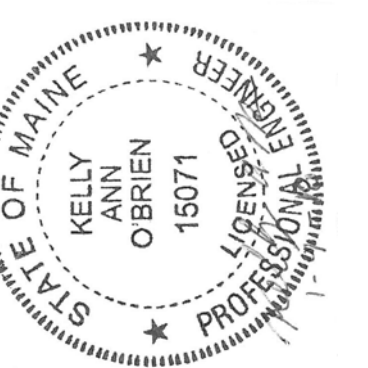

DESIGNED BY: KAO
DRAWN BY: RSW
CHECKED BY: KAO
PROJECT: 21702.01

UNIVERSITY OF SOUTHERN MAINE
COLLEGE OF EDUCATION AND
HUMAN DEVELOPMENT

Portland, ME 04104

LECTURE HALL RENOVATION
AND UPGRADES
PAYSON SMITH HALL
96 Falmouth St. - Portland, Maine

ELECTRICAL PLANS

SCALE: AS NOTED

DATE: 01-09-18

DWG.: **EP101**

SHEET: **17** OF **17**