
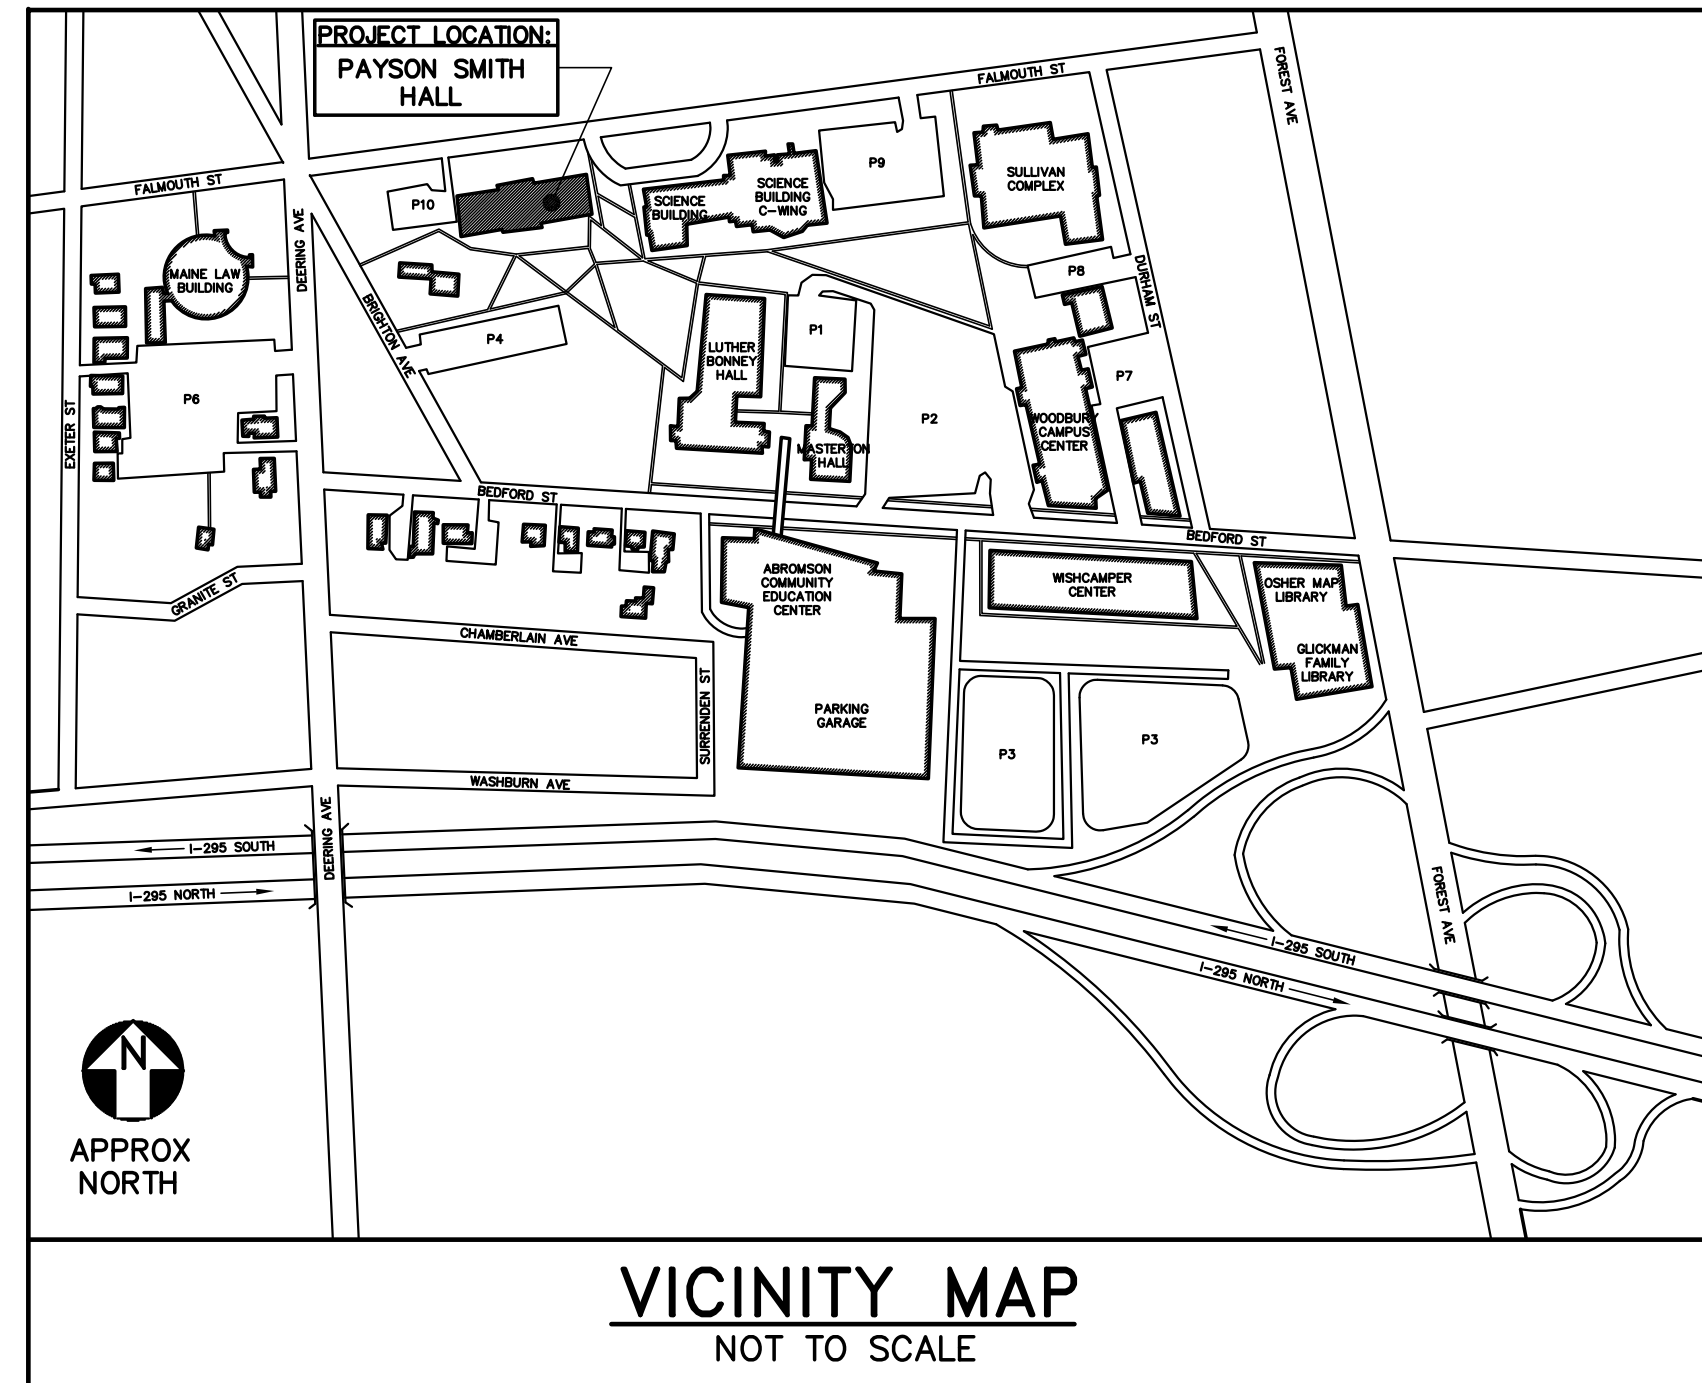


LECTURE HALL RENOVATIONS AND UPGRADES, PAYSON SMITH HALL

UNIVERSITY OF SOUTHERN MAINE
96 FALMOUTH STREET, PORTLAND MAINE

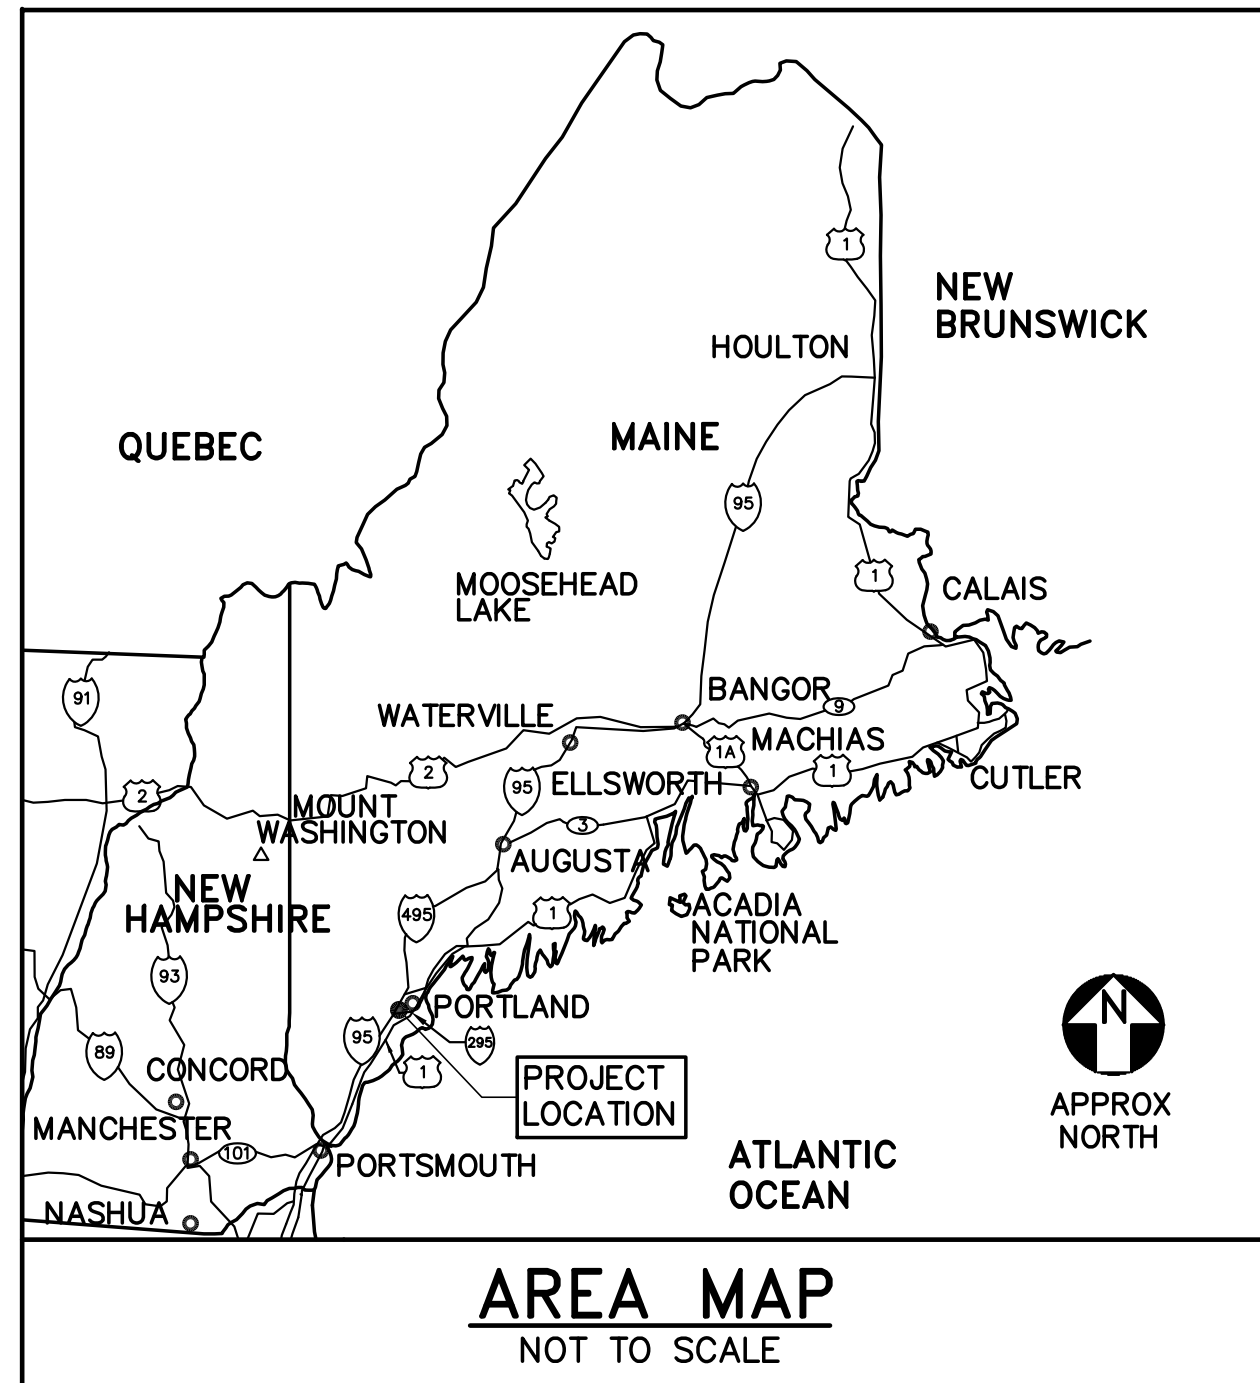

LIST OF DRAWINGS

DISCIPLINE SHEET NO	SEQUENCE NO.	DRAWING TITLE
G-001	1 OF 17	TITLE SHEET
S-001	2 OF 17	STRUCTURAL NOTE, DESIGN LOADS AND ABBREVIATIONS
SF101	3 OF 17	LOW ROOF FRAMING PART PLAN AND DETAILS
AD101	4 OF 17	REMOVALS FLOOR PLANS
AD201	5 OF 17	REMOVALS INTERIOR ELEVATIONS
AE101	6 OF 17	FLOOR PLANS
AE120	7 OF 17	PARTIAL ROOF PLAN AND DETAILS
AE201	8 OF 17	INTERIOR ELEVATIONS
M-001	9 OF 17	MECHANICAL LEGENDS AND ABBREVIATIONS
MD101	10 OF 17	MECHANICAL REMOVALS PART PLANS
M-101	11 OF 17	MECHANICAL PART PLANS
M-102	12 OF 17	MECHANICAL PART PLANS AND SCHEDULES
M-501	13 OF 17	MECHANICAL DETAILS
M-601	14 OF 17	MECHANICAL SCHEDULES, SECTION AND CONTROL DIAGRAMS
E-001	15 OF 17	ELECTRICAL SYMBOLS, ABBREVIATIONS, GENERAL NOTES, AND PANELBOARD SCHEDULES
ED101	16 OF 17	ELECTRICAL REMOVALS PLANS
EP101	17 OF 17	ELECTRICAL PLANS

GENERAL CONSTRUCTION NOTES


- WORK INCLUDED IN THIS CONTRACT SHALL CONFORM TO STATE, NATIONAL AND OTHER CODES AND ORDINANCES WHICH APPLY TO THIS PROJECT INCLUDING IBC 2009 AND NFPA 101, 2009.
- FIELD VERIFY EXISTING CONDITIONS AND DIMENSIONS AND REPORT DISCREPANCIES TO THE OWNER. PROCEED WITH THE WORK ONLY AFTER THE DISCREPANCIES HAVE BEEN RESOLVED BY THE OWNER.
- WORK FROM GIVEN DIMENSIONS AND LARGE SCALE DETAILS ONLY. DO NOT SCALE DRAWINGS.
- CARE SHALL BE TAKEN BY THE CONTRACTOR TO PROTECT NATURAL AREAS TO REMAIN.
- AT THE END OF EACH WORKING DAY, THE CONSTRUCTION SITE SHALL BE LEFT IN A SAFE, WEATHERTIGHT, SECURE, NEAT AND CLEAN MANNER.
- OBTAIN PERMITS WHICH ARE REQUIRED FOR THE SATISFACTORY COMPLETION OF THE WORK. REQUIRED PERMITS INCLUDE, BUT ARE NOT NECESSARILY LIMITED TO:
 - CITY OF PORTLAND BUILDING DEPARTMENT.
- PROVIDE TEMPORARY PROTECTION FROM THE WEATHER FOR EXPOSED STRUCTURE.
- PROVIDE BARRICADES AND SIGNAGE AT WORK AREAS TO PREVENT THE PUBLIC FROM ENTERING AREAS OF WORK.
- DIMENSIONS ARE FROM FACE OF STUD OR FROM FACE OF CMU WALL UNLESS NOTED OTHERWISE.
- COORDINATE THE TIMING AND SEQUENCE OF WORK WITH OWNER AND THE APPROPRIATE AUTHORITIES.
- DISRUPTIVE WORK: DISRUPTIVE/NOISY WORK SHALL BE PERFORMED AS DIRECTED BY THE OWNER.
- IT IS UNKNOWN IF HAZARDOUS MATERIALS ARE PRESENT WITHIN THE SCOPE OF WORK AREA. TESTING HAS NOT BEEN PERFORMED. IF SUSPECTED MATERIALS ARE ENCOUNTERED, NOTIFY THE OWNER PRIOR TO COMMENCING WORK.
- START SITE WORK NO EARLIER THAN 14 MAY, 2018. COMPLETION DATE FOR THE PROJECT IS NO LATER THAN AUGUST, 2018.

ABBREVIATIONS

⊙	AT	IBC	INTERNATIONAL BUILDING CODE
&	AND	INSUL	INSULATION
#	NUMBER	IRC	INTERNATIONAL RESIDENTIAL CODE
±	PLUS OR MINUS	JAN	JANITOR
ALUM	ALUMINUM	LF	LINEAR FEET
ADJ	ADJACENT	LLH	LONG LEG HORIZONTAL
ADA	AMERICANS WITH DISABILITIES ACT	MAX	MAXIMUM
APA	AMERICAN PLYWOOD ASSOCIATION	MDF	MEDIUM DENSITY FIBERBOARD
BD	BOARD	MECH	MECHANICAL
BL	BORROWED LITE	MFR'S	MANUFACTURER'S
BLDG	BUILDING	MIN	MINIMUM
CLG	CEILING	MR	MOISTURE RESISTANCE
CMU	CONCRETE MASONRY UNIT	MTL	METAL
COL	COLUMN	N	NORTH
CONC	CONCRETE	NIC	NOT IN CONTRACT
CONT	CONTINUOUS	OC	ON CENTER
CORR	CORRIDOR	PNT	PAINT
COORD	COORDINATE	PLYWD	PLYWOOD
CPT	CARPET	PT	PRESSURE TREATED
CWT	CERAMIC WALL TILE	RCB	RUBBER COVE BASE
DIA	DIAMETER	RCP	REFLECTED CEILING PLAN
DN	DOWN	REINF	REINFORCED
DWG	DRAWING	RM	ROOM
ELEC	ELECTRICAL	RWB	RUBBER WALL BASE
ELEV	ELEVATION	SF	SQUARE FEET
EPDM	ETHYLENE PROPYLENE DIENE MONOMER	SIM	SIMILAR
EQUIP	EQUIPMENT	SQ	SQUARE
ETC	ET CETERA	SS	STAINLESS STEEL
EXIST	EXISTING	STL	STEEL
EXT	EXTERIOR	STRUCT	STRUCTURAL
EWC	ELECTRIC WATER COOLER	SYS	SYSTEM
FDN	FOUNDATION	T&G	TONGUE AND GROOVE
FIXT	FIXTURE	TYP	TYPICAL
GA	GALVANIZED	UNO	UNLESS NOTED OTHERWISE
GYP BD	GYP SUM BOARD	VCT	VINYL COMPOSITION TILE
H,HGT	HEIGHT	VERT	VERTICAL
HORIZ	HORIZONTAL	W/	WITH
HAZ MAT	HAZARDOUS MATERIALS	WD	WOOD
HR	HOUR		

LEGEND

	DETAIL NUMBER
	SHEET WHERE DETAIL IS DRAWN
	SHEETS WHERE DETAIL IS TAKEN
	INDICATES DIRECTION OF CUTTING PLANE
	WALL SECTION OR ELEVATION NUMBER
	SHEET WHERE WALL SECTION OR ELEVATION IS DRAWN
	SHEETS WHERE WALL SECTION OR ELEVATION IS TAKEN
	INDICATES DIRECTION OF CUTTING PLANE
	BUILDING SECTION LETTER
	SHEET WHERE BUILDING SECTION IS DRAWN
	SHEETS WHERE BUILDING SECTION IS TAKEN
	OFFICE
	ROOM NAME AND NUMBER
	DOOR NUMBER
	WALL TYPE
	BORROWED LITE
	ELEVATION OR VERTICAL HEIGHT TARGET
	KEYNOTE
	DETAIL NUMBER
	SYSTEM
	SHEET NUMBER WHERE DETAIL IS DRAWN
	INTERIOR ELEVATION NUMBERS
	SHEET NUMBER WHERE INTERIOR ELEVATIONS ARE DRAWN

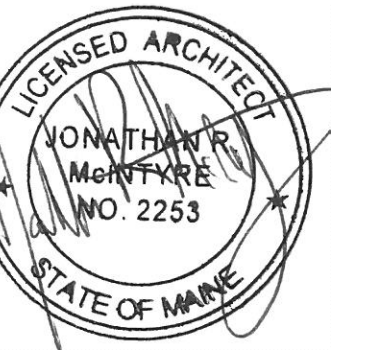

JMC
CRR
JMC
DESIGNED BY:
DRAWN BY:
CHECKED BY:
PROJECT: 21702.01

UNIVERSITY OF SOUTHERN MAINE
COLLEGE OF EDUCATION AND HUMAN DEVELOPMENT
Portland, ME 04104

LECTURE HALL RENOVATION AND UPGRADES
PAYSON SMITH HALL
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TITLE SHEET

SCALE: AS NOTED
DATE: 01-09-18
DWG.: G-001
SHEET: 1 OF 17