### DISPLAY THIS CARD ON PRINCIPAL FRONTAGE OF WORK



## CITY OF PORTLAND BUILDING PERMIT



This is to certify that University of Maine

Located At 96 FALMOUTH ST

Job ID: 2012-10-5289-ALTCOMM

CBL: 114A- A-001-001

has permission for Interior renovations to second floor (Honors Center/ Lounge).

provided that the person or persons, firm or corporation accepting this permit shall comply with all of the provisions of the Statues of Maine and of the Ordinances of the City of Portland regulating the construction, maintenance and use of the buildings and structures, and of the application on file in the department.

Notification of inspection and written permission procured before this building or part thereof is lathed or otherwise closed-in. 48 HOUR NOTICE IS REQUIRED.

A final inspection must be completed by owner before this building or part thereof is occupied. If a certificate of occupancy is required, it must be

11/29/2012

**Fire Prevention Officer** 

Code Enforcement Officer / Plan Reviewer

THIS CARD MUST BE POSTED ON THE STREET SIDE OF THE PROPERTY PENALTY FOR REMOVING THIS CARD

### **BUILDING PERMIT INSPECTION PROCEDURES**

Please call 874-8703 or 874-8693 (ONLY)

or email: buildinginspections@portlandmaine.gov

With the issuance of this permit, the owner, builder or their designee is required to provide adequate notice to the city of Portland Inspections Services for the following inspections. Appointments must be requested 48 to 72 hours in advance of the required inspection. The inspection date will need to be confirmed by this office.

- Please read the conditions of approval that is attached to this permit!! Contact this
  office if you have any questions.
- Permits expire in 6 months. If the project is not started or ceases for 6 months.
- If the inspection requirements are not followed as stated below additional fees may be incurred due to the issuance of a "Stop Work Order" and subsequent release to continue.
- 1. Close In Elec/Plmb/Frame prior to insulate or gypsum
- 2. Final Inspection

The project cannot move to the next phase prior to the required inspection and approval to continue, REGARDLESS OF THE NOTICE OF CIRCUMSTANCES.

IF THE PERMIT REQUIRES A CERTIFICATE OF OCCUPANCY, IT MUST BE PAID FOR AND ISSUED TO THE OWNER OR DESIGNEE BEFORE THE SPACE MAY BE OCCUPIED.



# PORTLAND MAINE

Strengthening a Remarkable City, Building a Community for Life . www.portlandmaine.gov

Director of Planning and Urban Development Jeff Levine

Job ID: 2012-10-5289-ALTCOMM Located At: 96 FALMOUTH ST CBL: 114A- A-001-001

### **Conditions of Approval:**

**Building** 

- 1. Separate permits are required for any electrical: plumbing, sprinkler, fire alarm, HVAC systems, commercial hood exhaust systems and fuel tanks. Separate plans may need to be submitted for approval as a part of this process.
- 2. Interior wall and ceiling finish requirements by occupancy shall comply with Table 803.9.
- 3. Ventilation of this space is required per ASRAE 62.2, 2007 edition.
- 4. Note: Plans indicate "20-Minute Fire Door" see the table below for "1-hour" required assembly rating minimal corridor fire door and shutter assembly ratings.

TABLE 715.4
FIRE DOOR AND FIRE SHUTTER FIRE PROTECTION RATINGS

TYPE OF ASSEMBLY	REQUIRED ASSEMBLY RATING (hours)	MINIMUM FIRE DOOR AND FIRE SHUTTER ASSEMBLY RATING (hours)
****	4	3
Fire walls and fire barriers having a required fire-resistance	3	3ª
rating greater than I hour	2	11/2
	11/2	11/2
Fire barriers having a required fire-resistance rating of 1 hour: Shaft, exit enclosure and exit passageway walls	. 1	1
Other fire barriers	1	3/4
Pire partitions:		4.5
Corridor walls		1/3 6
	0.5	1/3 b 3/4
Other fire partitions	1	1/3
NA ALOP	0.5	
	3	11/2
Exterior walls	2	11/2
	1	3/4
Smuke barriers	1	1/3 b

a. Two doors, each with a fire protection rating of 1<sup>1</sup>/2, hours, installed on opposite sides of the same opening in a fire wall, shall be deemed equivalent in fire protection rating to one 3-hour fire door.

b. For testing requirements, see Section 715.4.3.

### Fire

- 1. All construction shall comply with City Code Chapter 10.
- 2. This permit is being approved on the basis of the plans submitted. Any deviation from the plans would require amendments and approval.
- 3. All outstanding code violations shall be corrected prior to final inspection.
- 4. Central Station monitoring for addressable fire alarm systems shall be by point.
- 5. The fire alarm system shall be reviewed by a licensed contractor for code compliance. Compliance letters are required.
- 6. A separate Fire Alarm Permit is required for new systems; or for work effecting more than 5 fire alarm devices; replacement of a fire alarm panel with a different model; or installation of a master box. This review does not include approval of fire alarm system design or installation.
- 7. Fire Alarm system shall be maintained. If system is to be off line over 4 hours a fire watch shall be in place. Dispatch notification required 874-8576.
- Fire alarm system requires a master box connection per city ordinance. Master box design and installation shall in conformance with Fire Department Regulations and approved by Fire Department Electrical Division.
- 9. The building requires a Knox Box per city ordinance.
- 10. Fire extinguishers are required per NFPA 1.
- 11. All means of egress to remain accessible at all times.
- 12. Emergency lights and exit signs are required. Emergency lights and exit signs are required to be labeled in relation to the panel and circuit and on the same circuit as the lighting for the area they serve.
- 13. Any cutting and welding done will require a Hot Work Permit from Fire Department.
- 14. Walls in structure are to be labeled according to fire resistance rating. IE; 1 hr. / 2 hr. / smoke proof.
- 15. A single source supplier should be used for all through penetrations.
- Non-combustible construction of this structure requires all construction to be Noncombustible.

### City of Portland, Maine - Building or Use Permit Application 389 Congress Street, 04101 Tel: (207) 874-8703, FAX: (207) 8716

Job No: 2012-10-5289-ALTCOMM	Date Applied: 10/26/2012		CBL: 114A- A-001-001			
Location of Construction: 85 BEDFORD ST – 2 <sup>RD</sup> FLOOR	BEDFORD ST – 2 <sup>ND</sup> FLOOR UNIVERSITY OF SOUTHERN MAINE  usiness Name: Contractor Name:		Owner Address: 107 MAINE AVE BANGOR, ME 04401  Contractor Address: 96 Falmouth Street, Portland, ME 04104			Phone:
Business Name: Luther Bonney Hall						Phone: 780-4751
Lessee/Buyer's Name:	Phone:		Permit Type: BLDG ALT			Zone: R-5 & USM overlay
Past Use: University – Luther	Proposed Use:  Same: University – t		Cost of Work: \$75,000.00			CEO District:
Bonney Hall	alterations on the 2 <sup>nd</sup> Luther Bonney Hail plans		Fire Dept:	Approved (Denied N/A	of conditions	Inspection: Use Group: S Type: II ISC, Accep (AUSEC) Signature:
Proposed Project Description interior renovations to create departments			Pedestrian Activ	ties District (P.A	.D.)	
Permit Taken By: Gayle				Zoning Appr	oval	
1. This permit application of Applicant(s) from meeting Federal Rules.  2. Building Permits do not septic or electrial work.  3. Building permits are voice within six (6) months of False informatin may investigate permit and stop all work.  ereby certify that I am the owner of recover to make this application as his application is issued, I certify that the	include plumbing, d if work is not started the date of issuance. validate a building  record of the named property, is authorized agent and I agree	Shoreland Wetland Flood Zo Subdivis Site Plan  Maj Date: CERTIF or that the prope to conform to	one ion  MinMM  29/12  ICATION  cosed work is authorized all applicable laws of the	nis jurisdiction. In add	Not in Dis  Does not la  Requires la  Approved  Approved  Denied  Date:	st or Landmark Require Review Review  w/Conditions authorized by rk described in
enforce the provision of the code(s) a			,		,,	

12-5-12 DWM Rob 699-9030 Below grid walls OK.
Provide The construction to deck above

12-7-17 DWM Mark Lee 784-5100 Consult.

1-4-13 DWM/BKL/HA John Mardell fire Cail FOOK
1-7-13 DWM/BKL/ John Mardel Rob Fire & Elec Gall TOOOK
Adam 699-9198

# PREZ 01 010 G Josephi

General Building Permit Application

If you or the property owner owes real estate or personal property taxes or user charges on any property within the City, payment arrangements must be made before permits of any kind are accepted.

Total Square Footage of Proposed Structure/A 2,500 SF Renovation	rd Street 85 Bodford  Lifea Square Footage of Lot N/A	
Tax Assessor's Chart, Block & Lot Chart# Block# Lot# G8SW/F8NW 114A A001	Applicant *must be owner, Lessee or Buyer  Name University of Southern Ma c/o Adam Thibodeau  Address 96 Falmouth Street  City, State & Zip Portland, Maine 04104	1 ~
Lessee/DBA (If Applicable)	Owner (if different from Applicant)	Cost Of
RECEIVED	Name	Work: \$ 75,000.00
11202112	Address	C of O Fee: \$ 75.00
OCT 2 6 2012	City, State & Zip	Total Fee: \$ 845.00
Current legal use the single family Maine Busin If vacant, what was the previous use?		, A 1/1/0" ) [
Proposed Specific use:  Is property part of a subdivision?		Mr Flod
Project description: Minor interior renovation t		
	s corridor to improve occupant safety. Removal create classroom from two separate rooms.	of
	create classroom from two separate rooms.	
Contractor's name: Not yet selected		
Address:		
City, State & Zip		lephone:
Who should we contact when the permit is rea		
Mailing address:	•	
		Toilue to
Please submit all of the information	automatic denial of your permit.	st. ranure to
do so will result in the	automatic ucinar or your permit.	
order to be sure the City fully understands the y request additional information prior to the is s form and other applications visit the Inspectivision office, room 315 City Hall or call 874-8703.	suance of a permit. For further information o	to download copies of
ereby certify that I am the Owner of record of the retail I have been authorized by the owner to make this		o conform to all applicable

This is not a permit; you may not commence ANY work until the permit is issue



### Certificate of Design

Date:	October 17, 2012
From:	Harriman - Mark D. Lee, AIA
These plans and / o	r specifications covering construction work on:
USM Luther Bonney Ha	all 2nd Floor Renovation
0	and drawn up by the undersigned, a Maine registered Architect / to the 2003 International Building Code and local amendments.
★ D. LEE #3640	Signature:
OF ALE OF WAINE	Title: Mark D. Lee, AIA
(SEAL)	Firm: Harriman
	Address: 46 Harriman Drive

For more information or to download this form and other permit applications visit the Inspections Division on our website at www.portlandmaine.gov

Phone:

Auburn, Maine 04210

207-784-5100

### City of Portland General Building Permit Application Fire Department Requirements

Name of Applicant: University of Southern Maine Adam Thibodeau, Director of Engineering and Architectural Services 25 Bedford Street, Portland, ME 04104

Name of Architect: Mark D. Lee, AIA Harriman 46 Harriman Drive Auburn, ME 04210

Name of Project
USM Luther Bonney Hall 2<sup>nd</sup> Floor Renovation
Portland, Maine

Proposed use of structure: Business Existing Business Occupancy (NFPA 101 Chapter 39) Business (IEBC)

Square footage of proposed structure (total and per story): 2,500 SF interior renovation to 2<sup>nd</sup> floor of existing structure

Existing and proposed fire protection of structure:

Building is partially sprinkled. Portion of building where renovation is occurring is not sprinkled. This is separated from the sprinkled portion of the building. Renovation improves egress protection of occupants by creating a fire rated corridor to the stair exit

See included Life Safety Plan for the following items:

Fire Resistance ratings of all Means of Egress
Travel Distance from most remote point to exit discharge
Location of any required fire extinguishers
Location of emergency Lighting
Location of Fire Alarm devices
Location of exit signs
NFPA 101 code summary



### Certificate of Design Application

From Designer:	Harriman - Mark D. Lee, AIA
Date:	October 17, 2012
Job Name:	USM Luther Bonney Hall 2nd Floor Renovation
Address of Construction:	88 Bedford Street, Portland, Maine 04104

### 2003 International Building Code

Construction project was designed to the building code criteria listed below:

Building Code & Year <u>IBC/IEBC/NFPA</u> Use Group Classification (	s) Business
Type of Construction II Unprotected (0,0,0)	
Will the Structure have a Fire suppression system in Accordance with Sec	ction 903.3.1 of the 2003 IRC N/A - Not a residence
Is the Structure mixed use? No If yes, separated or non separa	ated or non separated (section 302.3)
	uired? (See Section 1802.2)
drawing A02.1 for FA devices in area of work. Structural Design Calculations	Live load reduction
Submitted for all structural members (106.1 – 106.11)	Roof live loads (1603.1.2, 1607.11)
	Roof snow loads (1603.7.3, 1608)
Design Loads on Construction Documents (1603) Uniformly distributed floor live loads (7603.11, 1807)	Ground snow load, Pg (1608.2)
Floor Area Use Loads Shown	If Pg > 10 psf, flat-roof snow load pf
	If $Pg > 10$ psf, snow exposure factor, $C_0$
	If $Pg > 10$ psf, snow load importance factor, $I_f$
	Roof thermal factor, (1608.4)
	Sloped roof snowload,p <sub>2</sub> (1608.4)
Wind loads (1603.1.4, 1609)	Seismic design category (1616.3)
Design option utilized (1609.1.1, 1609.6)	Basic seismic force resisting system (1617.6.2)
Basic wind speed (1809.3)	Response modification coefficient, and
Building category and wind importance Factor, but table 1604.5, 1609.5)	deflection amplification factor (1617.6.2)
Wind exposure category (1609.4)	Analysis procedure (1616.6, 1617.5)
Internal pressure coefficient (ASCE 7)	Design base shear (1617.4, 16175.5.1)
Component and cladding pressures (1609.1.1, 1609.6.2.2)	Flood loads (1803.1.6, 1612)
Main force wind pressures (7603.1.1, 1609.6.2.1)	
Earth design data (1603.1.5, 1614-1623)	Flood Hazard area (1612.3)
Design option utilized (1614.1)	Elevation of structure
Seismic use group ("Category")	Other loads
Spectral response coefficients, SDs & SD1 (1615.1)	Concentrated loads (1607.4)
Site class (1615.1.5)	Partition loads (1607.5)
	Misc. loads (Table 1607.8, 1607.6.1, 1607.7, 1607.12, 1607.13, 1610, 1611, 2404



# PORTLAND MAINE

Strengthening a Remarkable City, Building a Community for Life . www.portlandmaine.gov

D .		D	. •1
Recei	nts	De	tails:

Tender Information: Check, BusinessName: Harriman, Check Number: 163626

Tender Amount: 845.00

Receipt Header:

Cashier Id: gguertin Receipt Date: 10/26/2012 Receipt Number: 49736

Receipt Details:

Referance ID:	8551	Fee Type:	BP-Constr
Receipt Number:	0	Payment Date:	
Transaction Amount:	770.00	Charge Amount:	770.00
Job ID: Job ID: 201	L 2-10-5289-ALTCOMM - interior renovations to cre	eate department	suite

Additional Comments: Harriman

Referance ID:	8558	Fee Type:	BP-C of O
Receipt Number:	0	Payment	
•		Date:	
Transaction	75.00	Charge	75.00
Amount:		Amount:	

### HARRIMAN

Harriman | Auburn Business Park 46 Harriman Drive Auburn, Maine 04210 United States

### **Transmittal**

ID:

00012

Date Sent:

11/13/2012

**Project:** 

USM Luther Bonney Hall Second Floor Renovation

**Number:** 

12677

To:

Jonathan Rioux

City of Portland / Planning Division

United States 874-8702 (Phone)

From:

Eric Potvin

Harriman

Auburn Business Park 46 Harriman Drive Auburn, Maine 04210

United States

207-784-5100 (Phone) 207-782-3017 (Fax)

Subject:

Section Through Corridor

Via:

Info Exchange

Purpose:

As requested

Remarks:

Please find SK01 attached. (Section through Corridor) As requested. I will call

to follow up. Let us know if you need any further information.

Thank you,

CC:

Mark Lee(Harriman)

Adam L. Thibodeau LEED AP(University of Southern Maine)

### **Description of Contents**

Quantity	Title	Number	Date	Scale	Size	Revision
1	SK01-SECTION THROUGH CORRIDOR.pdf		11/13/2012			

### Jonathan Rioux - 12677: USM Luther Bonney Hall Second Floor Renovation - File Transfer - Section Through Corridor

From:

"Eric Potvin" <epotvin@harriman.com>

To:

<JRioux@PortlandMaine.gov>

Date:

11/13/2012 10:01 AM

Subject:

12677: USM Luther Bonney Hall Second Floor Renovation - File

Transfer - Section Through Corridor

Attachments: Transmittal - 00012.pdf

IMPORTANT: Click a link below to access files associated with this transmittal that came in through the Harriman Info Exchange web site. The attached file contains the transmittal details.

### Click here to download associated files

**Project Name:** 

USM Luther Bonney Hall Second Floor Renovation

**Project Number:** 

12677

From:

Eric Potvin (Harriman)

To:

Jonathan Rioux (City of Portland / Planning Division)

CC:

Mark Lee (Harriman); Adam L. Thibodeau LEED AP (University of Southern

Maine)

Subject:

Section Through Corridor

Sent via: **Expiration Date:**  Info Exchange 11/27/2012

Remarks:

Please find SK01 attached. (Section through Corridor) As requested. I will call to follow up. Let us know if you need any further information.

Thank you,

#### **Transferred Files**

Name	Туре	Date	Time	Size
SK01-SECTION THROUGH CORRIDOR.pdf	PDF File	11/13/2012	9:53 AM	25 KB


To share and learn more about Newforma Info Exchange visit www.newformant.com



### Accessibility Building Code Certificate

Designer:	Harriman - Mark D. Lee, AIA	
Address of Project:	88 Bedford Street, Portland Maine (USM Luther Bonney Hall 2nd Floor)	
Nature of Project:	Minor interior renovation to create department suite for the Honors Program.	
,	Creation of rated exit access corridor to improve occupant safety. Removal of non-load bearing wall to a create classroom from two separate rooms.	

The technical submissions covering the proposed construction work as described above have been designed in compliance with applicable referenced standards found in the Maine Human Rights Law and Federal Americans with Disability Act. Residential Buildings with 4 units or more must conform to the Federal Fair Housing Accessibility Standards. Please provide proof of compliance if

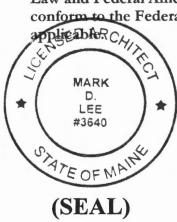

Signature:

Title: Mark D. Lee, AIA


Firm: Harriman

Address: 46 Harriman Drive

Auburn, Maine 04210

Phone: 207-784-5100

For more information or to download this form and other permit applications visit the Inspections Division on our website at www.portlandmaine.gov

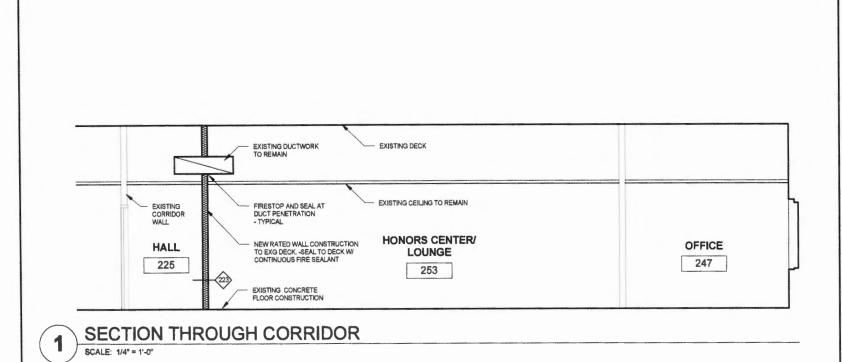

HARRIMAN

Architects + Enginee

Aubum. ME Portland, ME Manchester, NH www.harriman.com 207.784.5100 tel 207.775.0053 tel 603.626.1242 tel © 2012

Project Title

#### USM LUTHER BONNEY HALL 2ND FLOOR RENOVATION

Portland, Maine

HA Project No.

12677

11/13/12 ISSUED W/ BUILDING PERMIT APPLICATION

Date	11/13/12
Scale	1/4" = 1'-0"

Drawing Title

RECEIVED

NOV 1 3 2012

Dept. of Building Inspections City of Portland Maine SECTION THROUGH CORRIDOR

Drawing Number

**SK01** 



# Certificate of Occupancy

### CITY OF PORTLAND, MAINE



Department of Planning and Urban Development **Building Inspections Division** 

Location: 96 FALMOUTH ST

CBL: 114A A001001

Issued To: University Of Maine /Landry/French Construction Corp

Issued Date: 01/07/2013

This is to certify that the building, premises, or part thereof, at the above location, built-altered-changed as to use under Building Permit No. 201249721 has had a final inspection, has been found to conform substantially to the requirements of the Building Code and the Land Use Code of the City of Portland, and is hereby approved for occupancy or use, limited or otherwise, as indicated

### PORTION OF BUILDING OR PREMISES

LUTHER BONNEY HALL SECOND FLOOR HONORS CENTER/LOUNGE #253, CLASSROOM #237, AND TESTING/ SUPPLIES ROOMS #242C, #242D, & #242E

APPROVED OCCUPANCY

USE GROUP B TYPE 11-B UNIVERSITY IBC 2009 (MUBEC)

LIMITING CONDITIONS: LIMITING CONDITIONS: THIS IS A TEMPORARY CERTIFICATE OF OCCUPANCY AND IT EXPIRES

THE ENTIRE FIRE SYSTEM MUST PASS INSPECTION AND BE STICKERED;

THE BUILDING REQUIRES A WIRELESS MASTER BOX.

Approved:

Inspector

Inspection Division Director

Notice: This certificate identifies the legal use of the building or premises, and ought to be transferred from owner to owner upon the sale of the property.

### 114A ACOI

### HARRIMAN

Harriman | Auburn Business Park 46 Harriman Drive Auburn, Maine 04210 United States

### Transmittal

ID:

00029

Date Sent:

12/10/2012

Project: Number: USM Luther Bonney Hall Second Floor Renovation 12677

To:

Don McPherson

City of Portland / Planning Division

389 Congress Street 4th Floor

Portland, ME 04101

United States

From:

Mark Lee Harriman

Auburn Business Park

46 Harriman Drive Auburn, Maine 04210

United States

207-784-5100 (Phone) 207-782-3017 (Fax)

Subject:

Corridor Wall Continuity

Via:

Email

Purpose:

For your information

Remarks:

Don,

# USM LUTHER BONNEY HALL 2ND FLOOR RENOVATION

Portland, Maine

ISSUED FOR BID 10-15-12



Architects + Engineer

### LIST OF DRAWINGS



- TECTURAL DRAWNIGS
  COYER
  ASSREVATIONS
  CODE PLAN
  SECOND PLOOR DEMO PLAN AND SECOND PLOOR PLAN
  MATERNALS PLAN, REPLECTED CEILING PLAN AND SCHEDULES
  SCHEDULES, DETAILS AND SECTIONS






- (CAL LIGATINGS)
  ELECTRICAL LEGEND & LIGHTING FIXTURE SCHEDULE
  ELECTRICAL EXISTING CONDITIONS PART PLAN
  LIGHTING PART PLAN
  FRST FLOOR PLAN POWER




RECEIVED

MOV 1 9 2012

Dept. of Building Inspections City of Portland Maine

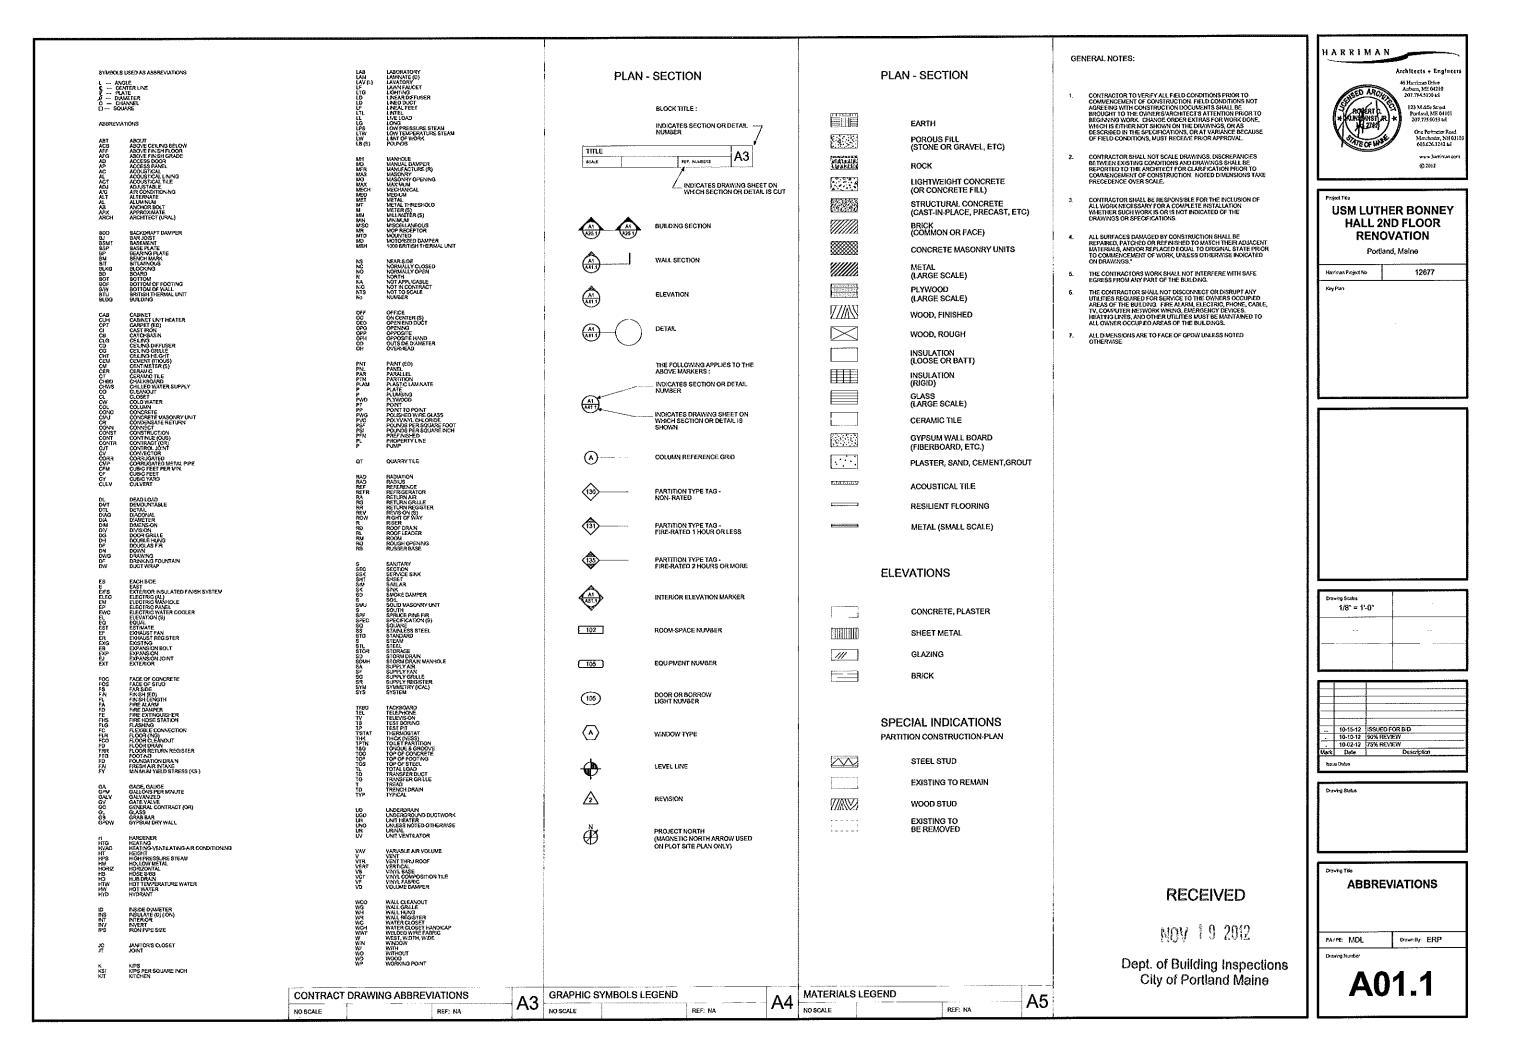

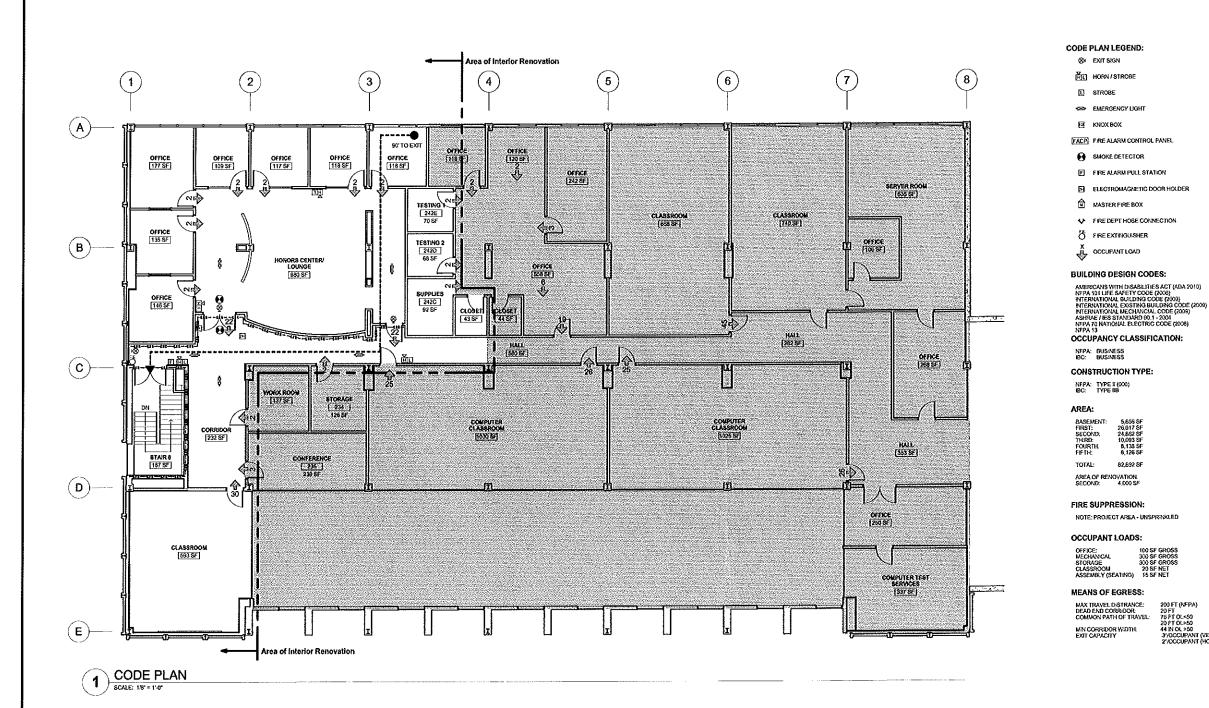



HARRIMAN

USM LUTHER BONNEY HALL 2ND FLOOR RENOVATION

Portland, Maine

RECEIVED

MOY 10 2012

Dept. of Building Inspections
City of Portland Maine

Onewing Scales 1/8" = 1'-0"

Issue Deley


82.892 SF


200 FT (NFPA) 20 FT 76 FT OL<50 20 FT OL-50 44 IN OL-50 3/30CUPANT (VERTICAL) 2/30CUPANT (HORIZ)


**CODE PLAN** 

Drawn By: ERP PAIPE: MDL


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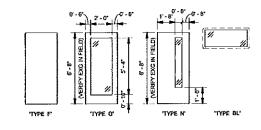


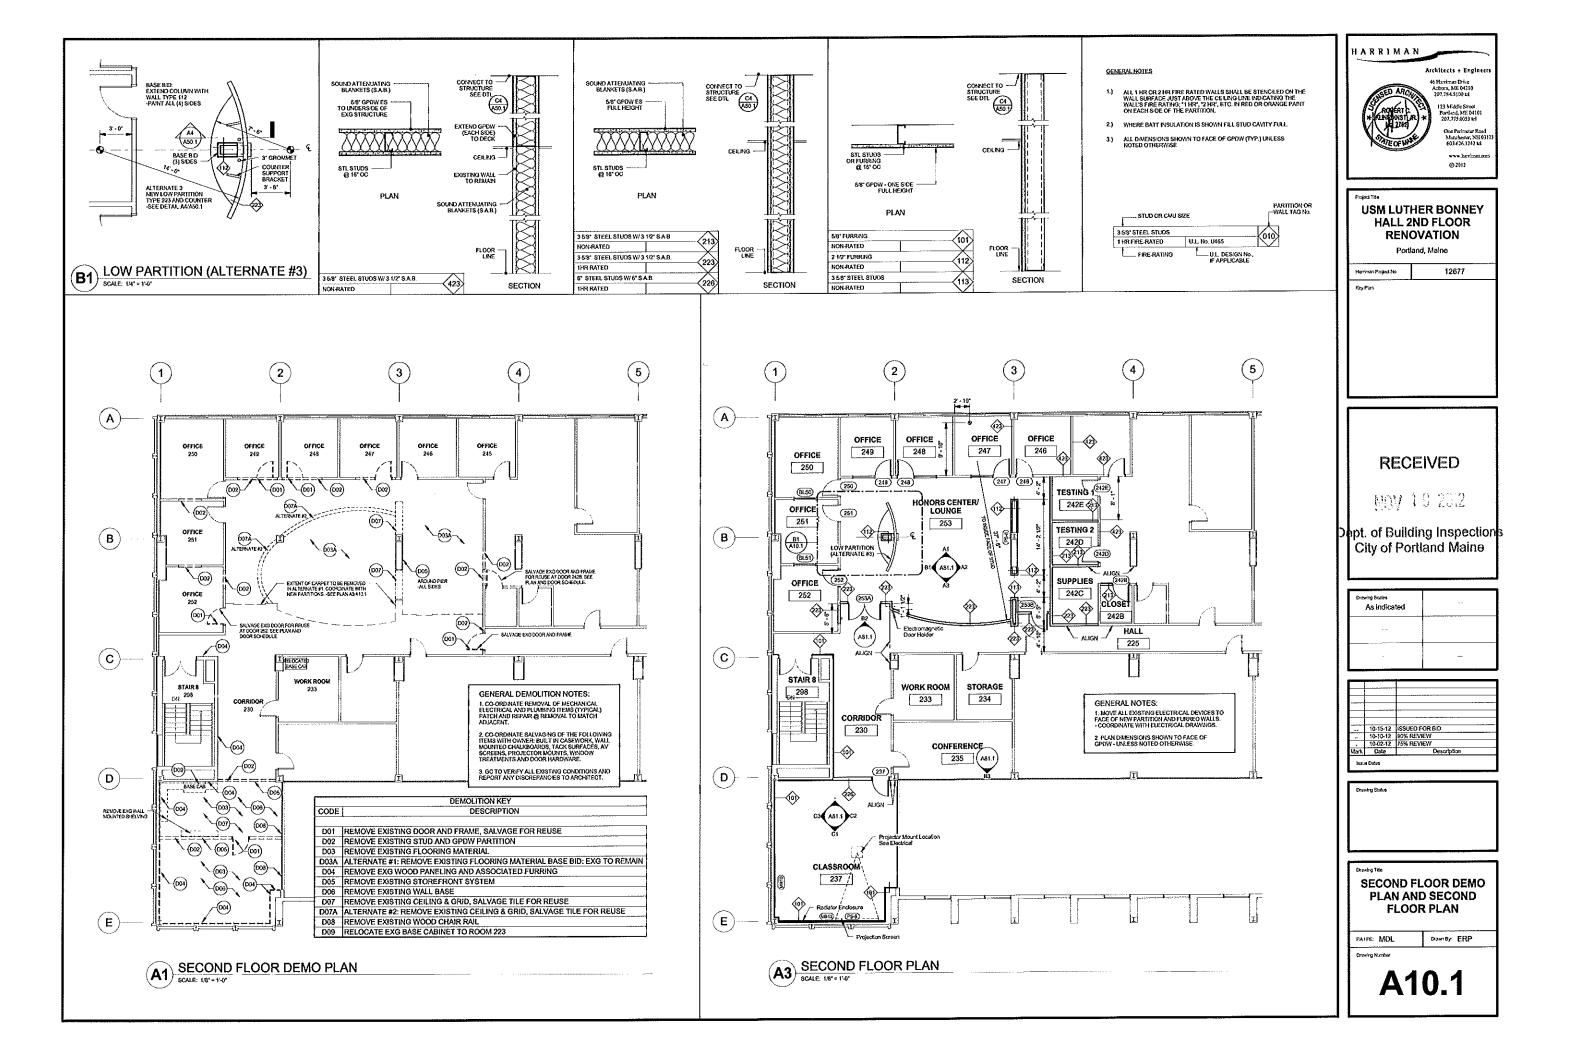

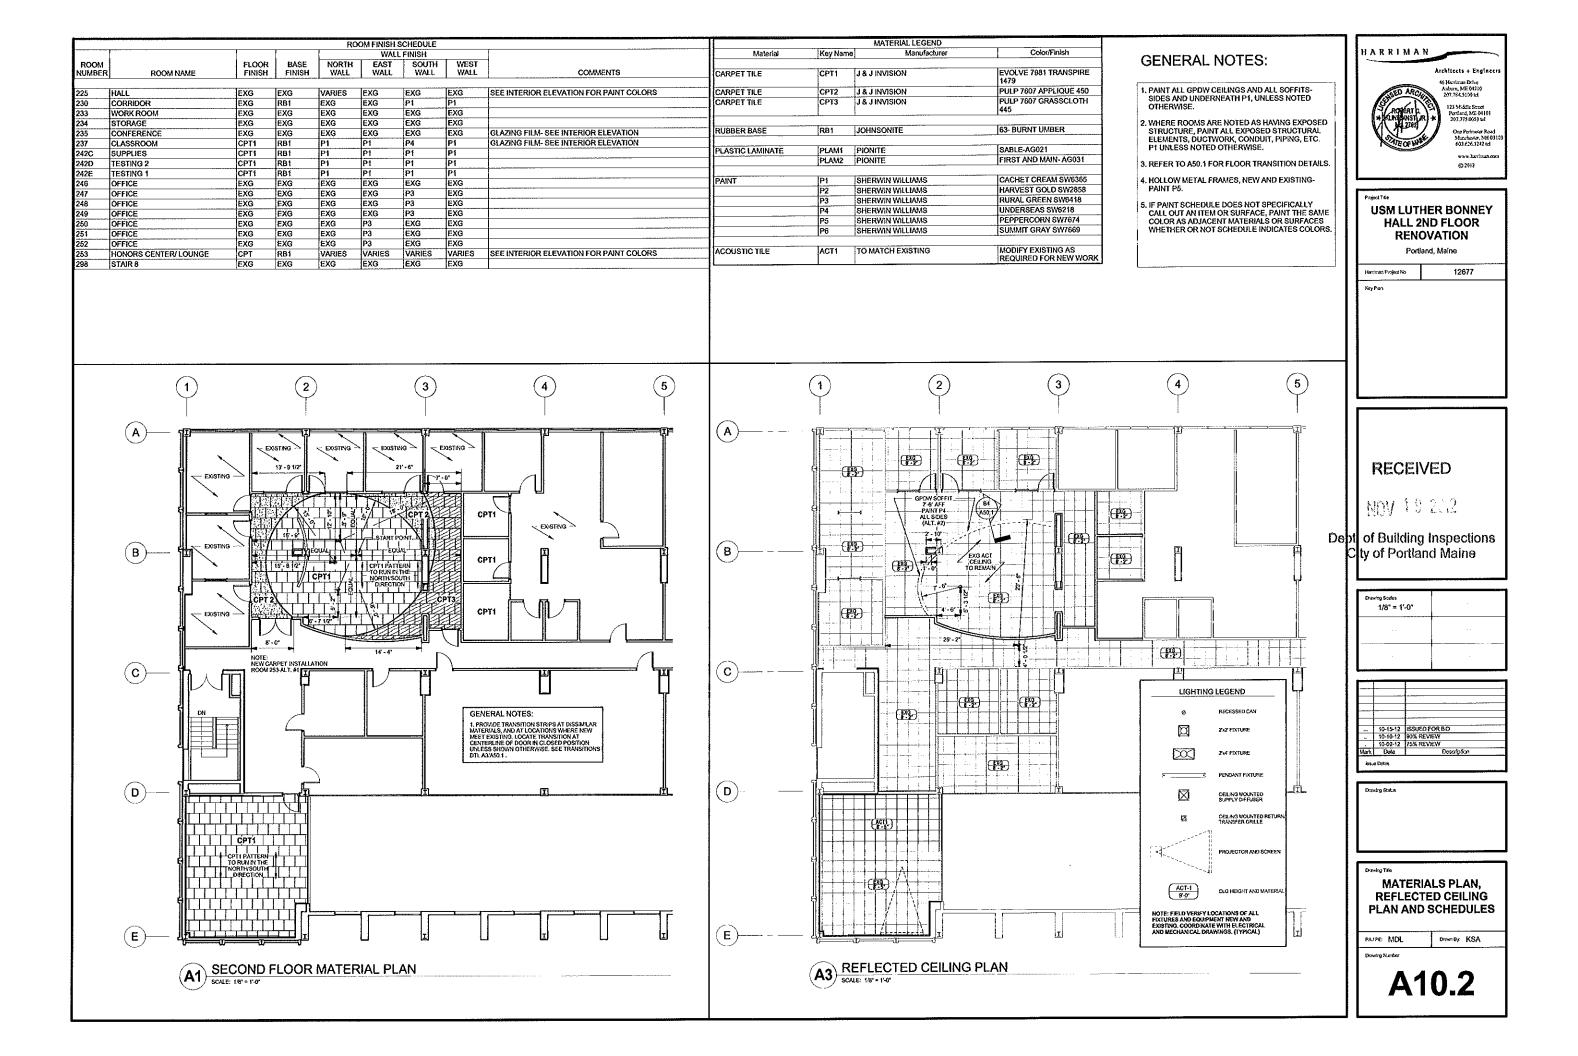


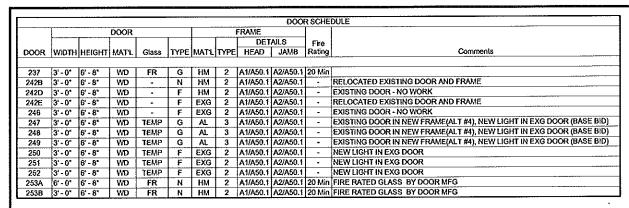I								ВО	RROWED	LIGHT S	SCHEDULE
ł		BORROWED LIGHT FRAME									
l			HEAD					DET	AILS	Fite	
I	DOOR	WIDTH	HEIGHT	GLASS	TYPE	MATL	TYPE	HEAD	JAMB	Rating	Comments
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ı	BL51	4' - 0"	7' - 0"	TEMP	BL	HM	1	B1/A50,1	A2/A50.1	-	




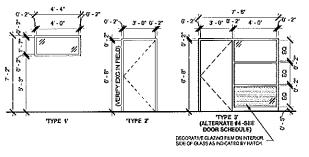




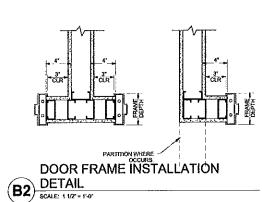


**DOOR TYPES** 

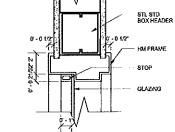




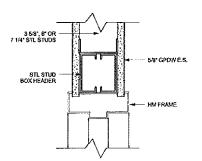




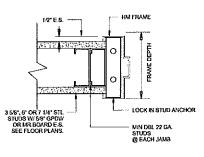


JAMB DETAIL @ STEEL STUD

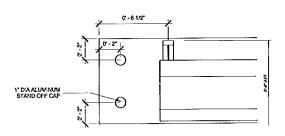


#### FRONT ELEVATION

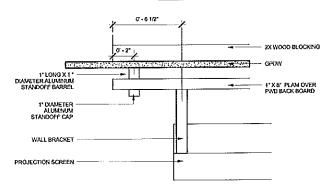

#### TOP SECTION

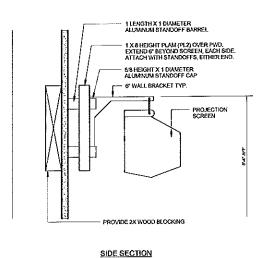





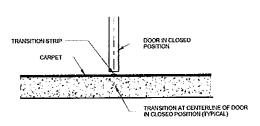


CARPET TO CARPET TRANSITION



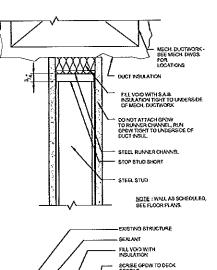


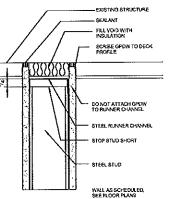

CONNECTION TO EXG STRUCTURE
SCALE 1107 = 1'07
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B4) DETAIL AT SOFFIT (ALT #2)

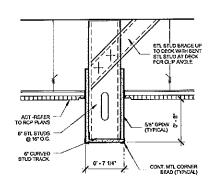

SECTION AT COUNTER (ALT #3)
SCALE: 34" = 1-0"

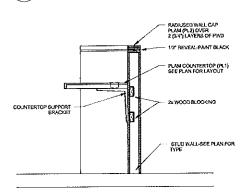



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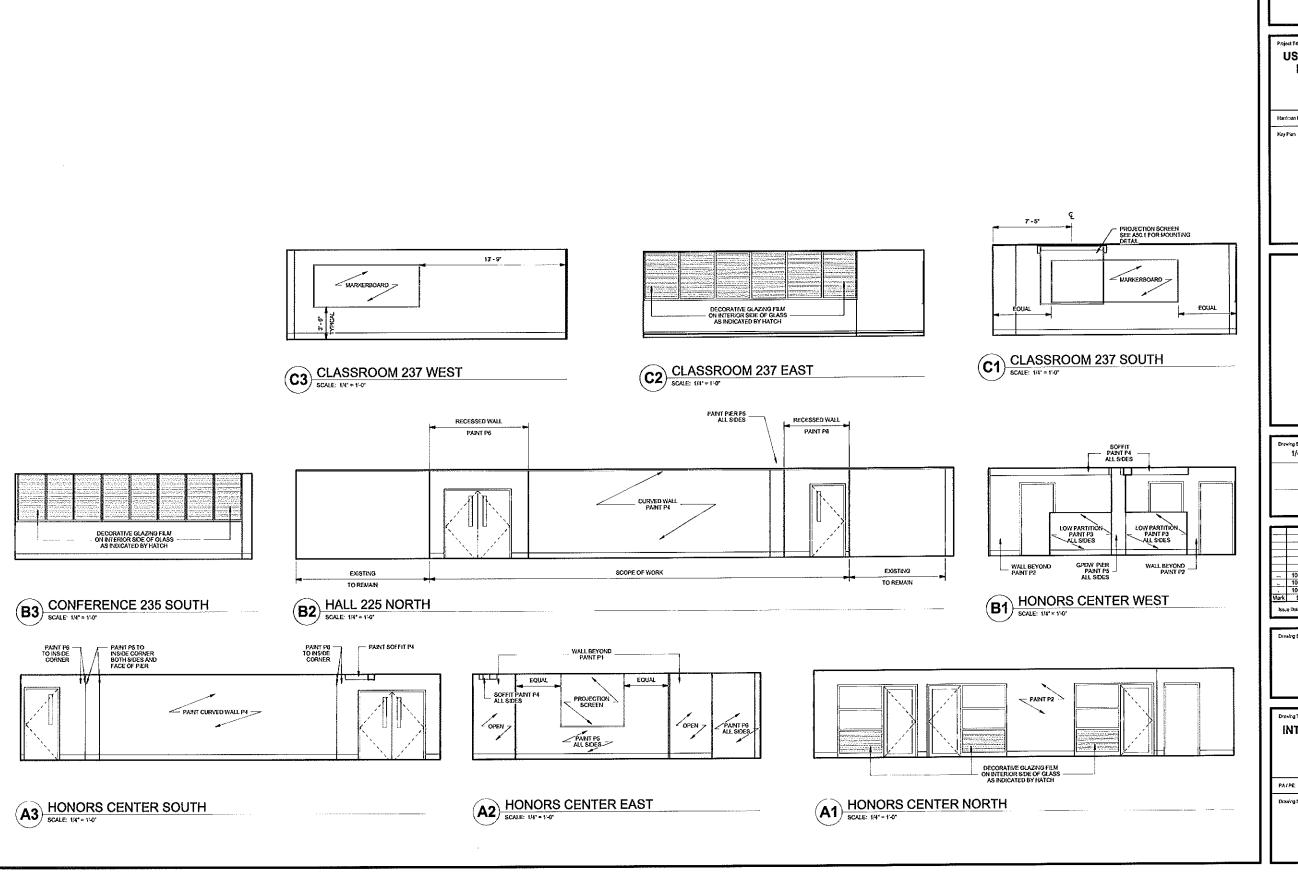
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USM LUTHER BONNEY
HALL 2ND FLOOR
RENOVATION

Portland, Maine

Harriman Project No

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12677

Draving Scales
1/4" = 1"-0"

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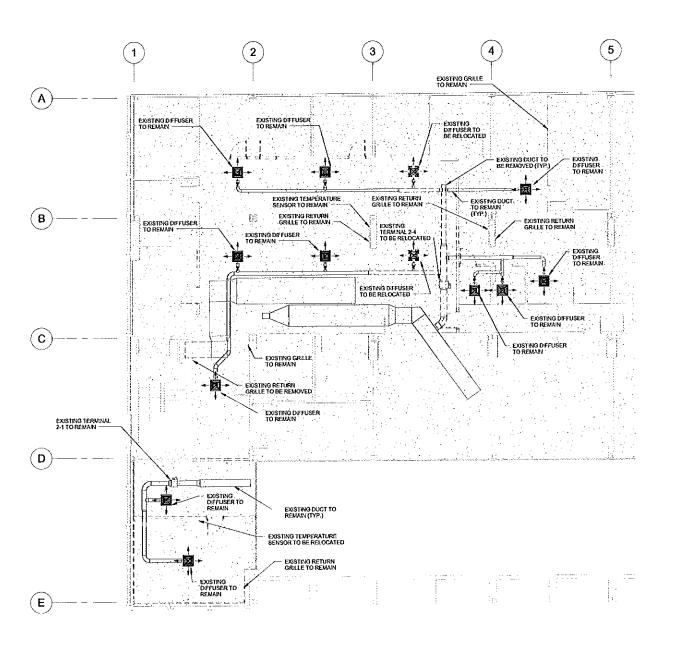
INTERIOR ELEVATIONS

PA/PE MDL

DL Draw By ERP

ring Number

A81.1



1 M05-2 Demolition Ductwork Level 2
SCALE: 18" = 1-0"



## USM LUTHER BONNEY HALL 2ND FLOOR RENOVATION

Portland, Maine

Herriman Project No 12677

Key Plan



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Drawing Scales 1/8" = 1'-0"	
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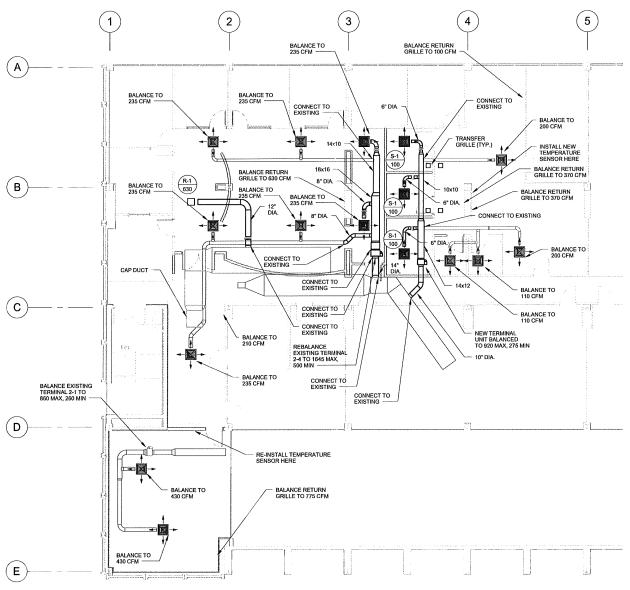
SECOND FLOOR DUCTWORK DEMOLITION

PAIPE CG

Drawn By. JSL


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M05.1



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1 M10-2 Ductwork Level 2
SCALE: 1/8" = 1'-0"



## USM LUTHER BONNEY HALL 2ND FLOOR RENOVATION

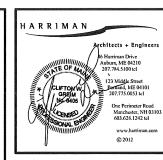Portland, Maine

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Drawing Scales 1/8" = 1'-0"	
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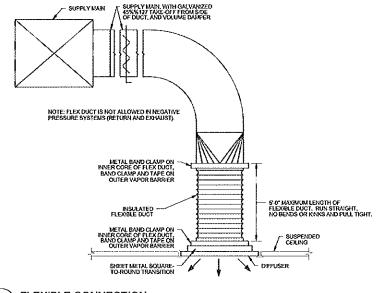
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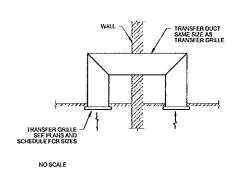
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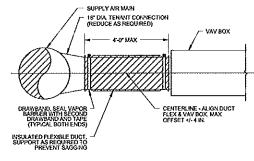
SECOND FLOOR DUCT

Drawn By: JSL

M10.1







NO SCALE

1 FLEXIBLE CONNECTION
NO SCALE

TRANSFER DUCT

TYPICAL VAV BOX CONNECTION
NO SCALE

	REGISTERS, GRILLES, AND DIFFUSERS												
TAG	MANUFACTURER	MODEL	ТҮРЕ	NECK SIZE (IN.)	DIRECTION OF BLOW	NC	SP (IN.WG)	THROW (FT)	TYPE	DAMPER	FINISH	BORDER	NOTES
s-t	TITUS	TD¢	CEILING DIFFUSER	6×8	SEE PLANS	23	0.15	7- 11		NONE	BAKED ENAMEL WHITE	TYPE 3 (24'x 24' LAY-IN)	
TRANSFER GRILLE	ттуş	50F	TRANSFER GRILLE	6x6		20	9,09		GRID CORE	NONE	BAKED ENAMEL WHITE	TYPE ( (ŞURFAÇE MOUNT)	1/2"×1/2"×1/2" GR(D
R-1	тптив	50F	RETURN GRILLE	14×14	***	20	D,09:	-4-	GRID CORE	NONE	BAKED ENAMEL WHITE	TYPE 1 (SURFACE MOUNT)	1/2'x1/2'x1/2" GRID

			VAV BOXES						
TĄĠ	MANUFACTURER	MODEL	SERVICE	INLET (IN.)	COOLING AIRFLOW (CFM)	MINIMUM AIRFLOW (CFM)	APD (IN. WG)	DISCHARGE NC	RADIATED NC
VAV00-01	METALAIRE	TH-500	242 SUITE	10	920	275	0.08	27	25

### **GENERAL NOTES**

1. VISIT THE BUILDING SITE PRIOR TO BEDONG TO BECOME FAULUAR WITH EXISTING CONDITIONS, AND TO TAKE MEASUREMENTS AS NECESSARY FOR COMPLETION OF THE WORK ASSOCIATED WITH THE DESIGN INTENT OF THESE CONTRACT DOCUMENTS.

COORD:NATE WORK OF MECHANICAL SUBCONTRACTOR WITH WORL OF OTHER TRADES.

3. EQUIPMENT AND DUCTWORK ARE DIAGRAMATIC. FIELD VERIFY LOCATIONS.

4. DOC BUILDING CONTROLS SHALL BE DELTA PROVIDED AND INSTALLED BY IB CONTROLS, 3 POPE ROAD, WINDHAM, ME. NO OTHER SUBSTITUTIONS WE FIRE PERMITTER.

5. IB CONTROLS SHALL PROVIDE A MINIMUM OF CAT 6 FOR ALL DATA CABLE.

6 TO CONTROLS SHALL INCLUDE ALL PROGRAMMING AND CHANGES TO THE EXISTING GRAPHIC INTERFACE AS NECESSARY TO ACCOMMODATE THE CHANGES AS NOTED ON THE DRAWNICS.

7. CONTROL SEQUENCE FOR THE NEW TERMINAL UNIT SHALL BE THE SAME AS THE EXISTING TERMINAL UNITS.

8. MOUNT TEMPERATURE SENSORS 48" AFF TO CENTERLINE OF ITEM.



Project Tele	
l usm	<b>LUTHER BONNE</b>
HA	LL 2ND FLOOR
	RENOVATION

Portland, Maine

Harriman Project No.	12677
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Dep. of Building Inspections lity of Portland Maine

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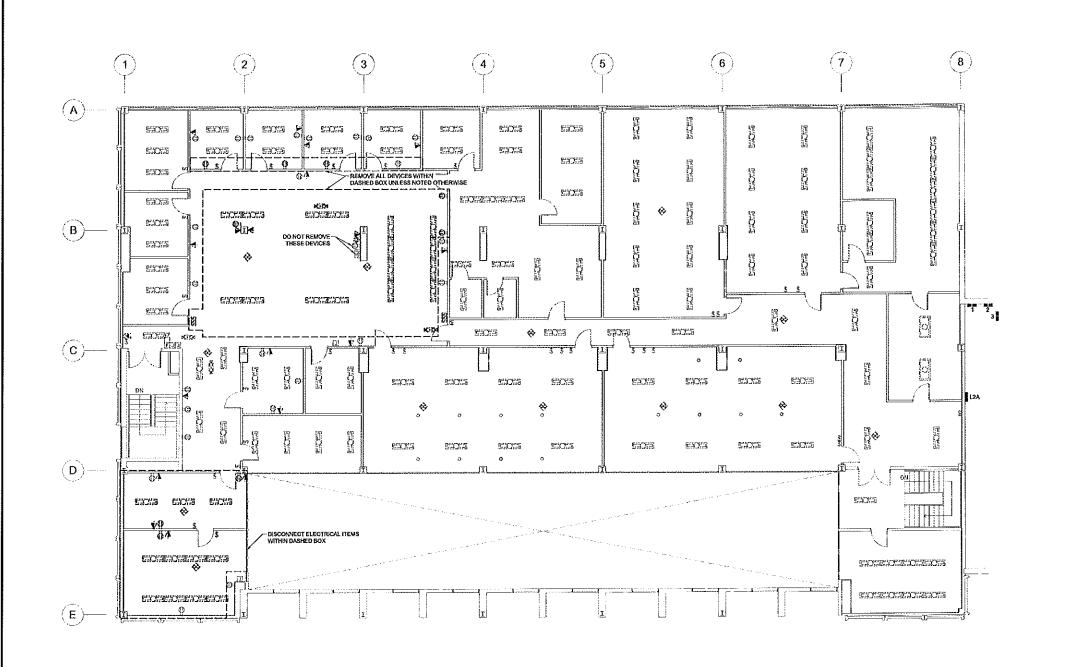
DETAILS, SCHEDULES
AND NOTES

PA/PE: CG

M30.1

Drawn By JSL

#### ARRIMAN **DEMOLITION NOTES** 1. ELECTRICAL INDICATED IS AS GENERALLY FOUND (JULY 2012). THE INTENT OF THE DEMOLITION PLANS ARE TO GOCUMENT SEPCIFIC EXISTING COMMITIONS. HOMEVER, NOT ALL ELECTRICAL DEVICES ARE NOICATED ON THE DEAMWISCS. CONTRACTOR SHALL FIELD VERIFY AND ADJUST WORK TO SUIT ALL FOUND. SEE MECHANICAL DRAWINGS FOR MECHANICAL EQUIPMENT TO BE REMOYED. COMPETELY REMOYE ALL ASSOCIATED CONDUIT, BOXES, WIRENO, ETC... Architects + Engine **ELECTRICAL LEGEND** 45 Harrieras Drive Auburn, ME 64210 207,784,5100 tel **EXISTING** 5. CONDUIT IN COOD CONDITION AND PROPERLY LOCATED MAY BE REUSED WHERE APPLICABLE. UNLESS NOTED OTHERWISE. HOMERUN TO PALBRD - ARROWS INDICATE NUMBER OF CRICHTS. CROSS LINES INDICATE NUMBER OF CONDUCTORS OTHER THAN TWO (PROVIDE NUMBER OF WIRES LP-1,3 **-( ← | | | ( EQUIPMENT LEGEND** 2. REFER TO NON-DEMO PLANS TO DETERMINE EXTENT OF WORK IN EACH AREA, INCLUDING WHETHER DEVICES ARE TO REMAY, BE REMOYED, REPLACED, ETC. EXCEPT AS NOTED, GENERALLY THE INTENT IS THAT IF EXISTING DEVICES ARE SHOWN ON THE EXISTING COMMINGS THAN AND NEW DEVICES ARE SHOWN ON THE RON-DEMO PLANS THEM EXISTING DEVICES ARE TO BE REMOYED OR REPLACED. IF EXISTING DEVICES ARE SHOWN ON 80TH THEN THE DEVICES ARE TO REMAIN. REQUIRED TO ALLOW SWITCHING SHOWN - E10 SERIES LIGHTING DRAWINGS) DASHED INDICATES EXISTING ELECTRICAL DEVICE / APPLIANCE ETO (REFER TO LEGEND FOR TYPE) 8. THE CONTRACTOR SHALL ARRANGE TO EXECUTE ALL WORK AT SUCH TIMES AND IN SUCH LOCATIONS TO PROVIDE UNINTERUPTED SERVICES FOR THE EXISTING BUILDING OR ANY OF ITS SECTIONS. IF NECESSARY, TEUPORARY WORK SHALL BE INSTALLED TO PROVIDE FOR THIS CONDITION AUTHORIZATION FOR INTERUPTING THE SERVICE SHALL BE OBTAINED IN WRITING FROM THE OWNER. CIRCUIT NUMBER(S) PANEL DESIGNATION WIRING CONCEALED IN WALL OR CEILING WIRING IN RACEWAY CONCEALED UNDER FLOOR @2012 - UG -WIRING IN RACEWAY CONCEALED UNDERGROUND 3. ALL EXISTING ITEMS INTENDED FOR REMOVAL SHALL BE REMOVED WITH ALL ASSOCIATED HARDWIARE INCLUDING, BUT NOT LIMITED TO: CONDUIT, BOXES, WIRING, CASIES, UNIVERSE ETC. - E -EXISTING WIRING **USM LUTHER BONNEY** RECESSED 2' X 4' HALL 2ND FLOOR RECESSED 2 X 2 RENOVATION RECESSED Z X Z LIFE SAFETY Portland, Maine **ELECTRICAL NOTES** RECESSED DOWN LIGHTING C1 Harriman Project No. 12677 RECESSED DOWN LIGHTING LIFE SAFETY Key Pan SURFACE MOUNTED 1'X 8' LIFE SAFETY LIGHTING FIXTURE SCHEDULE SINGLE POLE SWITCH - MOUNTED CALUP 48" UNLESS NOTED OTHERWISE - SUBLETTER ALL FIXTURES SHALL BE FURNISHED COMPLETE WITH ALL HARDWARE LAMPS, HANGERS, FITTINGS, ETC. FOR A COMPLETE AND PROPER INSTALLATION \$3 THREE WAY-SWITCH REMARKS/BALLAST INFORMATION VOLT MANUFACTURER CATALOG NO. NO. WATT TYPE \$ FOUR-WAY SWITCH ₩ WALL MOUNTED OCCUPANCY SENSOR SWITCH WC4-232-E-U UNIV 2 32 ♦ CEILING MOUNTED OCCUPANCY SENSOR SWITCH - SEE OCCUPANCY SENSOR CONTROL DIAGRAM THIS DRAWING STP14-232-MPO-ST-E-U UNIV 2 32 **(II)** POWERPOLE JUNCTION BOX NOT USED VOICE & DATA OUTLET - WALL BOX WITH TWO 1°C TO ABOVE AN ACCESS/BLE CEILING H RECEIVED MOUNTED C/L UP 48" UNLESS NOTED OTHERWIS ю DUPLEX CONVENIENCE RECEPTACLE - MOUNTED C/L UP 24" UNLESS NOTED OTHERWISE Ħ DOUBLE DUPLEX CONVENIENCE RECEPTACLE - MOUNTED CALUP 24" UNLESS NOTED HE, GFCI DUPLEX CONVENIENCE RECEPTACLE - MOUNTED C/L UP 48" UNLESS NOTED Dept. of Building Inspections • PUSH BUTTON City of Portland Maine LIFE SAFETY---LIGHTING FIXTURE SCHEDULE FIRE ALARM MANUAL PULL STATION - MOUNTED CALUP 48" B1 FIRE ALARM HORNALIGHT UNIT. CANDLE POWER (CD) PER NIFPA 72 AND AS NOTED-187/5 WHERE NOT OTHERWISE INDICATED ON PLANS - MOUNTED BOTTOM OF STROBE UP **2**4 FIRE ALARM STROBE LIGHT UNIT, CANDLE POWER (CD) PER NFPA 72 AND AS NOTEO -15/75 WHERE NOT OTHERWISE INDICATED ON PLANS - MOUNTED BOTTOM OF STROBE UP Drawing Scales $\square$ 4 FIRE ALARM HORN UNIT MASTER FIXTURE SATELLITE FIXTURE CONTROL OUTPUT FIRE ALARM SMOKE DETECTOR ADDITIONAL CEILING SENSOR(S) CONIMON \_\_\_\_ CONIMON \_\_\_\_ FIRE ALARM MANUAL PULL STATION +24VDG CEILING MOUNTED EXIT SIGN - DOUBLE FACE WALL MOUNTED EXIT SIGN - SINGLE FACE ю ENTROL OUTPUT 10004 CEILING RECESSED EMERGENCY BATTERY REMOTE LIGHT OMMON NONING 3 LAMP FIXTURE BALLAST CONFIGURATION GENERAL 24V00 £# KEYNOTE TAG MASTER FIXTURE SATELLITE EXTURE 10-15-12 ISSUED FOR 630 lass o Dedas 4 LAMP BALLAST 2 LAMP FIXTURE BALLAST CONFIGURATION who States SATELLITE FIXTURE MASTER FIXTURE MULTI LEVEL LIGHTING L 2 LAMP BALLAST 1 LAMP FIXTURE BALLAST CONFIGURATION NOTE: QUANTITY, AND LOCATION OF OFF SWITCHES AS SHOWN ON FLOOR PLAN DRAWINGS. BALLAST CONFIGURATION DETAILS: I. IT IS THE INTENT OF THE DESIGN TO MAXIMZE THE USE OF MULTI LAWP BALLASTS TO DRIVE THE FIXTURE LAWPS. WHERE FIXTURES RUN END TO END, OR ARE WITHIN THE STANDARD 11 FOOT BALLAST WHEP LENDTH, FIXTURES SHALL BE CONFIGURED IN BALLASTED PARS. IN ALL CASES, BALLASTS SHALL BE RISTALLED TO DRIVE THE EXACT HUMBER OF LAWPS THEY ARE DESIGNED TO SERVE. SEVERAL OF THE MORE TYPICAL LAWP CONFIGURATIONS ARE SHOWN **ELECTRICAL LEGEND & LIGHTING** FIXTURE SCHEDULE 2. THE CONTRACTOR SHALL COORDINATE SPECIAL BALLAST CONFIGURATIONS TO SERVE LAMPS SERVED BY AN EMERGENCY CEMERATOR, ODD QUANTITIES OF FIXTURES RESULTING IN UNEVEN FOTURE PAIRS AND SPECIAL SWITCHING REQUIREMENTS. CONFIGURE BALLASTS TO MEET MUIT LEVEL SWITCHENS REQUIREMENTS. IN GENERAL, SPECIAL BALLAST CONFIGURATIONS ARE NOT IDENTIFIED ON A FIXTURE BY FIXTURE BASIS ON THE DOCUMENTS. IT IS THE CONTRACTORS RESPONSIBLITY TO COORDINATE THESE REQUIREMENTS. A AMENIAUM NUMBER OF SHIQLE LAMP BALLASTS MAY BE USE AS REQUIRED TO MEET THESE MEETS. Drawn By: DSH PAZPE: JWT E00.1 OCCUPANCY SENSOR CONTROL DIAGRAM TYPICAL FIXTURE BALLAST CONFIGURATIONS LEGEND NO SCALE REF: -NO SCALE REF: REF:





# USM LUTHER BONNEY HALL 2ND FLOOR RENOVATION

Portland, Malne

Key Plan

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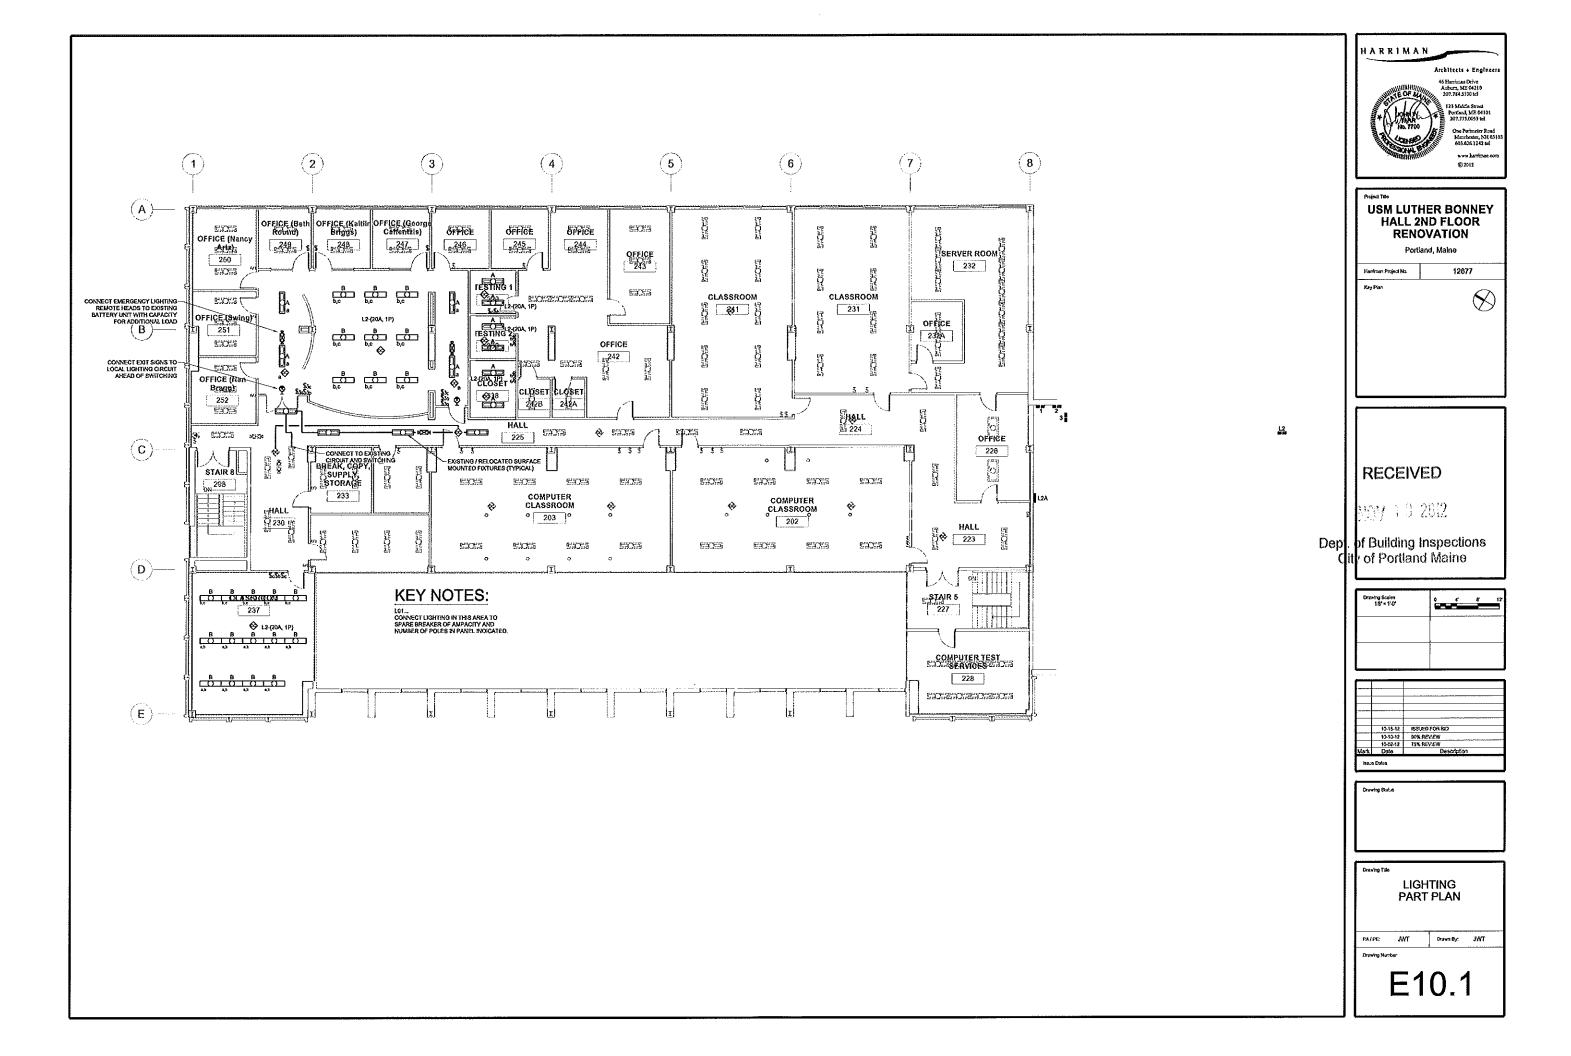
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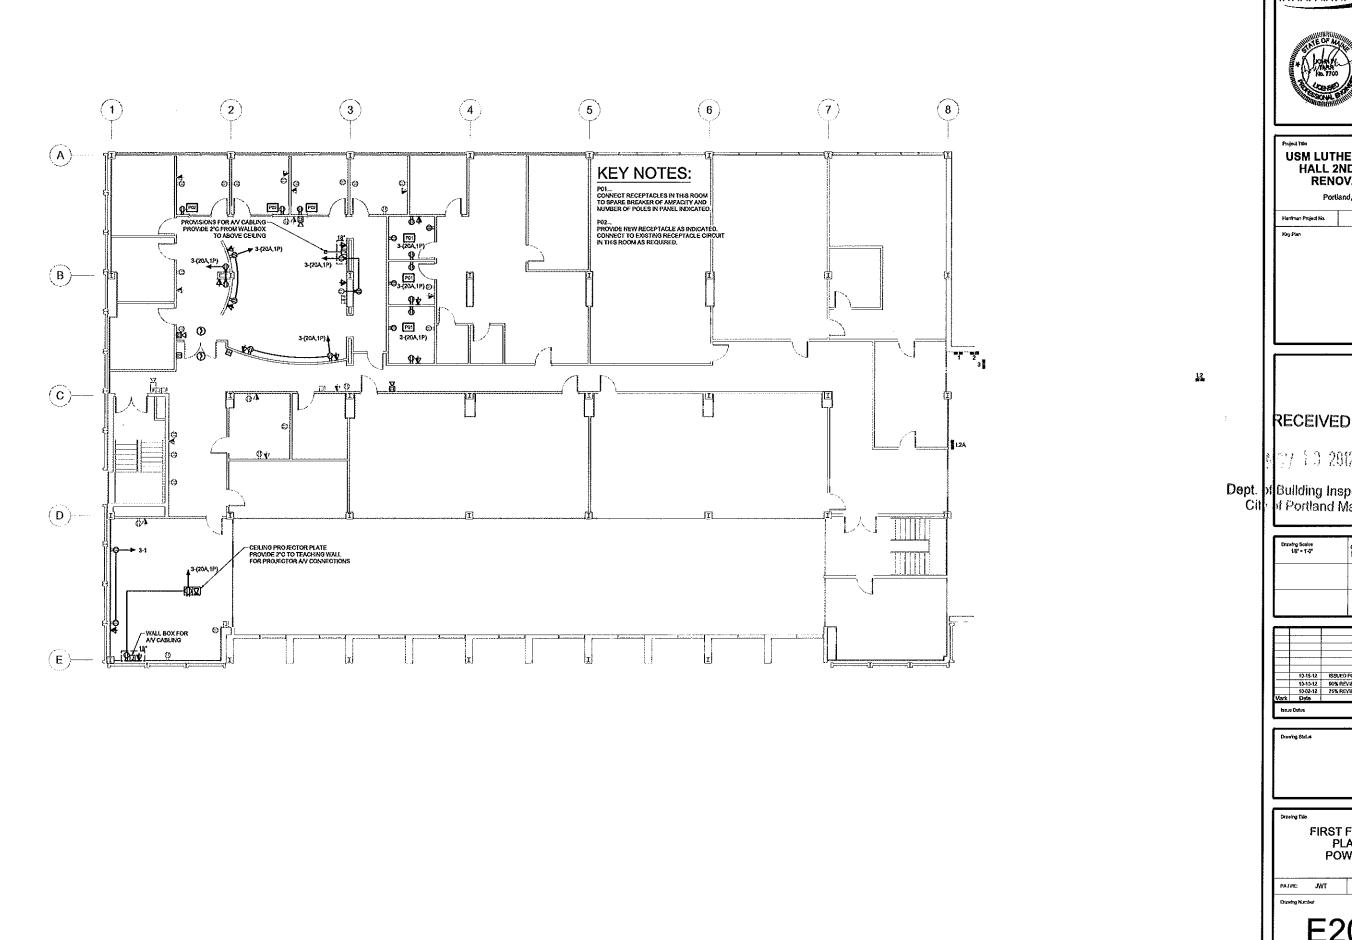
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ELECTRICAL EXISTING CONDITIONS PART PLAN

PA/PE: JWT Drawn By: DSH

E05.1





HARRIMAN 46 Harriman Drive Anhura, ME 04218 207.734.5100 tel

## USM LUTHER BONNEY HALL 2ND FLOOR RENOVATION

Portland, Malne

Hardman Project No.

12677

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Dept. of Building Inspections City of Portland Maine

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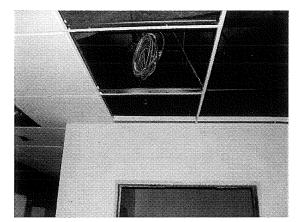
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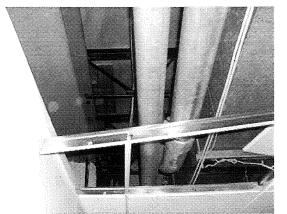
Drawing Status

FIRST FLOOR PLAN POWER

PATPE: JWT Drawn By: JWT

E20.1








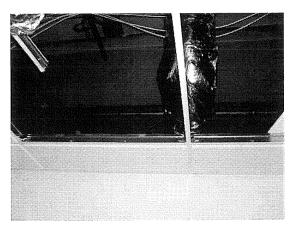


IMAGE 'A' IMAGE 'B' IMAGE 'C' IMAGE 'D'

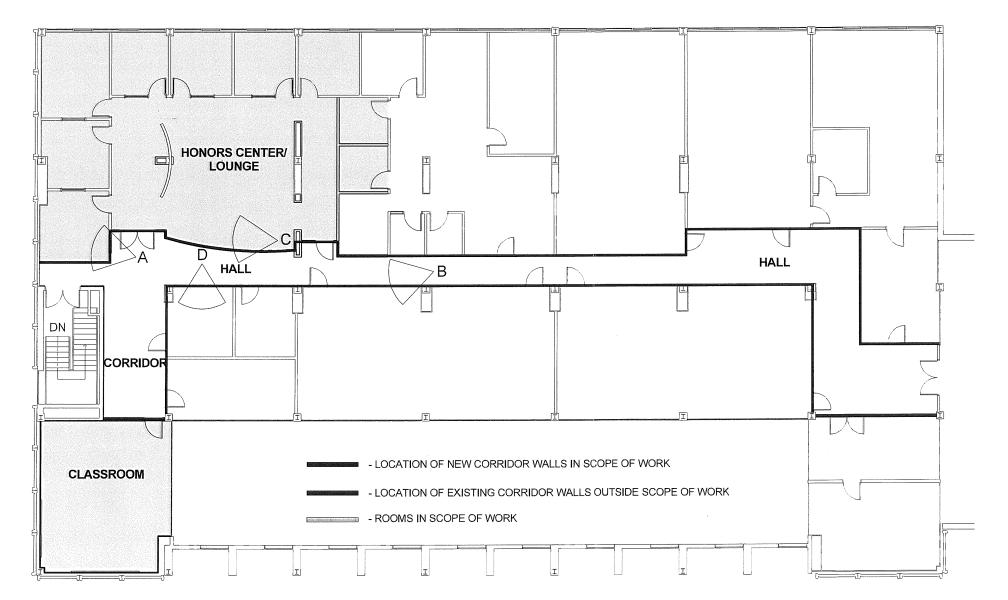

**USM LUTHER BONNEY HALL** SCALE: 1/16" = 1'-0"

HARRIMAN

Architects + Engineers

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Auburn, ME Portland, ME Manchester, NH 207.784.5100 tel 207.775.0053 tel 603.626.1242 tel


www.harriman.com

Project Title

### **USM LUTHER BONNEY** HALL 2ND FLOOR RENOVATION

Portland, Maine

HA Project No. 12677

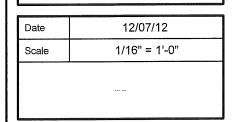

Drawing Title

**LUTHER BONNEY CORRIDOR WALL** INVENTORY

Drawing Number

2ND FL