Cit	y of Portland, Maine - Buil	ding or Use	Permi	t Application	n [[₽]	Permit No:	Issue Date:	CBL:	
	Congress Street, 04101 Tel: (0				04-1120		085 G	206001
Loca	ation of Construction:	Owner Name:			Owi	ner Address:		Phone:	
20	Spruce Ave	Bramn Scott N	1&	1&		Spruce Ave			
Busi	ness Name:	Contractor Name	:		Con	ntractor Address:		Phone	
Ĺ		Thompson & J	lohnson	Woodworkers	11:	5 Island Ave Pea	aks Island	12077665219	
Less	ce/Buyer's Name	?hone:			Permit Type: Zone:				
					Additions - Dwellings			IK-2	
Past	Use:	Proposed Use:		1	Permit Fee: Cost of Work: CEO District:				
sin	gle family	single family - addition w/8' p		' x 16'	\$201.00 \$20,000.00) 2	ļ
Drog	and Design Description			FIRE DEPT: Approved INSPECT Use Grou		Group: R-3 BOCA			
-	osed Project Description:				a:	$\mathcal{N} / \mathcal{I}$		The	
- 00	iild 8' x 16' addition w/8' porch				Signature: Sign PEDESTRIAN ACTIVITIES DISTRICT				
					Action: Approved Approv		d Approved	ed w/Conditions	
					Sig	nature:		Date:	\bigcirc
Pern tm		plied For: /2004				Zoning	Approval		
1.	This permit application does not p		Spe	cial Zone or Revie	ws	Zoning	g Appeal	Historic Fre	servation
1.	Applicant(s) from meeting applic Federal Rules.		🗌 Sh	oreland		Uariance		Tot in Distri	ct or Landmar
2.	Building permits do not include p septic or electrical work.	lumbing,	🗌 We	etland		Miscellan	eous	Does Not Re	equire Review
3. Building permits are void if work is not started within six (6) months of the date of issuance.			Flood Zone		Conditional Use		Requires Review		
	False information may invalidate permit and stop all work	a building	🗌 Su	bdivision		Interpreta	tion	Approved	
			🗌 Sit	ePlan		Approved	l	Approved w/	'Conditions
			Maj [Minor MM		Denied		Denied	
			Date:	8/5/04		Date:		Date: 8 5 6	97
				+ {				11	

CERTIFICATION

I hereby certify that I am the owner of record of the named property, or that the proposed work is authorized by the owner of record and that I have been authorized by the owner to make this application as his authorized agent and I agree to conform to all applicable laws of this jurisdiction. In addition, if a permit for work described in the application is issued, I certify that the code official's authorized representative shall have the authority to enter all **areas** covered by such permit at any reasonable hour to enforce the provision of the code(s) applicable to such permit.

SIGNATURE OF APPLICANT	ADDRESS	DATE	PHONE
RESPONSIBLE PERSON IN CHARGE OF WORK, TITLE		DATE	PHONE

BUILDING PERMIT INSPECTION PROCEDURES Please call <u>874-8703</u> or <u>874-8693</u> to schedule your inspections as agreed upon

Permits expire in 6 months, if the project is not started or ceases for 6 months.

The Owner or their designee is required to notify the inspections office for the following inspections and provide adequate notice. Notice must be called in 48-72 hours in advance in order to schedule an inspection:

By initializing at each inspection time, you are agreeing that you understand the inspection procedure and additional fees from a "Stop Work Order" and "Stop Work Order Release" will be incurred if the procedure is not followed as stated below.

A Pre-construction Meeting will take place upon receipt of your building permit.


\checkmark	Footing/Building Location Inspection:	Prior to pouring concrete Tibe Depth
	_ Re-Bar Schedule Inspection:	Prior to pouring concrete
	_ Foundation Inspection:	Prior to placing ANY backfill
\checkmark	_Framing/Rough Plumbing/Electrical:	Prior to any insulating or drywalling Close La
	use. I	to any occupancy of the structure or NOTE: There is a \$75.00 fee per ction at this point.

Certificate of Occupancy is not required for certain projects. Your inspector can advise you if your project requires a Certificate of Occupancy. All projects DO require a final inspection

_____ If any of the inspections do not occur, the project cannot go on to the next phase, REGARDLESS OF THE NOTICE OR CIRCUMSTANCES.

CERIFICATE OF OCCUPANICES MUST BE ISSUED AND PAID FOR, BEFORE THE SPACE MAY BE OCCUPIED

× Perel & dell	8.5.04
Signature of Applicant/Designee	Date 5 04
Signature of Inspections Official	Date
CBL: 085-G-6 Building Permit #:	04-1120

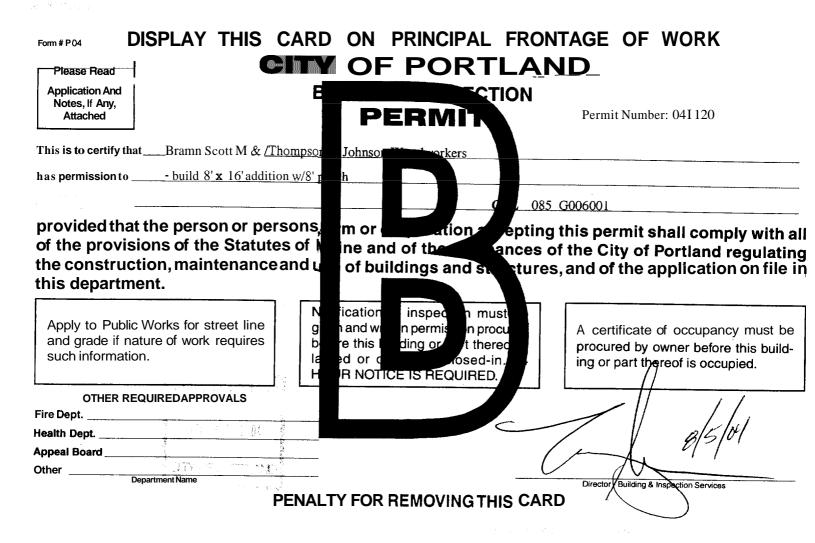

All Purpose Building Permit Application

If you or the property owner owes real estate or personal property taxes or user charges on any property within the City, payment arrangements must be made before permits of any kind are accepted.

Location/Address of Construction: 4	1 NOW	15LAND AN	Æ, 20	SP	PUCE	STREET
Total Square Footage of Proposed Struct 2378		Square Foota				
Tax Assessor's Chart, Block & Lof Chart# BG2k# Lot# 85 BG2k# 6,7,8	Owner: 5	IZATIONE F	MAN		Telephor 766 ·	ne: Z344
Lessee/Buyer's Name (If Applicable)	telephone Thompso 115 1940	name, address	N WOODL	Wo	st Of ork: \$ or: \$	^
Current use: 5F FESIDENCE		19411000	1100			
Approximately how long has It been vaca Proposed use: KITCHEN MO DOR Project description: RENATION	ant:	N, BATTHEO	om, 2	ND Fi	our pa	ect-
Contractor's name, address & telephone: Who should we contact when the permit Mailing address: The MPSCU We will contact you by phone when the review the requirements before starting and and a \$100.00 fee if any work starts before	is ready:R Performed to the second performed to the second performance to the second performed to the second performance to the second performed to the second performance to the second performa	Woorw Alo 8 You must co a Plan Reviewe	ORLS 207.76 me in and	1 1 pick 1	25 Ip the per rder will b	mitand e issued
F THE REQUIRED INFORMATION IS NOT INCLU DENIED AT THE DISCRETION OF THE BUILDING NFORMATION IN ORDER TO APROVE THIS PE hereby certify that I am the Owner of record of the no have been authorized by the owner io make this appli- urisdiction. In addition, if a permit for work described in hall have the authority to enter all areas covered by to o this permit.	APLANNING I RMIT. Amed property, c cation æ his/her a this application	DEPARTMENT, W or that the owner of authorized agent. is issued, I certify th	Frecord auth 10gree to contact the Code	QUIRE A	DDITIONA e proposed o all applica authorized	work and fhat l able laws of this representative
Signature of applicant: Peull	M	•	Date: 2	3-4-()4	Ī
This is NOT a permit, you may no	ot commen	ce ANY work	s until the	e perr	nit is iss	ued.

If you are in a Historic District you may be subject to additional permitting and fees with the Planning Department on the 4th floor & City Hall



BC CALC® 2003 DESIGN REPORT - US

5/8DEF. Triple 1 314" x 16" VERSA-LAMD 3100 SP File Name: BC CALC Project FB01 Job Name: PARROTT Description Address Specifier RACHEL BRIAN BIRKINBINE City, State, Zip PEAKS ISLE, ME Designer: Customer: THOMSON & JOHNSON WOOD STRUCTURESINC Company: ICBO 5512, NER 629 Code reports Misc 4 3 Standard Load - 40 pal i 10 pal Tributary 06-00-08 RO B1 9889 ibs LL **GRAG (bs | |** 5012 lbs DL 5012 lbs DL Total Horizontal Length - 14-03-00 **General Data** Load Summary Version US Imperial in Description Load Type Ref. Start End Type Value Trib. Dur. S Standard Load Unf. Area Left 00-00-00 14-03-00 Live 40 psf 08-00-08 100% Member Type: Floor Beam Dead 10 psf 08-00-08 90% Number of Spans: **1ST WALL** Unf. Lin. Left 00-00-00 14.03.00 0 plf anar 1 1 l ive nha Left Cantilever: 80 plf n/a 90% No Dead Right Cantilever: 08-00-08 100% No 2 2ND FLOOR Unf. Area Left 00-00-00 14-03-00 Live 30 osf 10 psf 80-00-80 90% Deed 0/12 2ND WALL Unf. Lin. Left 00-00-00 14-03-00 0 plf n/a 115% Slope: 3 Live Tributary: 06-00-08 Dead 80 off n/a 90% 745 p**l**f 100% KNEEW/FLOOUnf. Lin. ഹഹവ 14.03.00 n/a 4 1 ivo Dead 319 plf n/a 90% 5 ROOF unf. Area Left 00-00-00 14-03-00 40 psf 02-00-00 115% Live 40 psf 20 psf 02-00-00 90% Live Load Deed Dead Load: 10psf Partition Load: 0 psf **Controls Summary** Duration: 100 Control Type Value % Allowable Duration Load Case Span Location 51054 ft-lbs 1 - Internal 91.1% Moment 100% 2 Disclosure Neg. Moment Oft-lbs n/a 100% The completeness and accuracy of End Shear 11649 lbs 71.7% 100% 2 1-Left the input must be verified by anyone Total Load Defl. 3 L/316 (0.541") 76.0% 1 who would rely on the output as Live Load Defl. L/476 (0.359") 75.6% 3 1 evidence of suitability for a Max Dell 0.541 54.1% 3 1 particular application. The output above is based upon building Notes code-accepted design properties Design meets Code minimum (L/240) Total load deflection criteria. and analysis methods. Installation Design meets Code minimum (L/360) Live load deflection criteria. of BOISE engineered wood Design meets arbitrary (1") Maximum load deflection criteria. products must be in accordance Minimum bearing length for BO is 3-3/8". with the current installation Guide Minimum beering length for B1 is 3-3/8". and the applicable building codes. Entered/Displayed Horizontal Span Length(s) = Clear Span + 1/2 min. end bearing + 1/2 intermediate bearing To obtain an Installation Guide or if you have any questions, please call **Connection Diagram** (800)232-0788 before beginning Nailing schedule applies to both sides of the member. product installation. Member has no side loads. BC CALCO, BC FRAMERO, BCIO, Connectors are: 16d Sinker Nails BC RIM BOARD™, BC OSB RIM BOARD™, BOISE GLULAM™. a = 2 VERSA-LAMO, VERSA-RIMO, 2 = 3" VERSA-RIM PLUSO. à c = 6" VERSA-STRAND™ 1=12 VERSA-STUD®, ALLJOIST® and 2 = 3" AJS™ are trademarks of Boise Cascade Corporation. • • o

-16

This page contains a detailed description of the Parcel ID you selected. Press the **New Search** button at the bottom of the screen to submit a new query.

Current Owner Information

	Card Number	l of l			
	Parcel ID	D85 G006001			
	Location	20 SPRUCE AVE			
	Land Use	SINGLE FAMILY			
	Owner Address	BRAMN SCOTT P 20 Spruce Ave Peaks Island		JTS	
	Book/Page	21342/170			
	Legal	85-G-L-7-8-3 2 Spruce Ave Island Ave Peaks Island			
	Valuatior	Information			
	Land \$46,620	Building \$551020	Total \$101,640		
Property Info	rmation				
Year Built 1900	Style Old Style	Story Height 2	Sq. Ft. 2304	Total Acres 0.428	
Bedrooms 3	Full Baths	Half Baths L	Total Rooms	Attic Full Finsh	Basement Full
Outbuildings					
Туре	Quantity	Year Built	size	Grade	Condition
SHED-FRAME Shed-Frame	7 7	1900 1900	520 7PX50	C D	Р Р


Sales Informa	ation		
Date	Type	Price	Book/Page
12/23/1999	LAND + BLDING		15244-048

Picture and Sketch Sketch Picture


Click here to view Tax Roll Information.


Any information concerning tax payments should be directed to the Treasury office at 874-8490 or emailed.


New Search!

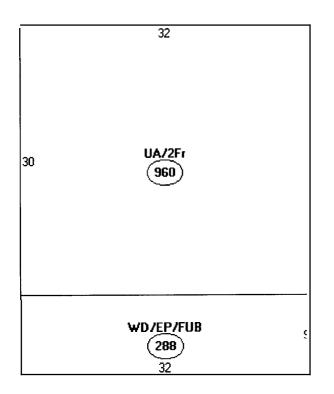



Descriptor/Area A:UA/2Fr IP-2,25 Front 20,20/0 streft Sides 20/0 streft Upt COV. 0000 streft 960 sqft

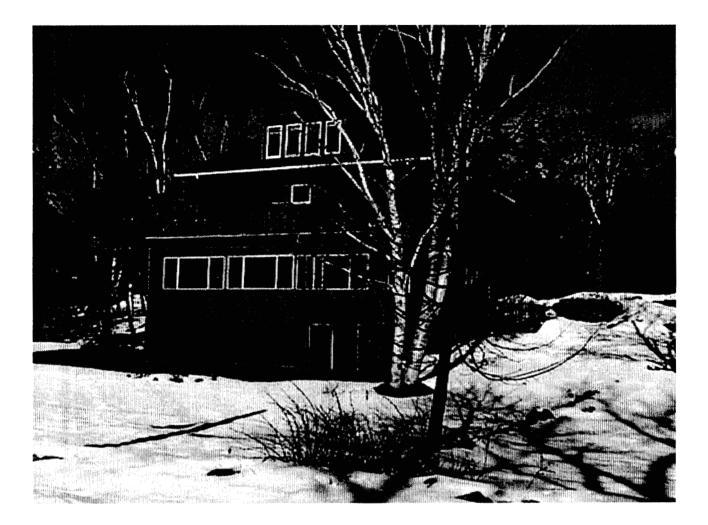


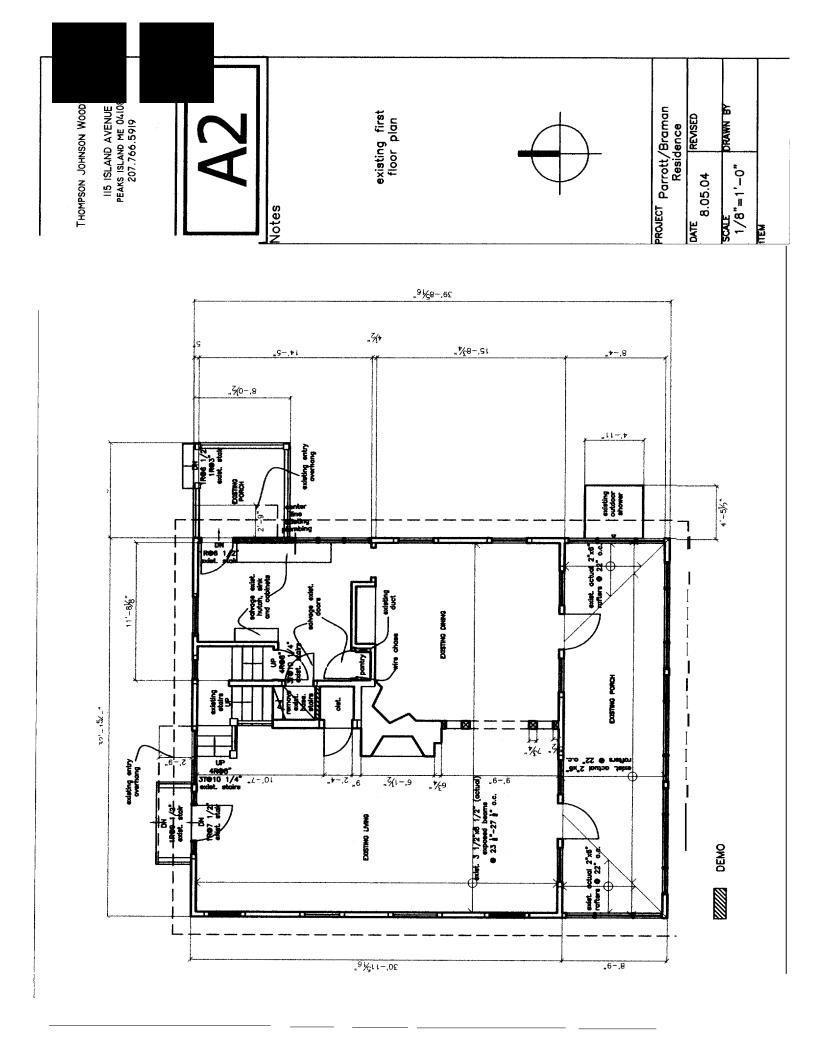


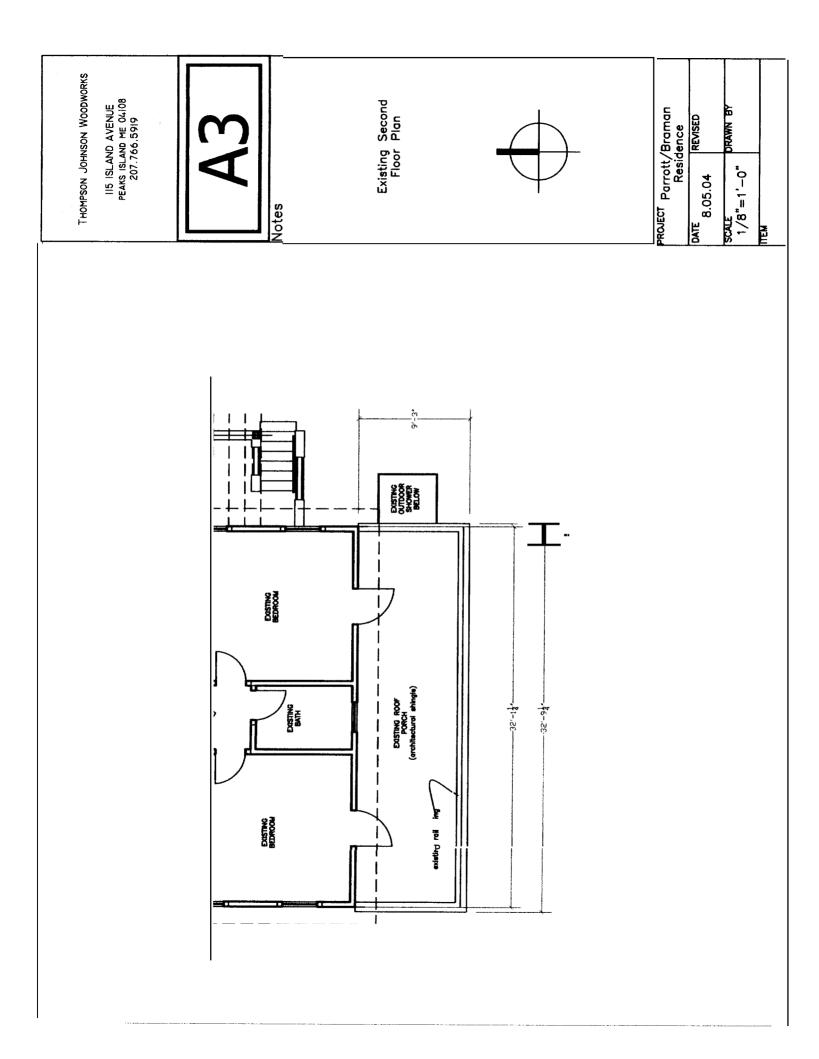


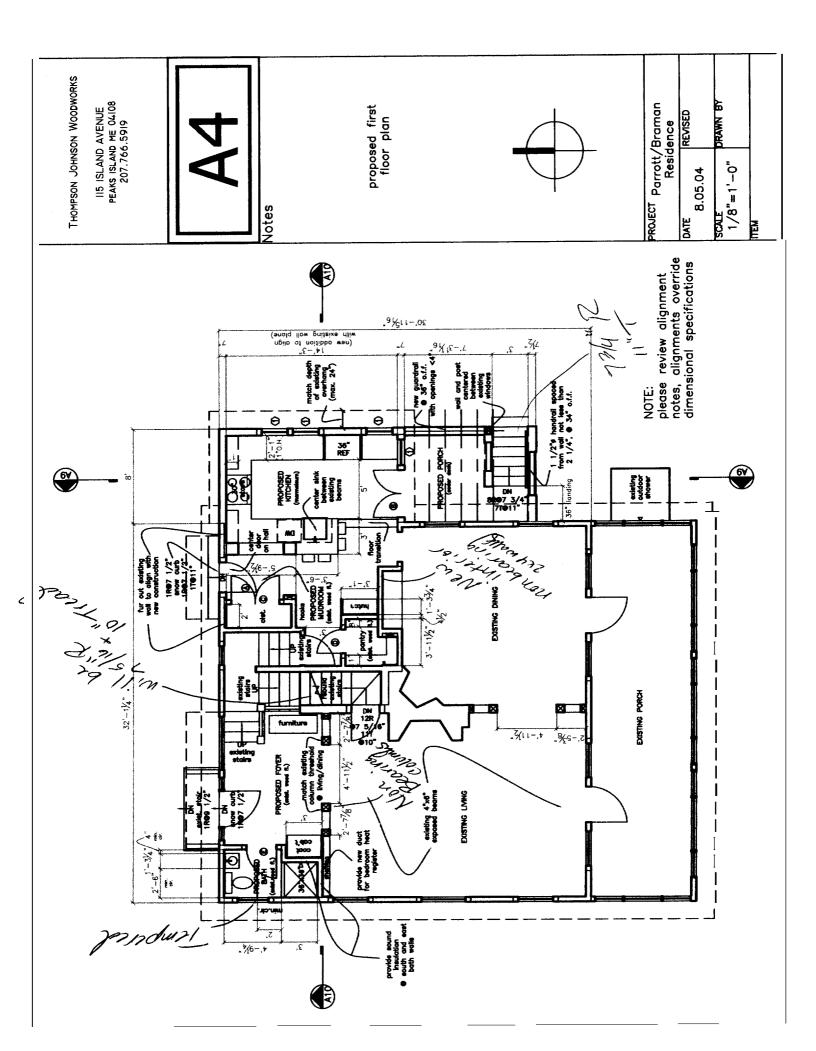


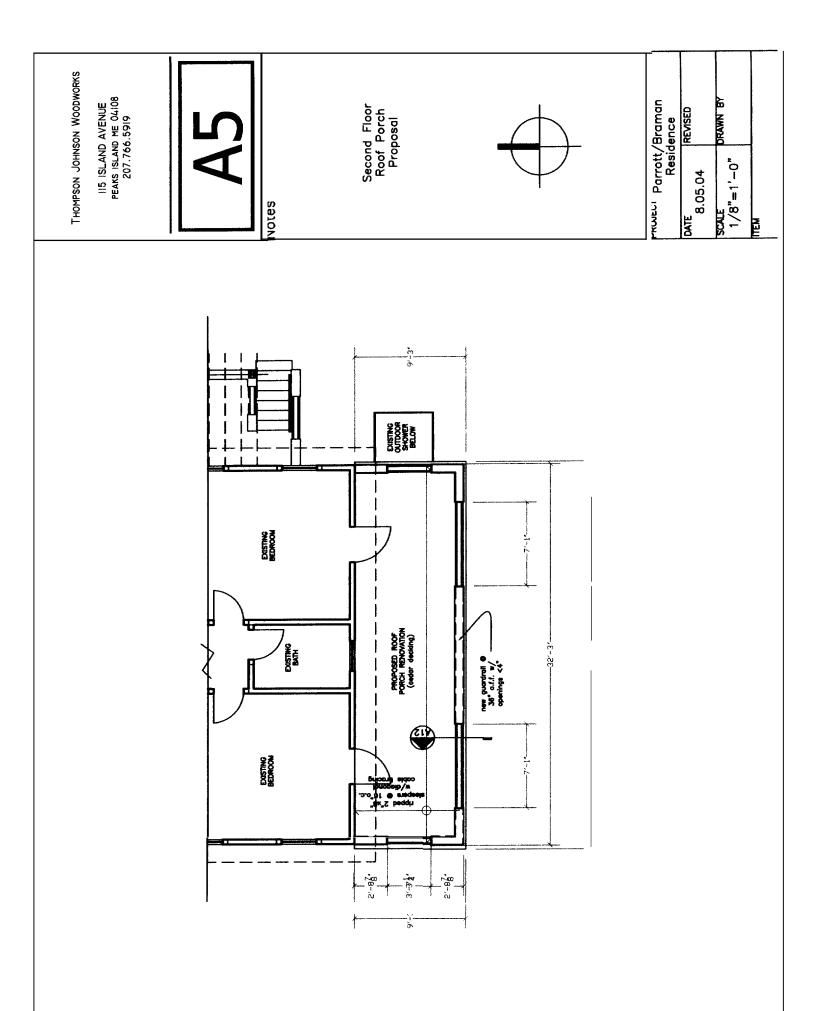


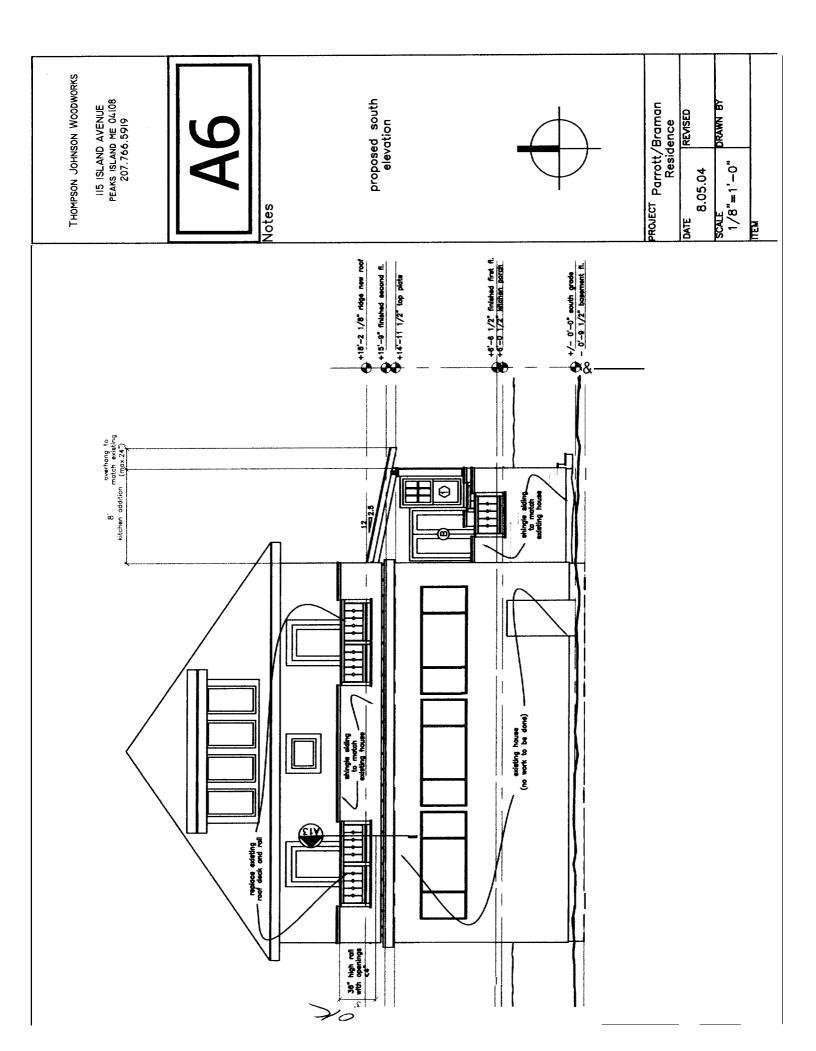


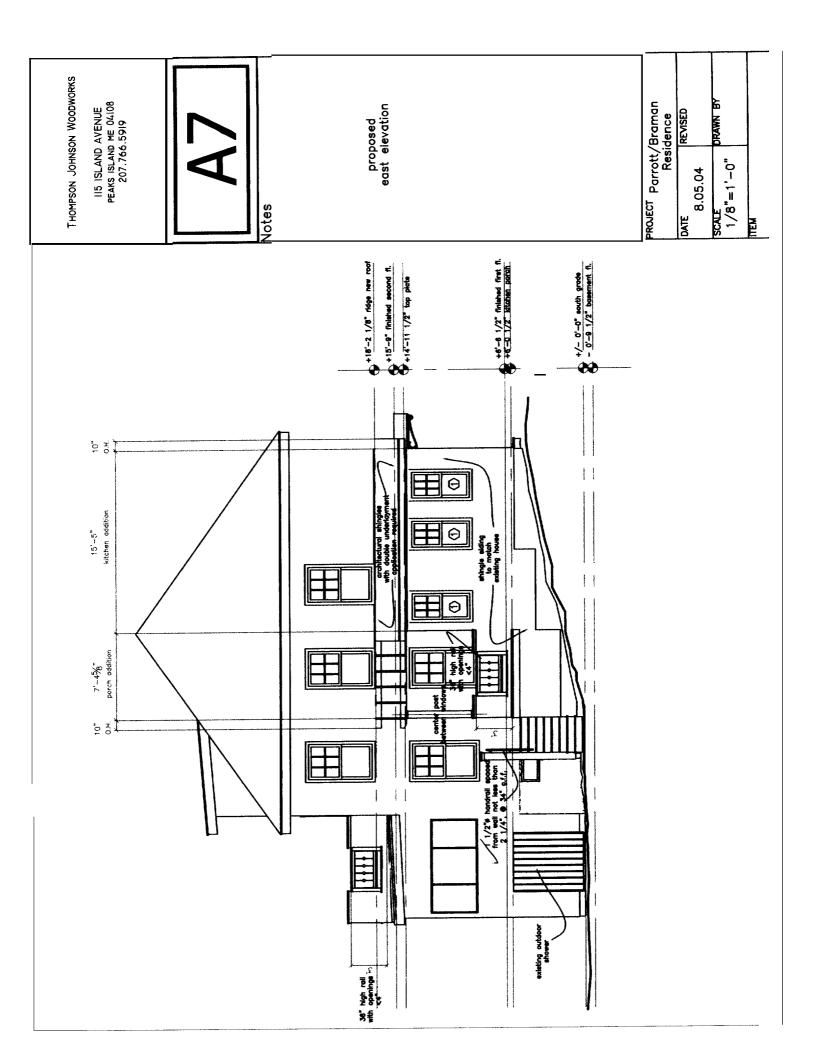


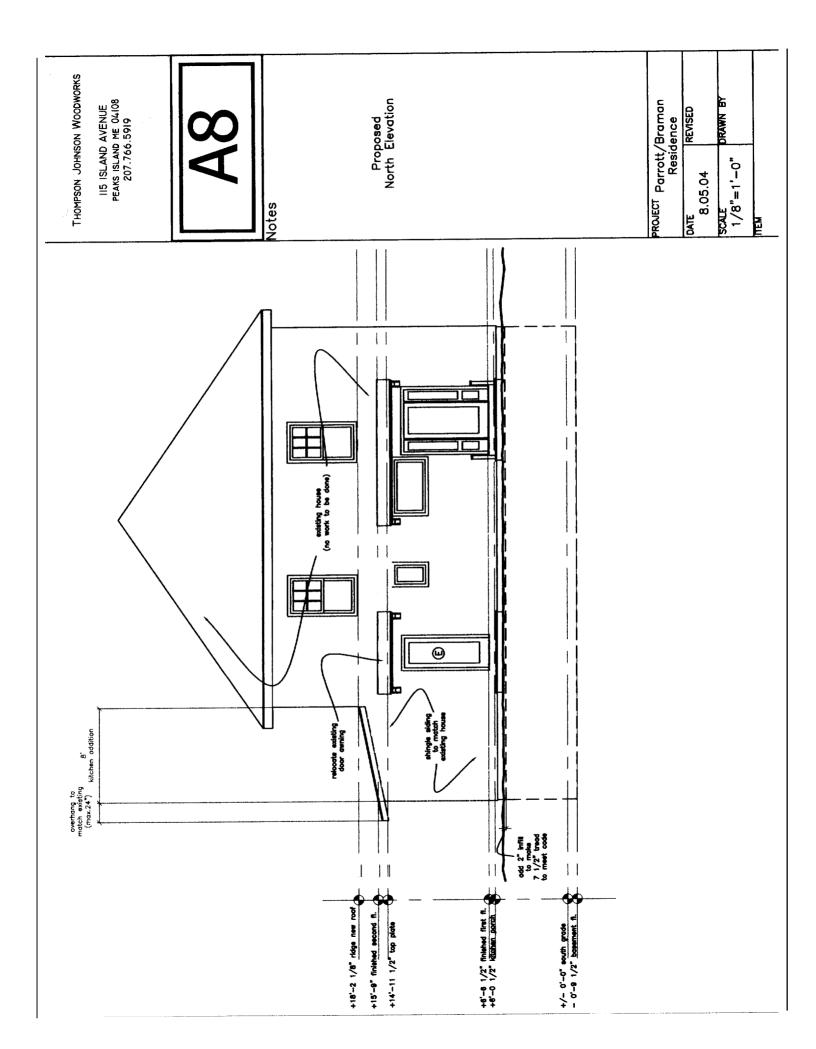


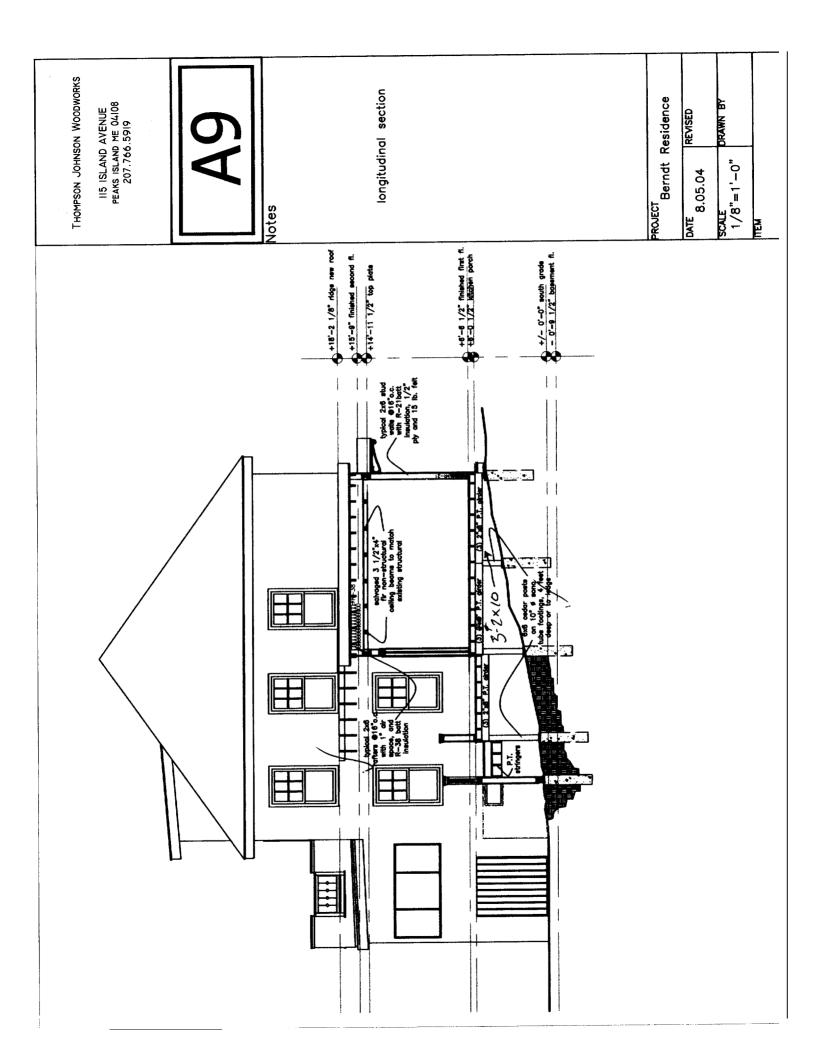


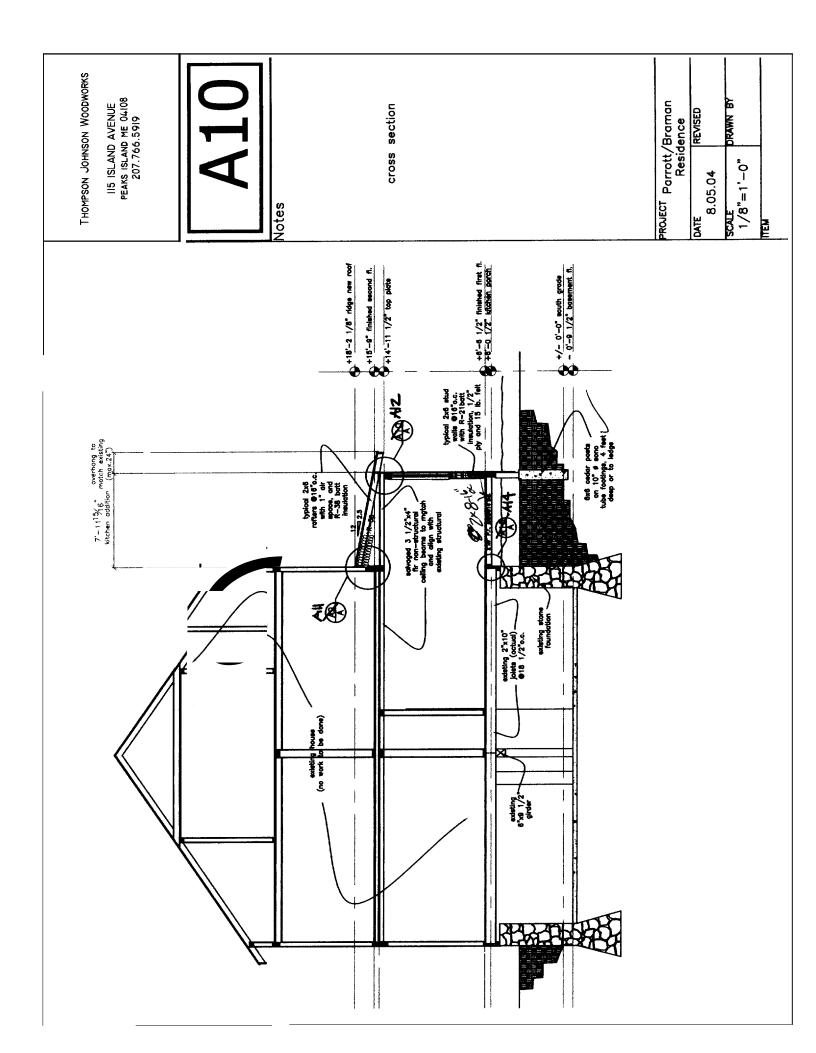

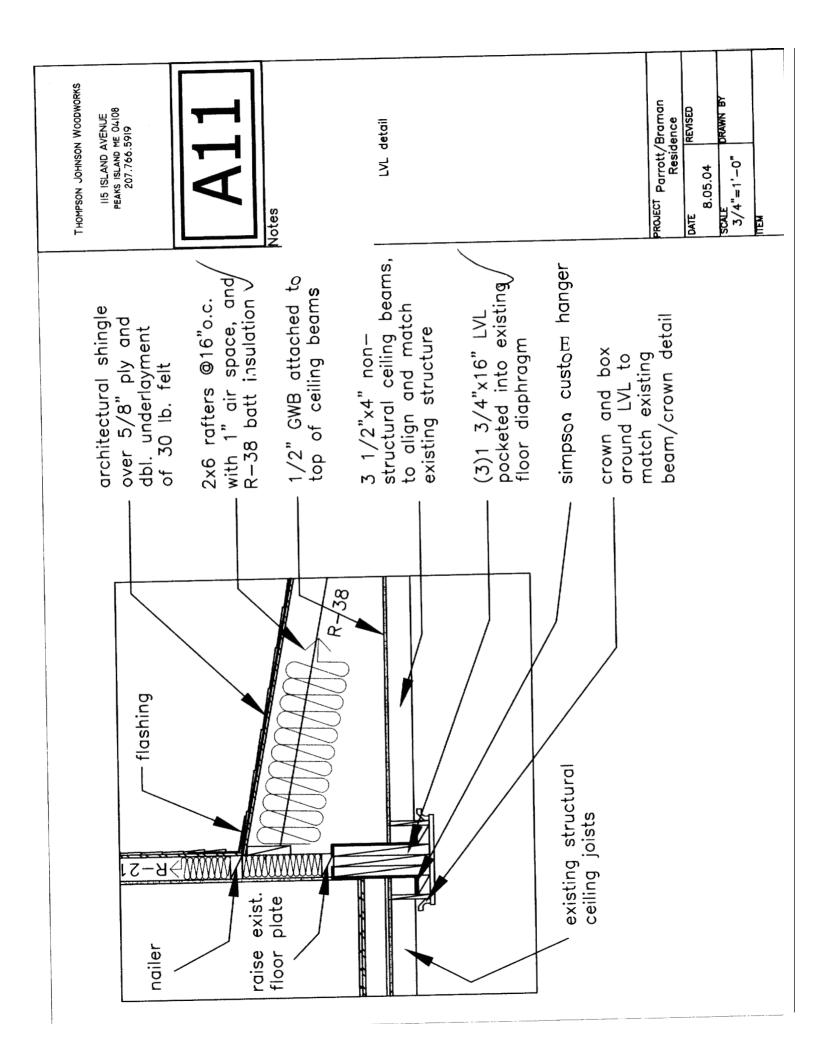


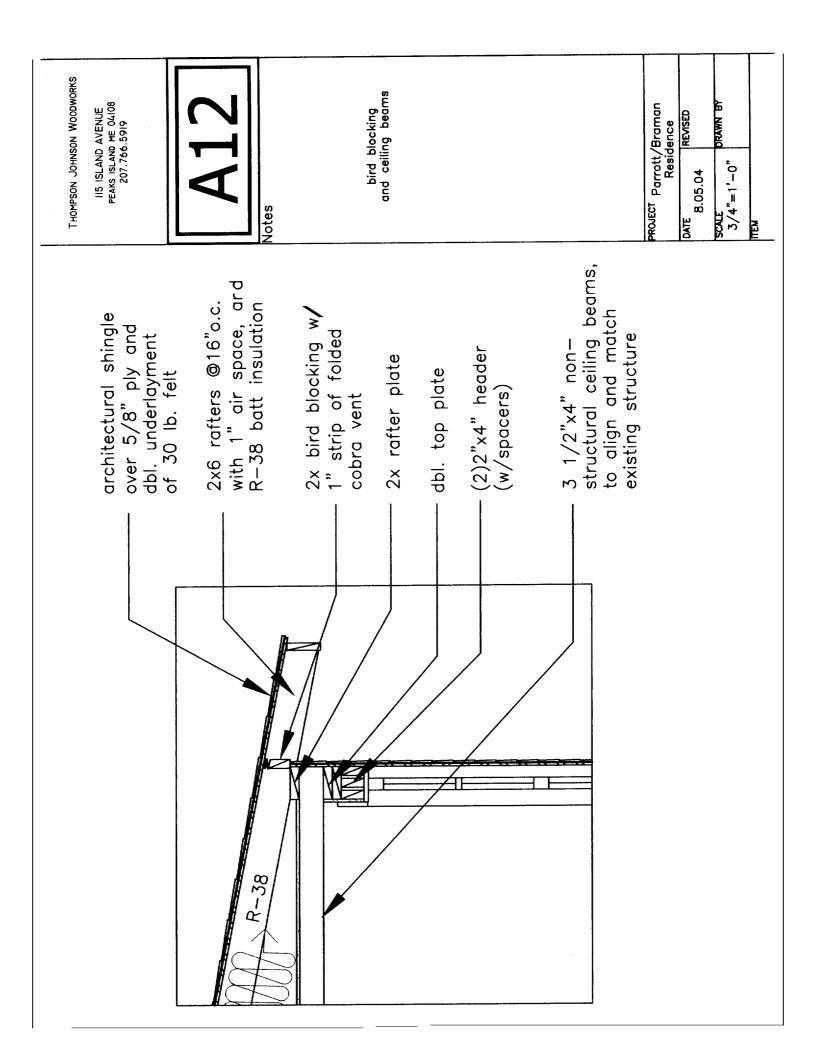


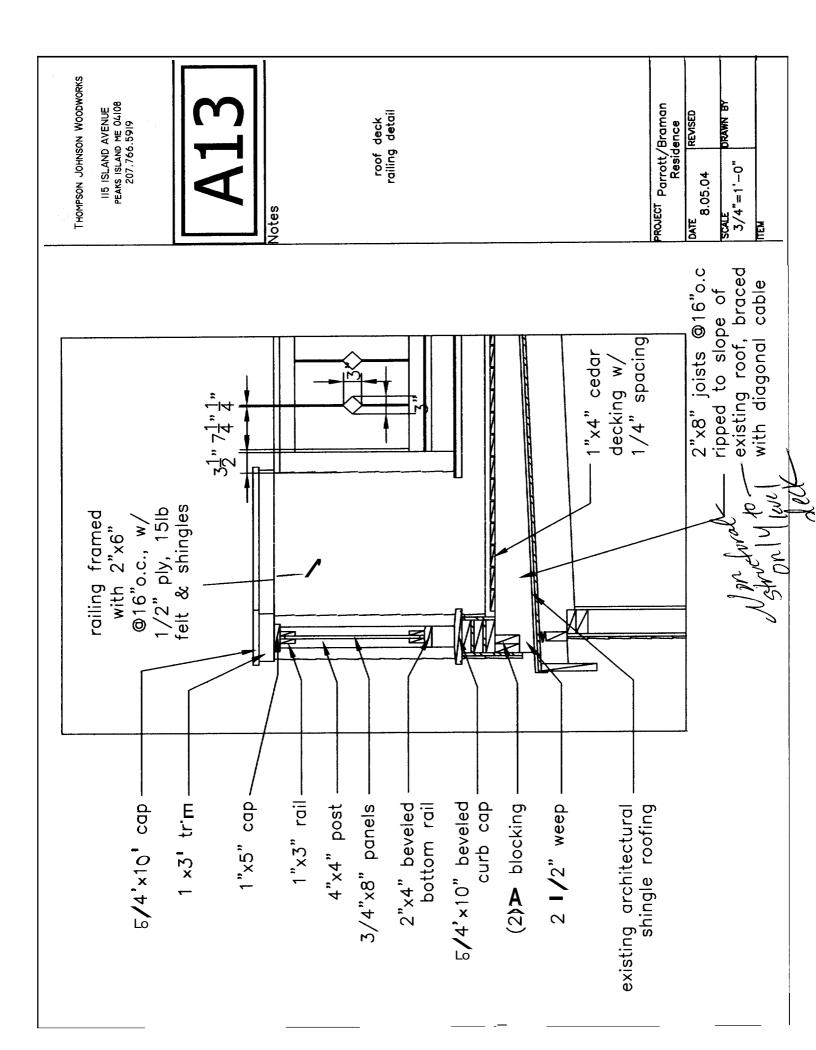

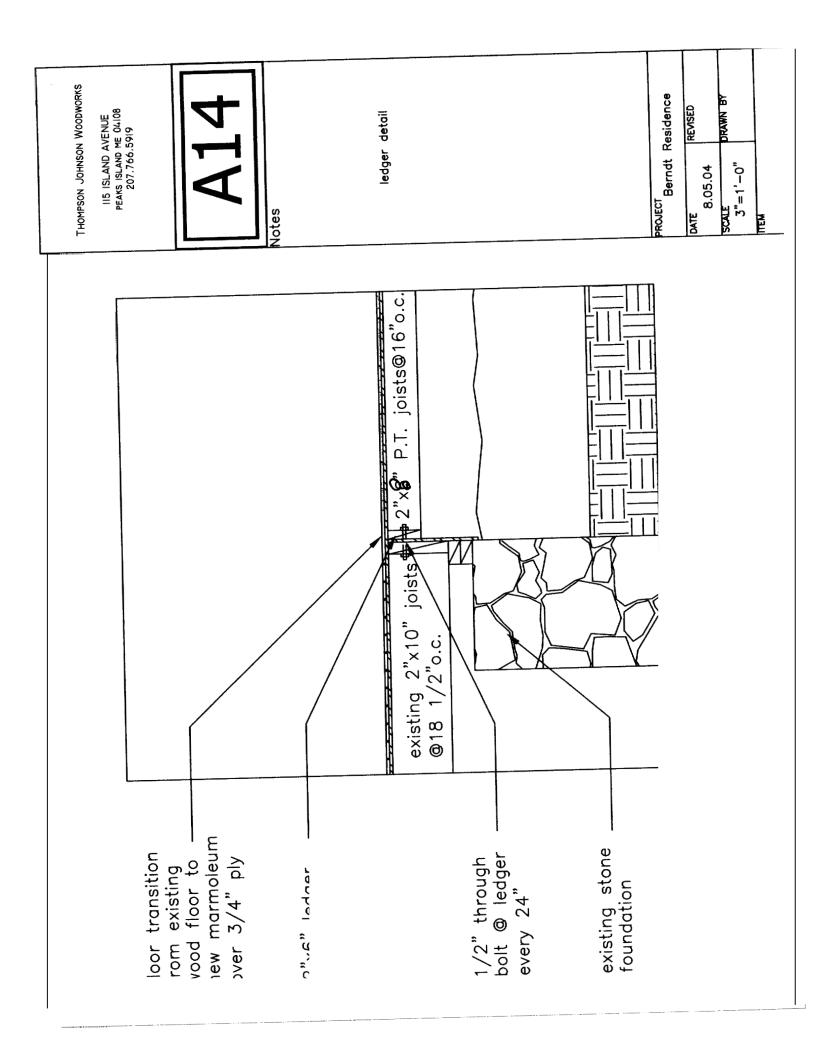

THOMPSON JOHNSON WOODWORKS II5 ISLAND AVENUE PEAKS ISLAND ME OLIOB 207.766.5919 207.766.5919 Notes	window/door schedule	PROJECT Parrott/Braman Residence DATE REVISED 8.05.04 REVISED 8.05.04 DRAWN BY 1/8"=1'-0" TEM
HARDWARE	HARDWARE	
NOTES	reuse existing reuse existing NOTES	
LOCKSET PREP		
AMB HINGE MORTISE	vif vif vif vif vif vif	
	84" 84" v.i.f. v.i.f. v.i.f. HEIGHT 56 7/8"	
LUN HOW	30° 48° 24° 25 5/8″	
OPER	арана сталана обрети обрети о	
GLASS	GLASS NA NA NA NA NA NA NA	
MATERIAL	wood w single panel, glass wood w single panel, glass 5 panel doors 5 panel doors 5 panel doors 7 panel doors 7 panel doors 8 panel doors 7 panel doors 7 panel doors 7 panel doors 7 panel doors	
Door Schedule	1 A borneville wood 1 PR B borneville wood 1 E sakvage 1 E sakvage 2 WIN. MANUFCT. 4 1 borneville	
Doo		

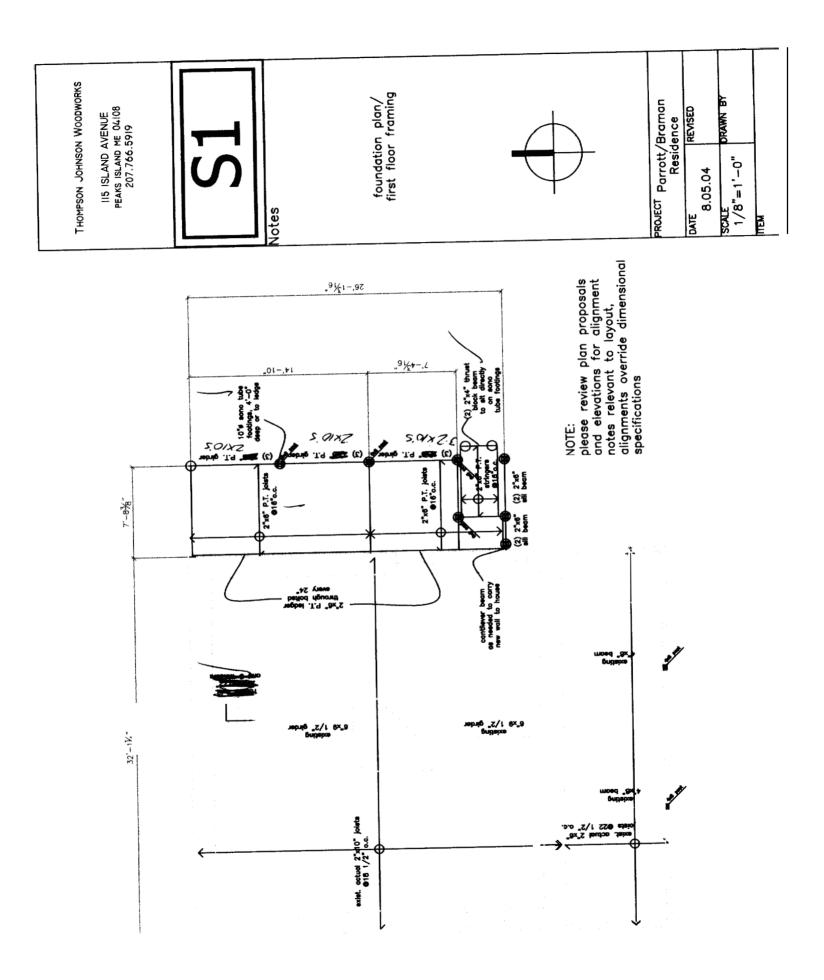

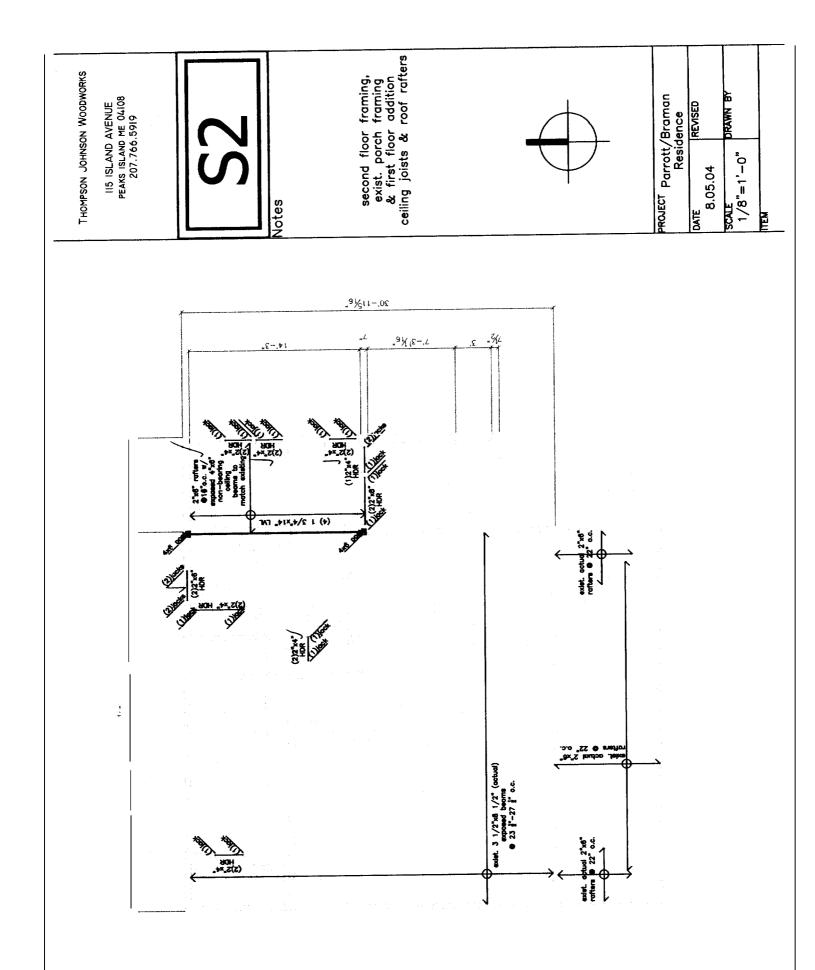

THOMPSON JOHNSON WOODWORKS 115 ISLAND AVENUE PEAKS ISLAND ME 04108 207.766.5919	Ш	Notes	-	electrical key				PROJECT Parrott/Braman Residence DATE REVISED 8.05.04	SCALE DRAWN BY 1/8"=1'-0" Item
	ceiling mount light fixture	pendunt light fixture recessed can light fixture	wall sconce light fixture	wet location wal soonoe light fixture	trak lighting	fluorescent locally switched	undercounter strip lighting		
			Φ	⊢⊕ _{wL}	$\Delta \Delta \Delta$	R e	↔ ↔ ↔ ↔		
	duplex	grouna-taut circuit interupter 220 volt	sayı ticin	3- way swith H	din me swtoH	smoke deteotor	minimum 50 o. ^c m vent fan		
	€€	⊕ GFI 220 €	- 6 -	- () 10	എ	ß	MIN.50	∑ ∟)	

