


| | |
|--|------------|
| PROJECT PARCEL SITE PORTLAND ASSESSOR'S MAP & LOT NUMBERS | |
| MAP | LOT |
| 113-A | 25 |

Applicant:
BANGOR SAVINGS BANK
 99 FRANKLIN STREET, BANGOR ME 04401
 CLIENT PHONE #: (207) 541-2715

BANGOR SAVINGS BANK

MARGINAL WAY PORTLAND, MAINE

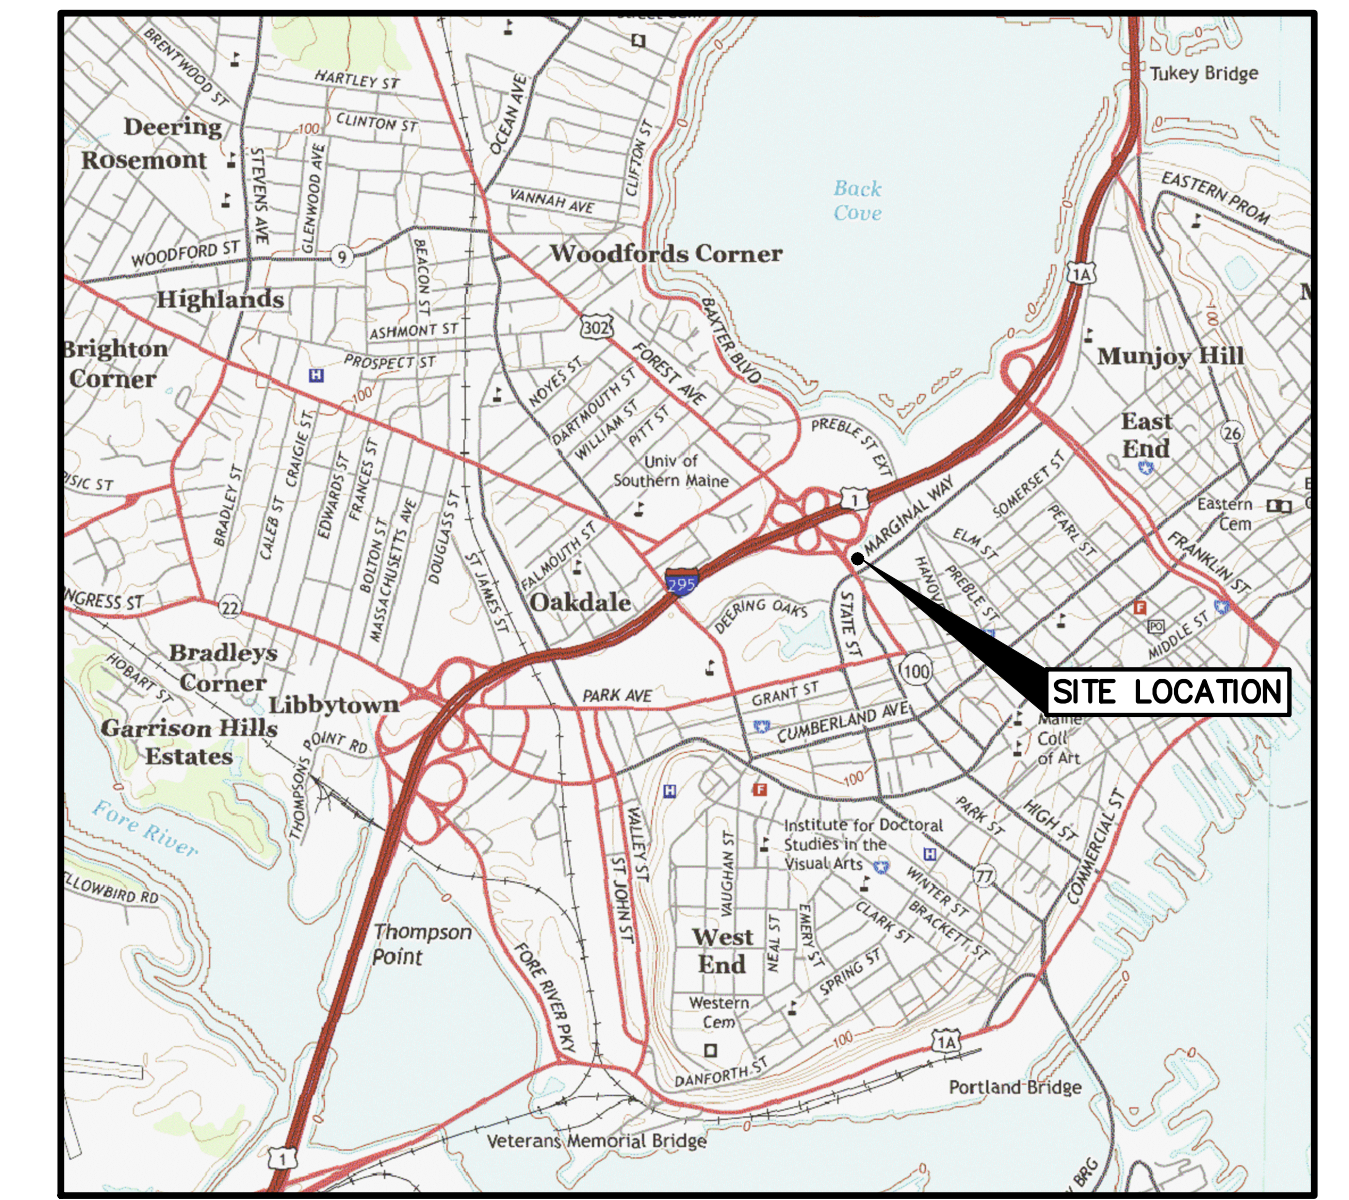

LOCATION MAP
N.T.S.

LEGEND

| EXISTING | DESCRIPTION | PROPOSED |
|----------|-----------------------------------|----------|
| | BUILDING | |
| | RIGHT OF WAY | |
| | PROPERTY LINE | |
| | BUILDING SETBACK | |
| | ZONE LINE | |
| | WETLAND BOUNDARY | |
| | GUIDE RAIL | |
| | EDGE OF PAVEMENT | |
| | EDGE OF GRAVEL DRIVE | |
| | GRADING CONTOUR LINE | |
| | SPOT ELEVATION | |
| | TREELINE | |
| | TREES & HEDGES | |
| | POLE WITH LIGHT FIXTURE(S) | |
| | UTILITY POLE | |
| | FREESTANDING SIGN | |
| | PAINTED DIRECTIONAL TRAFFIC ARROW | |
| | OVERHEAD ELECTRIC/TELEPHONE | |
| | UNDERGROUND ELECTRIC/TELEPHONE | |
| | WATER LINE | |
| | STORM DRAIN LINE | |
| | CULVERT | |
| | HYDRANT | |
| | WATER GATE VALVE | |
| | WATER SHUT OFF VALVE | |
| | MANHOLE | |
| | CATCH BASIN | |
| | TEST PIT | |
| | IRON ROD (SET) | |
| | IRON ROD (FOUND) | |
| | MONUMENT | |
| | RIPRAP | |
| | SILT FENCE - PERIMETER | |
| | STONE SEDIMENT BARRIER | |
| | FENCE | |
| | WELL | |

GENERAL NOTES

1. TOPOGRAPHIC DATA AND EXISTING CONDITIONS WAS PREPARED BY OWEN HASKELL OF FALMOUTH, MAINE ON MARCH 24, 2015
2. THE CONTRACTOR IS SPECIFICALLY CAUTIONED THAT THE LOCATION AND/OR THE ELEVATION OF THE EXISTING UTILITIES AS SHOWN ON THESE PLANS IS BASED ON RECORDS OF THE VARIOUS UTILITY COMPANIES AND WHERE POSSIBLE MEASUREMENTS TAKEN IN THE FIELD. THIS INFORMATION IS NOT TO BE RELIED ON AS BEING EXACT OR COMPLETE. THE CONTRACTOR MUST CALL THE APPROPRIATE UTILITY COMPANY AND DIG SAFE AT LEAST 72 HOURS PRIOR TO ANY EXCAVATION TO REQUEST EXACT FIELD LOCATION OF UTILITIES. IT SHALL BE THE RESPONSIBILITY OF THE CONTRACTOR TO RELOCATE ALL EXISTING UTILITIES WHICH CONFLICT WITH THE PROPOSED IMPROVEMENTS SHOWN ON THE PLANS.
3. MAINTENANCE OF EROSION CONTROL MEASURES IS OF PARAMOUNT IMPORTANCE TO THE OWNER AND THE CONTRACTOR IS RESPONSIBLE FOR COMPLYING WITH ALL EROSION CONTROL MEASURES SHOWN ON THE PLANS. ADDITIONAL EROSION CONTROL MEASURES SHALL BE INSTALLED IF DEEMED NECESSARY BY ON-SITE INSPECTIONS OF THE OWNER, THE CITY OF PORTLAND OR THEIR REPRESENTATIVES AT NO ADDITIONAL COST TO THE OWNER.
4. ALL MATERIAL SCHEDULES SHOWN ON THE PLANS ARE FOR GENERAL INFORMATION ONLY. THE CONTRACTOR SHALL PREPARE HIS OWN MATERIAL SCHEDULES BASED UPON HIS PLAN REVIEW. ALL SCHEDULES SHALL BE VERIFIED IN THE FIELD BY THE CONTRACTOR PRIOR TO ORDERING MATERIALS OR PERFORMING WORK.
5. ALL MATERIALS AND CONSTRUCTION METHODS SHALL CONFORM TO MAINE DEPARTMENT OF TRANSPORTATION SPECIFICATIONS, AND/OR CITY OF PORTLAND SPECIFICATIONS.

PERMITTING NOTES

1. THIS PROJECT IS SUBJECT TO THE TERMS AND CONDITIONS OF A SITE PLAN APPROVAL FROM THE CITY OF PORTLAND. THE CONSTRUCTION WILL BE GOVERNED BY THE CITY OF PORTLAND ZONING ORDINANCE WHICH IS AVAILABLE FOR VIEWING AT THE OFFICE OF THE ENGINEER OR THE MUNICIPAL OFFICE.
2. THE CONTRACTOR SHALL REVIEW THE ABOVE REFERENCED PERMITS PRIOR TO SUBMITTING A BID FOR THIS PROJECT, AND INCLUDE COSTS AS NECESSARY TO COMPLY WITH THE CONDITIONS OF THESE PERMITS.

LAYOUT NOTES

1. ALL DIMENSIONING, UNLESS NOTED OTHERWISE, IS TO THE FACE OF CURB.
2. OFFSETS TO CATCH BASINS AND MANHOLES ARE TO THE CENTER OF THE FRAME.
3. PIPE LENGTH EQUALS THE CENTER TO CENTER DISTANCES BETWEEN CATCH BASINS AND/OR MANHOLES MINUS ONE-HALF OF THE DIAMETER OF EACH CATCH BASIN OR MANHOLE.
4. PROPERTY LINE AND R.O.W. MONUMENTS SHALL NOT BE DISTURBED BY CONSTRUCTION. IF DISTURBED, THEY SHALL BE RESET TO THEIR ORIGINAL LOCATIONS AT THE CONTRACTOR'S EXPENSE, BY A MAINE LICENSED LAND SURVEYOR.
5. PROPOSED RIGHT OF WAY MONUMENTS AND PROPERTY LINE PINS SHALL BE INSTALLED UNDER THE DIRECTION OF A MAINE LICENSED LAND SURVEYOR.
6. CURB RADI UNLESS OTHERWISE NOTED ON THE PLAN SHALL BE A MINIMUM OF 3'.

UTILITY NOTES

1. ALL WATER UTILITY MATERIALS AND INSTALLATION METHODS SHALL CONFORM TO PORTLAND WATER DISTRICT STANDARDS. ALL WATER DISTRIBUTION PIPING SHALL BE CLASS 52 DUCTILE IRON PIPE, DOUBLE CEMENT LINED AND BITUMINOUS COATED CONFORMING TO AWWA/ANSI C104/A21.4. DISINFECTION OF WATER LINES SHALL CONFORM TO AWWA STANDARD C651, LATEST REVISION.
2. THE LOCATION OF THE PROPOSED UNDERGROUND ELECTRICAL SERVICE IS APPROXIMATE AND THE CONTRACTOR SHALL COORDINATE THE EXACT LOCATION WITH CENTRAL MAINE POWER COMPANY.
3. THRUST BLOCKS OR LOCKING RETAINER GLANDS SHALL BE PLACED ON THE WATER DISTRIBUTION LINES AT ALL BENDS, TEES, VALVES, CHANGES IN DIRECTION, ETC. THE THRUST BLOCKS OR LOCKING RETAINER GLANDS SHALL MEET THE REQUIREMENTS OF THE PORTLAND WATER DISTRICT STANDARDS.
4. TEST PITS AT ALL UTILITY CROSSINGS SHALL BE COMPLETED TWO WEEKS IN ADVANCE OF THE START OF CONSTRUCTION OR ORDERING OF MATERIALS. TEST PIT INFORMATION SHALL BE PROMPTLY PROVIDED TO ENGINEER FOR REVIEW.

GRADING AND DRAINAGE NOTES

1. UNLESS OTHERWISE NOTED, ALL STORM DRAIN PIPE SHALL BE IN ACCORDANCE WITH MDT SPECIFICATIONS SECTION 603-- PIPE CULVERTS AND STORM DRAINS, LATEST REVISION WITH THE EXCEPTION THAT THE ONLY ACCEPTABLE TYPES OF PIPE ARE AS FOLLOWS:
 REINFORCED CONCRETE PIPE, CLASS III
 POLYVINYL-CHLORIDE (PVC) PIPE
 SMOOTH BORE POLYETHYLENE - ADS OR HANCOR
2. TOPSOIL STRIPPED IN AREAS OF CONSTRUCTION THAT IS SUITABLE FOR REUSE AS LOAM SHALL BE STOCKPILED ON SITE AT A LOCATION TO BE DESIGNATED BY THE OWNER. UNSUITABLE SOIL SHALL BE SEPARATED, REMOVED AND DISPOSED OF AT AN APPROVED DISPOSAL LOCATION OFF SITE.
3. THE CONTRACTOR SHALL ANTICIPATE THAT GROUNDWATER WILL BE ENCOUNTERED DURING CONSTRUCTION AND SHALL INCLUDE SUFFICIENT COSTS WITHIN THEIR BID TO PROVIDE DEWATERING AS NECESSARY. NO SEPARATE PAYMENT SHALL BE MADE TO THE CONTRACTOR FOR DEWATERING.

EROSION CONTROL NOTES

1. LAND DISTURBING ACTIVITIES SHALL BE ACCOMPLISHED IN A MANNER AND SEQUENCE THAT CAUSES THE LEAST PRACTICAL DISTURBANCE OF THE SITE.
2. PRIOR TO BEGINNING ANY CLEARING/LAND DISTURBING ACTIVITIES, THE CONTRACTOR SHALL INSTALL THE PERIMETER SILT FENCES AND THE CONSTRUCTION ENTRANCE.
3. ALL GROUND AREAS DISTURBED FOR CONSTRUCTION WILL BE GRADED, LOAMED AND SEEDED AS SOON AS POSSIBLE. PERMANENT SEED MIXTURE SHALL CONFORM TO THE SEEDING PLAN CONTAINED IN THE EROSION CONTROL NOTES INCLUDED ON SHEET C405.
4. PRIOR TO PAVING, THE CONTRACTOR SHALL FLUSH SEDIMENT FROM ALL STORM DRAIN LINES, REMOVE ACCUMULATED SEDIMENT FROM SUMPS AND INVERTS AND PROPERLY DISPOSE OF.
5. ALL CATCH BASINS WITH OUTLET PIPES 18" DIAMETER OR LESS SHALL BE PROVIDED WITH A "SNOUT" SEDIMENTATION HOOD PER DETAIL.
6. SILT FENCES SHALL BE INSPECTED, REPAIRED AND CLEANED AS NOTED IN THE EROSION CONTROL NOTES.
7. THE CONTRACTOR SHALL REPAIR AND ADD STONE TO THE CONSTRUCTION ENTRANCE AS IT BECOMES SATURATED WITH MUD TO ENSURE THAT IT WORKS AS PLANNED DURING CONSTRUCTION.
8. SILT REMOVED FROM AROUND INLETS AND BEHIND THE SILT FENCES SHALL BE PLACED ON A TOPSOIL STOCKPILE AND MIXED INTO IT FOR LATER USE IN LANDSCAPING OPERATIONS.
9. EROSION CONTROL NOTES ACCOMPANY THIS PLAN SET AND ARE CONTAINED ON DRAWING C405 OF THIS PLAN SET.
10. THE MAINTENANCE SCHEDULE FOR THE CATCH BASIN SEDIMENT SUMPS IS CONTAINED IN THE EROSION CONTROL NOTES INCLUDED ON SHEET C405.
11. THE CONTRACTOR IS CAUTIONED THAT FAILURE TO COMPLY WITH THE SEQUENCE OF CONSTRUCTION, EROSION/SEDIMENT CONTROL PLAN, AND OTHER PERMIT REQUIREMENTS BASED UPON ANY THIRD PARTY REVIEW (ie MDEP) MAY RESULT IN MONETARY PENALTIES. THE CONTRACTOR SHALL BE ASSESSED ALL SUCH PENALTIES AT NO COST TO THE OWNER OR PERMITTEE.
12. ALL NON-PAVED AREAS DISTURBED DURING CONSTRUCTION SHALL BE LOAMED AND SEEDED, UNLESS OTHERWISE DIRECTED BY THE OWNER.
13. ALL DISTURBED AREAS ARE TO RECEIVE A MINIMUM OF 4" OF TOPSOIL PRIOR TO PERMANENT SEEDING.

UTILITIES

WATER:
 PORTLAND WATER DISTRICT
 225 DOUGLASS STREET
 PORTLAND, MAINE 04102
 (207) 761-8300
 CONTACT: GLISSEN HAVU

SEWER:
 DEPARTMENT OF PUBLIC SERVICES
 55 PORTLAND STREET
 PORTLAND, MAINE 04101-2991
 (207) 874-8832
 CONTACT: FRANK BRANCELY

ELECTRIC:
 CENTRAL MAINE POWER
 162 CANCO ROAD
 PORTLAND, MAINE 04103
 (207) 828-2882
 CONTACT: JAMES COUGH

TELEPHONE:
 VERIZON
 5 DAVIS FARM ROAD
 PORTLAND, MAINE 04103
 (207) 797-1842
 CONTACT: TROY MACDONALD

CABLE:
 TIME WARNER CABLE
 118 JOHNSON ROAD
 PORTLAND, MAINE 04102
 (207) 253-2222

INDEX


| | |
|------|--|
| C001 | COVER SHEET, GENERAL NOTES, & LEGEND |
| - | EXISTING CONDITIONS PLAN |
| C002 | DEMOLITION PLAN |
| C101 | SITE AND UTILITY PLAN |
| C102 | GRADING, DRAINAGE & EROSION CONTROL PLAN |
| C401 | DETAILS 1 |
| C402 | DETAILS 2 |
| C403 | DETAILS 3 |

CALL BEFORE YOU DIG
 1-888-344-7233

PERMITS

| TYPE OF PERMIT | GOVERNING BODY | STATUS |
|---|---|-------------------------|
| PRELIMINARY SITE PLAN APPLICATION/CONDITIONAL USE APPLICATION | CITY OF PORTLAND PLANNING DEPARTMENT 388 CONGRESS STREET PORTLAND, MAINE 04101 (207) 874-8719 | SUBMITTED: 5/13/2015 |

NOTE: THIS PLAN SET IS ISSUED FOR PERMITTING PURPOSES AND SHALL NOT BE USED FOR CONSTRUCTION.

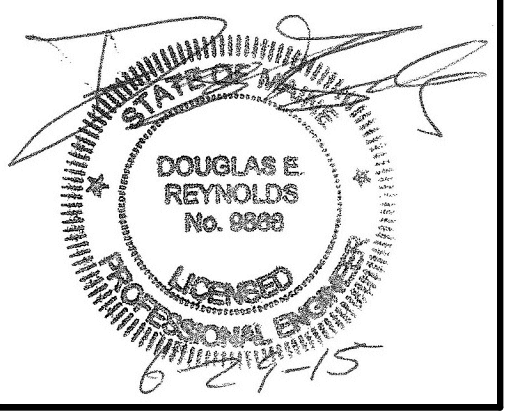

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| Rev. | Date | Revision |
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| RESPONSE TO CITY COMMENTS | Date | By |
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| Design: JWA | Draft: CG | Date: DEC 2014 |
| Checked: DER | Scale: NTS | Job No.: 2970 |
| File Name: 2970-COVER.dwg | | |
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| | |
|---------------|---|
| Drawing Name: | Cover Sheet, General Notes, and Legend |
| Project: | Bangor Savings Bank 20 Marginal Way, Portland, Maine |
| Client: | Bangor Savings Bank 99 Franklin Street, Bangor, Maine 04401 |

Drawing No.
C001