


COLUMN SCHEDULE			
ROOF T.O.S.	ELEV. = 140'7 1/2"		
ROOF T.O.S.	ELEV. = 141'-5"		
B.O. CMU	ELEV. = 139'-4"		
T.O. CMU	ELEV. = 131'-4"		
B.O. CMU	ELEV. = 129'-4"		
LEVEL 3 T.O.S.	ELEV. = 127'-7 1/2"		
T.O. CMU	ELEV. = 121'-4"		
B.O. CMU	ELEV. = 119'-4"		
LEVEL 2 T.O.S.	ELEV. = 113'-0 1/2"		
T.O. CMU	ELEV. = 111'-4"		
LEVEL 2 ROOF OVERHANG	ELEV. = 111'-5 1/2"		
B.O. CMU	ELEV. = 109'-4"		
T.O. GRADE BEAM	ELEV. = 99'-4"		
T.O. GRADE BEAM	ELEV. = 96'-6"		
COLUMNS	B-3 J-3	C-3 F-5 C-4	D-2 G-1 H-2
			A-3

\*NOTE: THIS SCHEDULE IS FOR INFORMATION ONLY; OTHER MISC. COLUMNS MAY EXIST ON PLANS. SEE ALL PLANS AND DETAILS FOR ADDITIONAL MEMBERS AND INFORMATION.

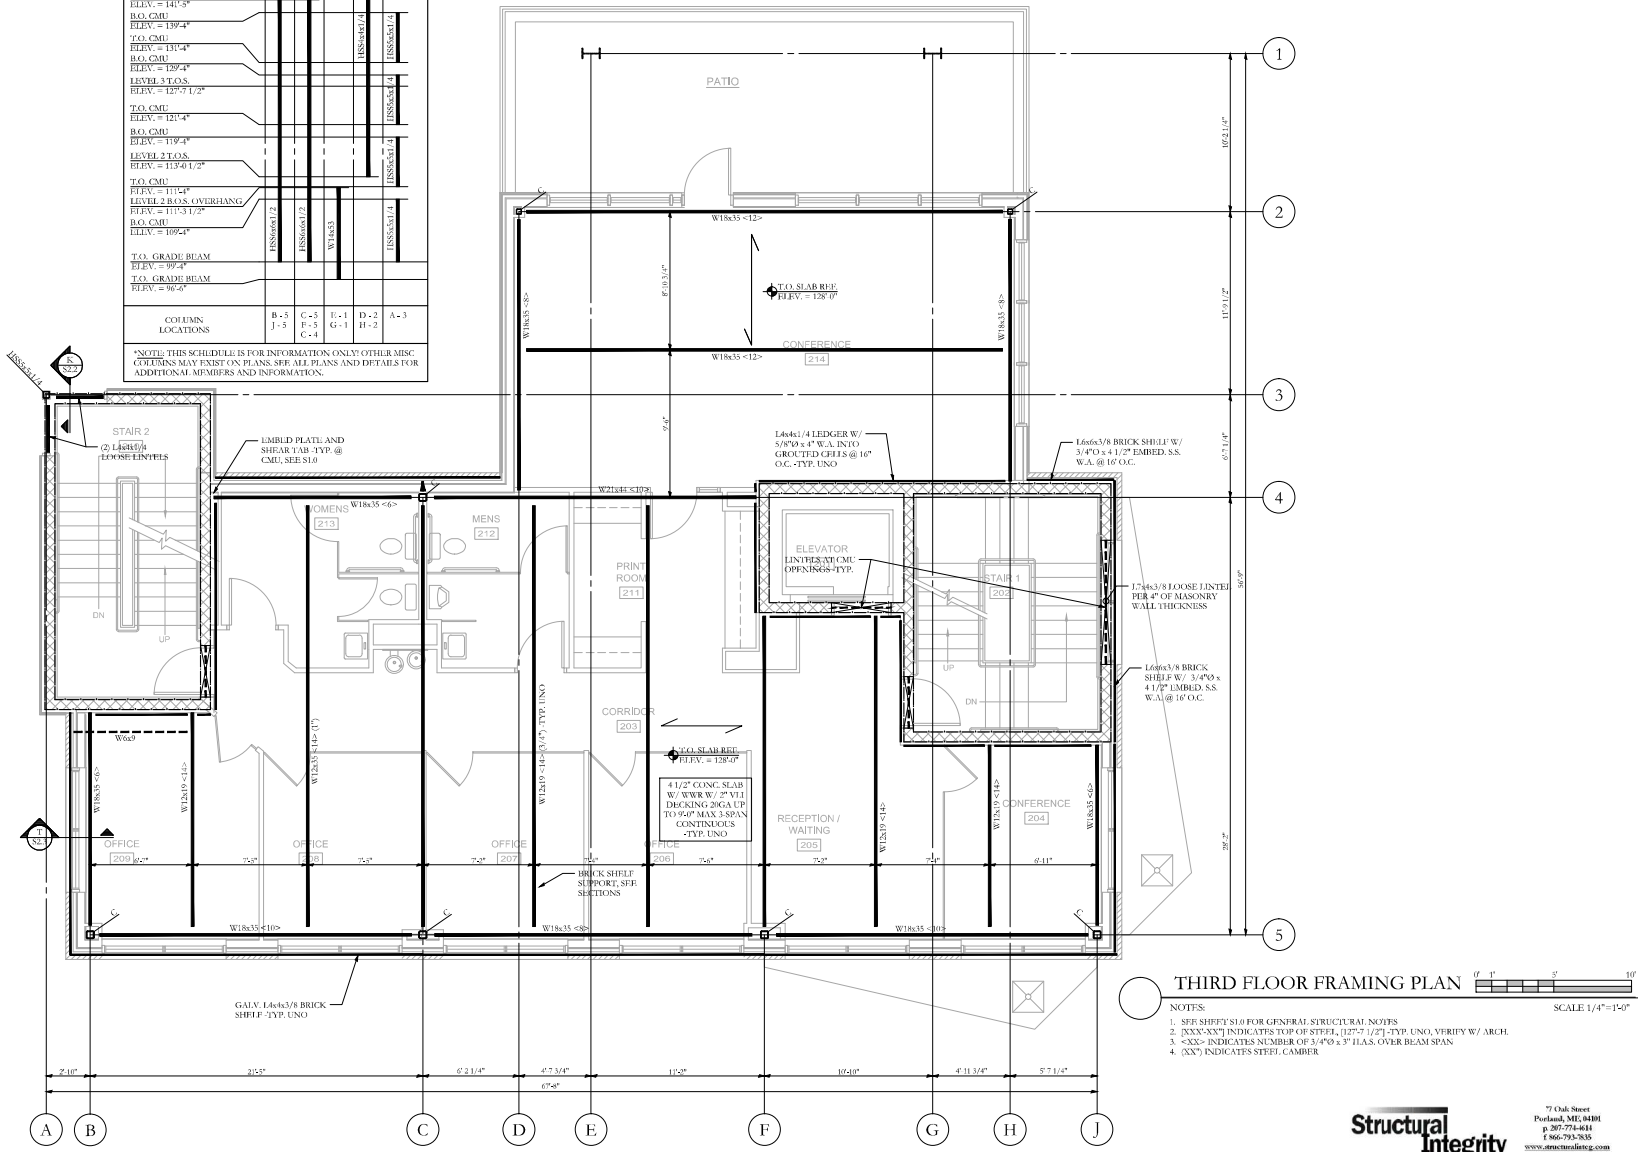

**THIRD FLOOR FRAMING PLAN**

NOTES:  
 1. SEE SHEET S1.0 FOR GENERAL STRUCTURAL NOTES.  
 2. XXXX INDICATES TOP OF STEEL I/JET TYP. UNO, VERIFY W/ ARCH.  
 3. <math>\le</math>XX</math> INDICATES NUMBER OF 3/4" x 3" HLAS. OVER BEAM SPAN.  
 4. (XX) INDICATES STEEL CAMBER.

SCALE 1/4" = 1'-0"

ISSUED FOR CONSTRUCTION  
07.22.15



BSB - MARGINAL WAY  
PORTLAND, MAINE

PROJECT NO: 1502  
 CAD DWG FILE:  
 DRAWN BY: BSH  
 CHK'D BY: ACJ  
 COPYRIGHT: 2015

THIRD FLOOR FRAMING PLAN

S1.3

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