

NOTE

CURVE NO. 1 IS NOT A NORMAL CURVE. IN THE ORIGINAL TAKING FOR PREBLE STREET EXTENSION, THE CITY OF PORTLAND TOOK ALL OF LOT 103. IN DEEDS 9087/64 AND 9452/95, THE CITY OF PORTLAND CONVEYS "LOT 112-B-14 ON THE PORTLAND ASSESSORS MAP IN USE IN DECEMBER 1989." THAT IS THE PORTION OF LOT 103 WHICH IS NOT A PART OF PREBLE STREET EXTENSION. THE PORTION OF LOT 105 LEADING TO LOT 103 IS ON A CURVE WHICH IS 38 FEET FROM THE BASELINE CURVE. THE PORTION OF LOT 89 LEADING FROM LOT 103 IS ON A CURVE WHICH IS 42 FEET FROM THE

BASELINE CURVE.
THEREFORE, A NORMAL CURVE CANNOT BE LAID OUT BETWEEN THE TWO.
WE HAVE BEEN INSTRUCTED BY THE CITY OF PORTLAND TO CREATE A
CURVE FROM THE CORNERS OF THE NORMAL CURVES. THE 160.00 FOOT
RADIUS CURVE SHOWN ON THIS PLAN IS THAT CURVE. REFERENCE IS
MADE TO ITS CURVE DATA AND CHORD FOR ANY FUTURE WORK WITH IT.
AN AGREEMENT ON THIS CURVE WITH THE CITY OF PORTLAND MAY
BE NECESSARY.

NO EASEMENT IDENTIFIED FOR POLES 21 AND 22.

#### PLAN REFERENCES:

PLAN OF BOULEVARD PARK, MARCH 1912, RECORDED IN CUMBERLAND COUNTY REGISTRY OF DEEDS IN PLAN BOOK 12, PAGE 31.

PLAN FOR COMMERCIAL PROPERTIES, INC. BY H.I. & E.C. JORDAN, APRIL 1961, FILE 368.

PRELIMINARY PLOT PLAN FOR FRED C. SCRIBNER, JR. BY BEAL, DEPETER, SPAULDING, INC., FEBRUARY 1961, H.I. & E.C. JORDAN, FILE 368.

PLAN FOR A.F. BRIGGS CO., INC. BY H.I. & E.C. JORDAN, JULY 1971, FILE 368.

CITY OF PORTLAND ASSESSORS MAP NO. 112.

MAINE STATE HIGHWAY COMMISSION RIGHT OF WAY MAP, STATE HIGHWAY "14", S.H.C. FILE NO. 3-188, SHEET 1 OF 2, RECORDED IN CUMBERLAND COUNTY REGISTRY OF DEEDS, PLAN BOOK 111, PAGE 61.

### CERTIFICATION:

OWEN HASKELL, INC. HEREBY CERTIFIES TO MICHAEL D. KAPLAN THAT THIS PLAN IS THE RESULT OF AN ACTUAL SURVEY BASED ON RECORD DESCRIPTION OF THE LOT. IT IS IN CONFORMANCE WITH THE REQUIREMENTS OF THE MAINE BOARD OF LICENSURE FOR PROFESSIONAL LAND SURVEYORS FOR A CATEGORY 1 CONDITION II SURVEY WITH THE FOLLOWING EXCEPTIONS:

1) NO NEW DEED DESCRIPTION.

 DRILL HOLE AT CORNER FOREST AVENUE AND PREBLE STREET EXTENSION NOT CAPPED.

NARCH 1, 1995

Juis T. Mayull

SEAL

TO PORTLAND PENINSULA

State of Maine, Cumberland ss.

Registry of Deeds

Received March 3 19.95

It / h3/ m. f.M and recorded in Plan Book 195 Page 52.

Attest:

Register Register

STANDARD BOUNDARY SURVEY

FOREST AVENUE, PORTLAND, MAINE MADE FOR

MICHAEL D. KAPLAN 66 AUSTIN STREET, PORTLAND, ME 04103

OWEN HASKELL, INC.

16 CASCO ST., PORTLAND, ME 04101 (207) 774-0424

PROFESSIONAL LAND SURVEYORS


 PROFESSIONAL LAND SURVEYORS

 Drwn By
 LTM
 Date
 Job No.

 Trace By
 JLW
 MARCH 1, 1995
 94270P

 Check By
 LTM
 Scale
 Drwg. No.

 Book No. 655/132
 1" = 20'
 1

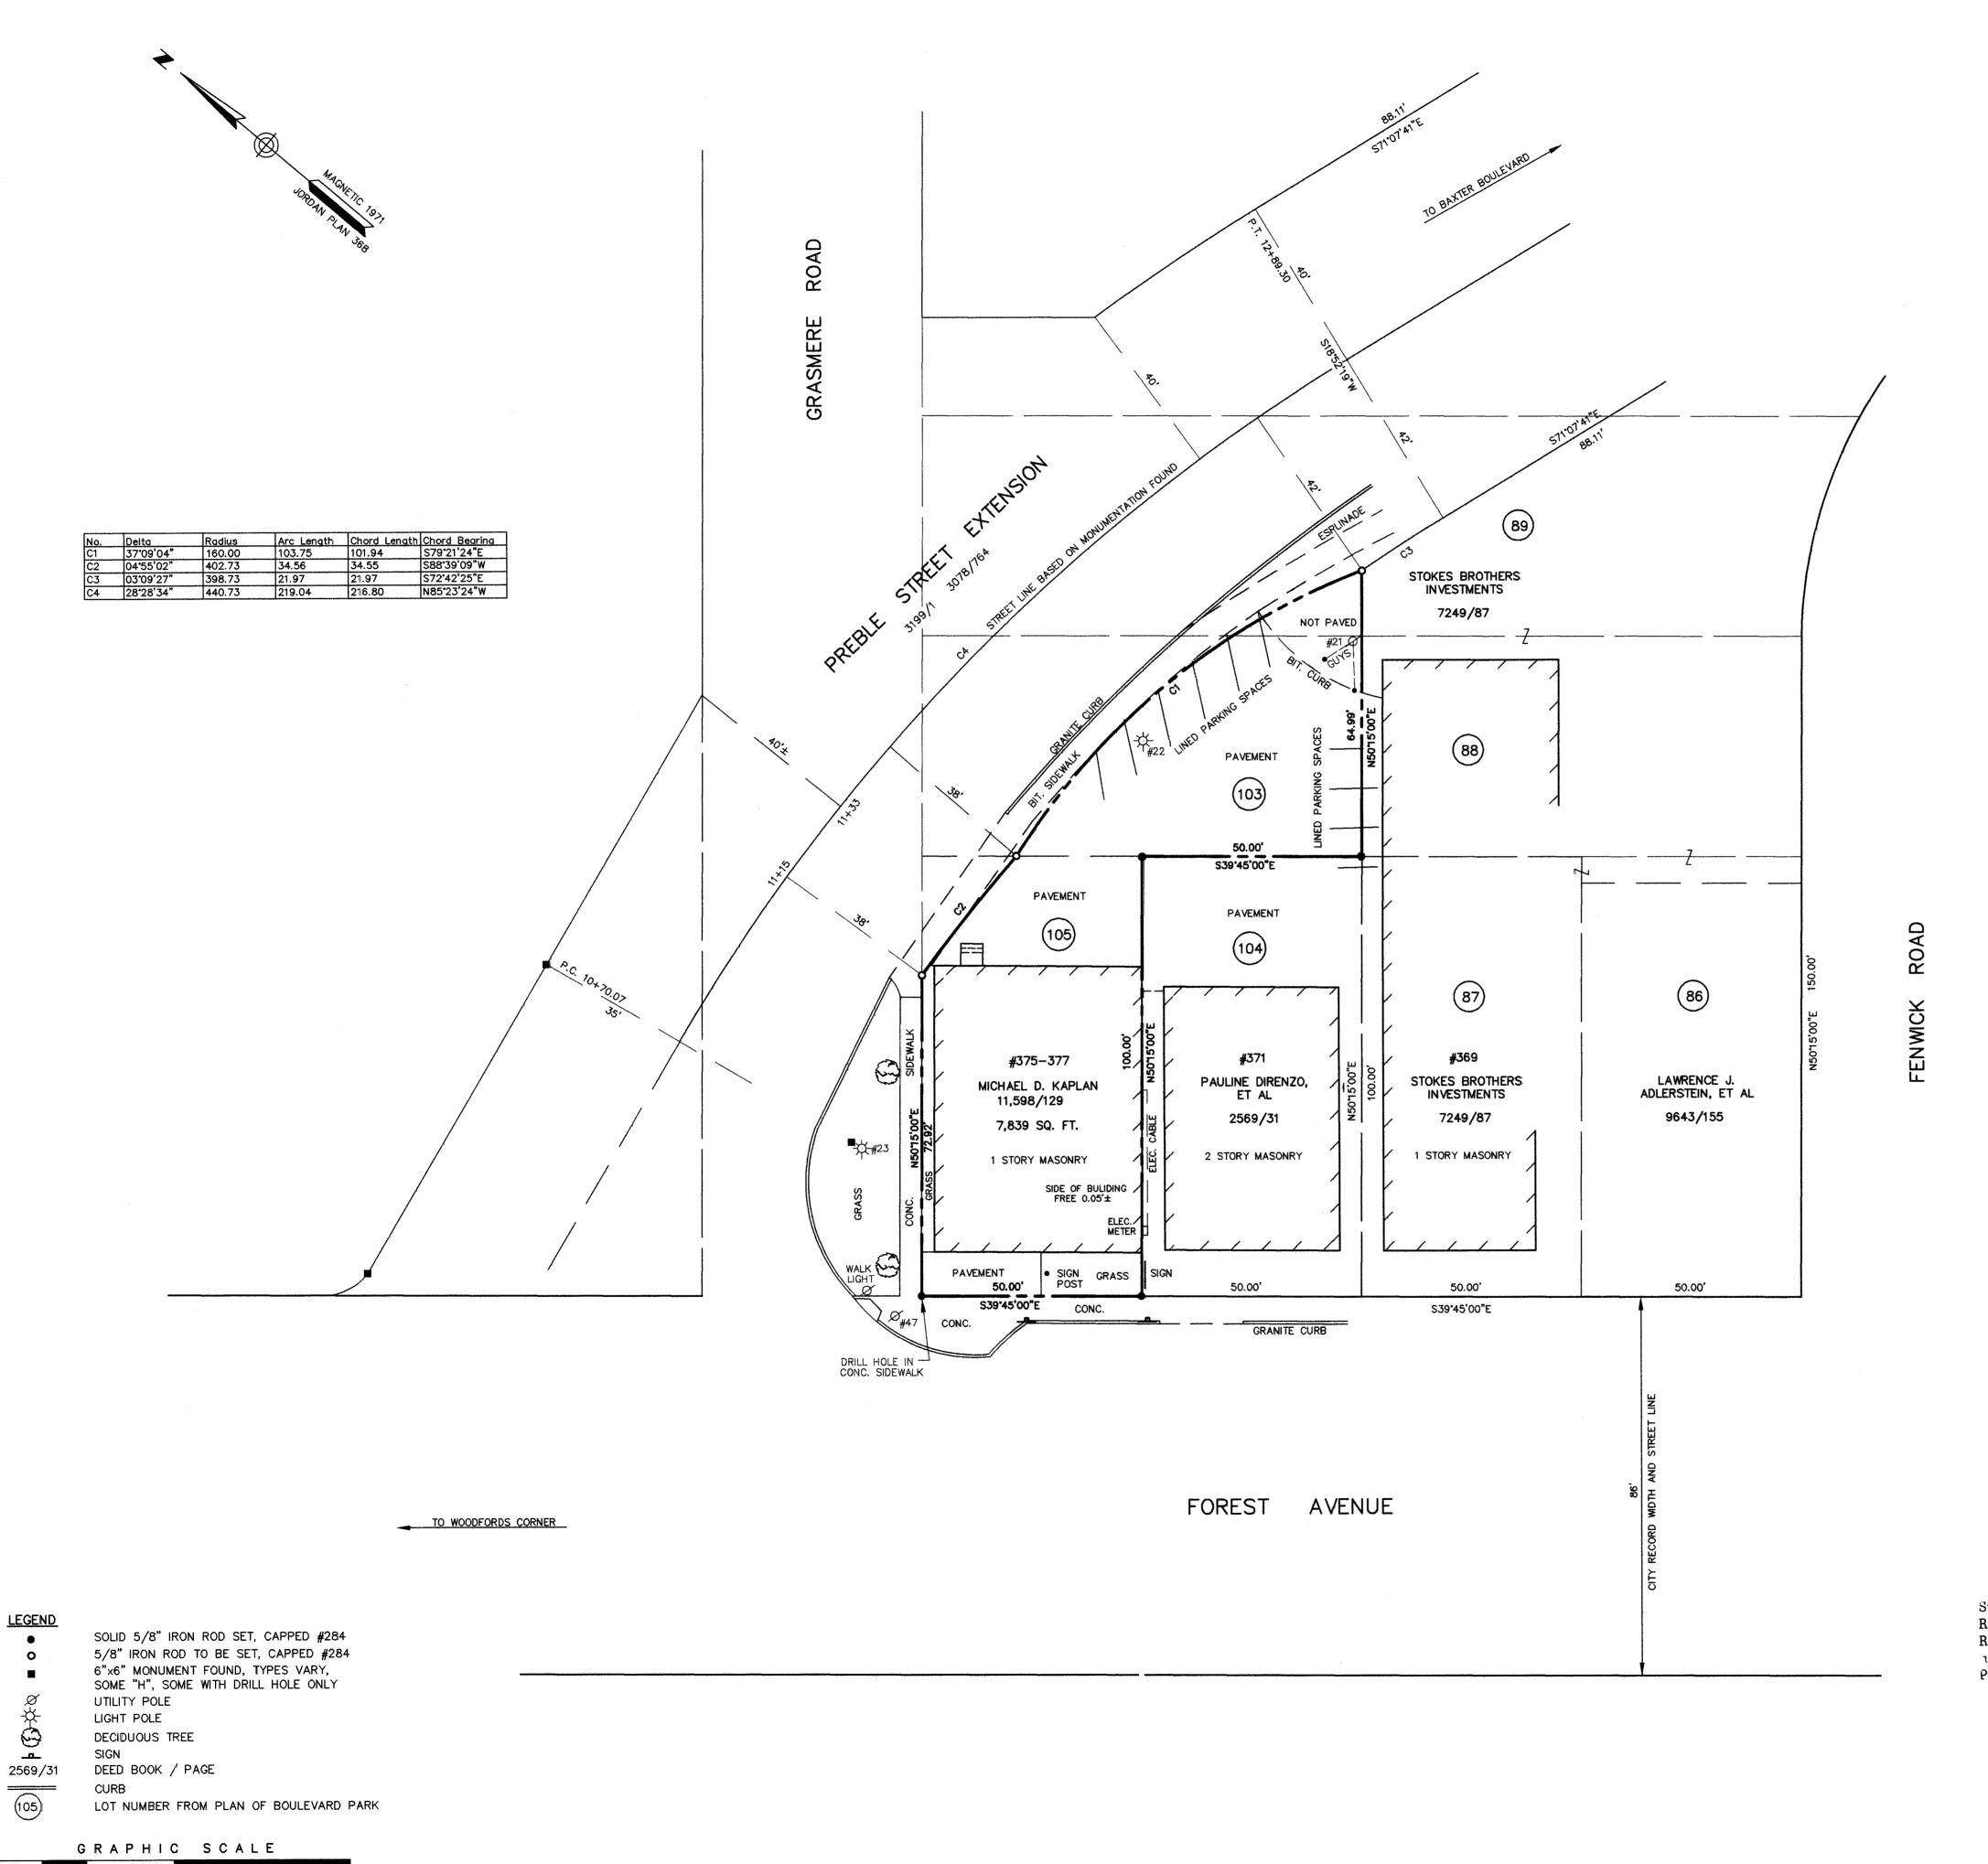

THIS IS NOT A SUBDIVISION

# SUN TIKI STUDIOS

375 FOREST AVENUE PORTLAND, MAINE

# DRAWING LIST

#### SHEET NUMBER

GO-O TITLE SHE

G1-0 GENERAL NOTES, ABBREVIATIONS, AND LEGENDS
G1-1 LIFE SAFETY PLAN

## ARCHITECTURAL

A1-0 FLOOR PLA

DETAILS



# CONSTRUCTION DRAWINGS

NOVEMBER 14, 2018

ARCHITECT

RYAN SENATORE ARCHITECTURE

565 CONGRESS STREET, SUITE 304, PORTLAND, MAINE 04101 207-650-6414

TO WORK WHICH WILL GENERATE EXCESSIVE NOISE AND

WITH EXISTING SMOKE DETECTORS, ALARMS OR BUILDING

CONSTRUCTION AND SUPPORT FACILITIES, AND SECURITY AND

PROTECTION AS NEEDED TO PROTECT NEW AND EXISTING

MODIFICATION TO UTILITIES. WORK MUST NOT INTERFERE

PROVIDE ALL TEMPORARY FACILITIES AND SERVICES.

CONSTRUCTION FOR THE DURATION OF A COMPLETE

EMPLOY EXPERIENCED WORKERS FOR FINAL CLEANING.

ALL MATERIALS & EQUIPMENT SHALL BE INSTALLED

ACCORDING TO MANUFACTURER'S SPECIFICATIONS.

COMMERCIAL BUILDING CLEANING PROGRAM.

LONGER PERIOD OF TIME ON A CERTAIN ITEM.

PROJECT, WHETHER BUILDING MATERIALS OR

26: MANUFACTURERS INSTRUCTIONS:

CLEAN EACH SURFACE TO THE CONDITION EXPECTED IN A

GUARANTEE: ALL MATERIALS AND WORKMANSHIP SHALL BE

FINAL ACCEPTANCE UNLESS OTHERWISE SPECIFIED FOR A

ALL MATERIAL USED FOR THE CONSTRUCTION OF THIS

APPURTENANCES, SHALL BE NON-ASBESTOS CONTAINING

THE GENERAL CONTRACTOR SHALL CONFIRM THAT ALL

OR INSTALLATION WILL NOT RELEASE FUMES OR AROMAS

DURING CONSTRUCTION WHICH MAY BE A HAZARD OR

MATERIAL AND FINISHES SPECIFIED AND THEIR FABRICATION

SEAL AND CAULK AROUND ALL PENETRATIONS, CRACKS AND

PLUMBING, ETC.) SHALL BE INSTALLED IN A WAY THAT DOES

MINIMUM OF 6" OFF FLOORS AND 1" OFF WALLS, CEILINGS AND

EQUIPMENT SUPPLIED BY THE OWNER AND INSTALLED BY THE

DOCUMENTATION PREPARATION. THE GENERAL CONTRACTOR

SHALL BE RESPONSIBLE FOR VERIFYING WITH THE OWNER THE

GENERAL CONTRACTOR SHALL MAKE ALL FINAL CONNECTIONS

WORKING ORDER, CHECK WARRANTIES, TEST AND NOT VOID

EXISTING SPRINKLERHEADS, ALARM SYSTEM AND DETECTORS

PLAN. COORDINATE WITH THE ARCHITECT, ANY MODIFICATION

CONTRACTOR IS RESPONSIBLE FOR COORDINATING QUANTITY

AND LOCATION OF ALL REQUIRED ACCESS PANELS FOR ALL

MEP CONTROLS, CLEANOUTS, DAMPERS, PULL BOXES, ETC.

ALL HAZARDOUS MATERIALS INCLUDING BUT NOT LIMITED TO

ENCAPSULATED, ABATED AND DISPOSED OF IN ACCORDANCE

ALL WORK SHALL BE PERFORMED IN ACCORDANCE WITH

AMERICAN CONCRETE INSTITUTE

AMERICAN WELDING SOCIETY

INDUSTRY STANDARDS. STANDARDS INCLUDE BUT ARE NOT

AMERICAN ARCHITECTURAL MANUFACTURERS

AMERICAN NATIONAL STANDARDS INSTITUTE

ARCHITECTURAL WOODWORK INSTITUTE

NAAMM NATIONAL ASSOCIATION OF ARCHITECTURAL METAL

WDMA WINDOW AND DOOR MANUFACTURERS ASSOCIATION

NATIONAL TILE CONTRACTORS ASSOCIATION

NRCA NATIONAL ROOFING CONTRACTORS ASSOCIATION

SMACNA SHEET METAL AND AIR CONDITIONING NATIONAL

AMERICAN SOCIETY FOR TESTS AND MATERIALS

INSULATING GLASS MANUFACTURERS ALLIANCE

OR LOCATIONS WHERE EXISTING SYSTEMS ARE AFFECTED BY

ARE TO BE MODIFIED TO CONFORM. WITH THE PROPOSED

REPORT THE LOCATION OF ALL UNSUITABLE SOILS AND MATERIALS BELOW ANTICIPATED LEVEL OF FOOTING TO THE

ARCHITECT PRIOR TO THE SETTING OF FORMS.

ASBESTOS AND LEAD PAINT ARE TO BE HANDLED.

WITH ANY AND ALL FEDERAL, STATE AND LOCAL

36: EXISTING HAZARDOUS MATERIALS

REQUIREMENTS AND REGULATIONS.

ASSOCATION

"CUSTOM GRADE"

MANUFACTURERS

ASSOCIATION

37: INDUSTRY STANDARDS:

LIMITED TO THE FOLLOWING:

AAMA

ACI

ANSI

NTCA

COORDINATE WITH THE OWNER DELIVERY, STORAGE AND

INSTALLATION OF ALL OWNER SUPPLIED EQUIPMENT. THE

GENERAL CONTRACTOR SHALL STORE EQUIPMENT IF

DRAWINGS FOR OTHER OWNER SUPPLIED/GENERAL

CONTRACTOR INSTALLED ITEMS.

33: FIRE PROTECTION NOTE:

THE NEW DESIGN.

34: SOILS AT FOOTINGS:

35: ACCESS PANELS:

REQUESTED BY THE OWNER UNTIL INSTALLATION. SEE

EQUIPMENT INFORMATION AND SPECIFICATIONS ARE TO BE

THE MOST CURRENT AVAILABLE AT THE TIME OF

EXACT DIMENSIONS AND EQUIPMENT CONNECTION

REQUIREMENTS) OF EQUIPMENT TO BE SUPPLIED. THE

AS NOTED ON THE DRAWINGS, INSTALL THE SET UP IN

WARRANTIES. THE GENERAL CONTRACTOR SHALL

REQUIREMENTS (INCLUDING ELECTRICAL CIRCUIT

NOT OBSTRUCT OR PREVENT THE CLEANING OF FLOORS,

WALLS, AND CEILING AREAS. THEY SHALL BE INSTALLED A

CREVICES AND ANY OPENINGS CAPABLE OF HARBORING

ALL EXPOSED UTILITY WIRES AND PIPES (ELECTRICAL,

GUARANTEED FOR A PERIOD OF ONE YEAR FROM THE DATE OF

SYSTEM MANAGEMENT.

INSTALLATION.

27: GUARANTEE:

MATERIAL.

29: HAZARDOUS FUMES:

NUISANCE TO PERSONNEL.

30: PEST CONTROL

INSECTS/RODENTS.

31. EXPOSED UTILITIES:

GENERAL CONTRACTOR:

32. OWNER SUPPLIED EQUIPMENT:

25: FINAL CLEANING:

24: TEMPORARY FACILITIES:

RELATED WORK WITHOUT A WRITTEN RESOLUTION CLARIFICATION FROM THE ARCHITECT THE CONTRACTOR AND HIS/HER SUBCONTRACTORS SHALL BE RESPONSIBLE FOR PROVIDING MATERIALS AND SYSTEMS SHOWN IN THE CONSTRUCTION DOCUMENTS REGARDLESS OF WHERE THE INFORMATION IS LOCATED. WHERE COMPONENTS OF A SYSTEM ARE INDICATED THE CONTRACTOR SHALL BE RESPONSIBLE FOR PROVIDING ALL LABOR AND MATERIALS NECESSARY TO COMPLETE THE SYSTEM.

4: DISCREPANCIES & CLARIFICATIONS: THIS PROJECT INVOLVES THE FIT-UP OF AN EXISTING BUILDING. EXISTING DIMENSIONS SHOWN ON THE DRAWINGS ARE BELIEVED TO BE ACCURATE, BUT CANNOT BE GUARANTEED, MEASURE AND VERIFY DIMENSIONS IN FIELD PRIOR TO FABRICATION AND CONSTRUCTION. IT IS THE RESPONSIBILITY OF THE CONTRACTOR TO BRING TO THE ARCHITECTS ATTENTION, IN WRITING, ANY DISCREPANCIES OR AMBIGUITIES IN THE DRAWINGS AND/OR SPECIFICATIONS. THE CONTRACTOR SHALL NOT PROCEED WITH RELATED WORK WITHOUT A WRITTEN RESOLUTION OR CLARIFICATION FROM THE ARCHITECT.

UNLESS INDICATED OTHERWISE, CENTER WALL FRAMING AND PARTITION FRAMING ON COLUMN LINES. FLOOR PLAN DIMENSIONS ARE TO FACE OF FRAMING, FACE OF CONCRETE, FACE OF CMU, OR FROM COLUMN CENTERLINES, UNLESS INDICATED OTHERWISE. DOORS AND WINDOWS ARE DIMENSIONED TO CENTERLINES UNLESS INDICATED OTHERWISE.

UNLESS INDICATED OTHERWISE, CENTER BUILDING ELEMENTS WITHIN OR BETWEEN OTHER BUILDING ELEMENTS WHEN CONDITIONS OR THE DRAWINGS INDICATE OR IMPLY THAT SUCH IS THE INTENT, WHETHER OR NOT DIMENSIONS ARE INCLUDED

WHERE CONDITIONS OR THE DRAWINGS INDICATE OR IMPLY THAT SYMMETRY IS INTENDED, INFORMATION PROVIDED AT ONE SIDE APPLIES EQUALLY TO BOTH SIDES, UNLESS CONDITIONS CLEARLY PRECLUDE SUCH APPLICATION.

8: ACCESSIBILITY: ALL HANDICAPPED ACCESSIBLE BATHROOMS, GRAB BARS, AND DOOR OPENINGS SHALL MEET THE REQUIREMENTS OF TITLE 94-348, CHAPTER 5 OF THE MAINE HUMAN RIGHTS COMMISION TITLE LATEST EDITION & THE DEPARTMENT OF JUSTICE ADA STANDARDS FOR ACCESSIBLE DESIGN.

10: WATER-RESISTANT GWB:

WORK FROM THE GIVEN DIMENSIONS ONLY. SCALE IS INDICATED ON THE DRAWINGS FOR CONVENIENCE ONLY. IT IS NOT INTENDED THAT INFORMATION BE DETERMINED BY SCALING THE DRAWINGS SINCE SOME ITEMS MAY NOT BE TO SCALE.

INSTALL WATER-RESISTANT GYPSUM WALL BOARD IN ALL REST ROOMS & TOILET ROOMS OR AT ANY WALL WITH PLUMBING FIXTURES. 10A: HIGH IMPACT GWB:

INSTALL HIGH IMPACT GYPSUM WALL BOARD IN ALL STAIRWELLS INTERIOR ELEVATIONS MAY BE REVERSED FROM AND/OR SIMILAR

TO ACTUAL CONDITIONS. SEE FLOOR PLANS FOR WINDOW AND DOOR QUANTITIES AND LOCATIONS, FOR CASEWORK LAYOUTS, AND FOR MONITOR LOCATIONS. 12: BUILDING INSULATION:

PROVIDE AS INDICATED IN WALL SECTIONS AND IN ACCORDANCE

WITH PARTITION TYPES, WHETHER OR NOT SHOWN IN DETAILS AND OTHER DRAWINGS. FOR CLARITY, INSULATION MAY NOT BE SHOWN IN SOME CASES, EVEN IF IT IS TO BE PROVIDED. 13: BLOCKING: INSTALL BLOCKING BEHIND ALL SURFACE-APPLIED FIXTURES TRIM, CASEWORK, SHELVES, BRACKETS, TOILET ACCESSORIES,

CHAIR RAILS, PICTURE RAILS, GRAB BARS, BASE MOLDINGS, AND AS OTHERWISE REQUIRED, WHEN SUCH ITEMS ARE APPLIED ON STUD WALLS. 14: PENETRATIONS AT STRUCTURAL MEMBERS:

BEFORE PENETRATING JOISTS, BEAMS OR OTHER STRUCTURAL MEMBERS, CONSULT WITH THE ARCHITECT.

15: DAMAGED WORK: BUILDING OR SITE COMPONENTS WHICH ARE AFFECTED BY NEW WORK, DEMOLITION, OR WHICH MAY BE DAMAGED BY THE GENERAL CONTRACTOR OR ANY SUB-CONTRACTOR SHALL BE REPLACED OR RESTORED TO ORIGINAL CONDITION AND COLOR TO MEET THE APPROVAL OF THE ARCHITECT.

16: UTILITIES: VERIFY THE SIZE AND LOCATION OF ALL UNDERGROUND UTILITIES AND REPORT ANY DISCREPANCIES TO THE ARCHITECT IN WRITING. DO NOT PROCEED WITH WORK UNTIL THE DISCREPANCY HAS BEEN RESOLVED TO THE SATISFACTION OF THE ARCHITECT.

17: RATED CONSTRUCTION: PROVIDE RATED CONSTRUCTION AS REQUIRED BY CODE, AS SPECIFIED, AND AS INDICATED ON DRAWINGS. IT IS THE RESPONSIBILITY OF THE CONTRACTOR TO PROVIDE AND INSTALL ALL COMPONENTS REQUIRED TO CREATE SUCH RATED CONSTRUCTION, REGARDLESS OF WHETHER OR NOT SUCH COMPONENTS ARE INDICATED. PROVIDE CONTINUITY OF SUCH RATED CONSTRUCTION AROUND AND BETWEEN SPACES, INCLUDING AT CHASES AND AT FLOORS, TO MAINTAIN COMPLETE SEPARATIONS, EVEN IF NOT SPECIFICALLY INDICATED.

18: SHOP DRAWINGS: SUBMIT SHOP DRAWINGS TO THE ARCHITECT FOR REVIEW PRIOR TO FABRICATIONS. SUBMITTALS REQUIRED INCLUDE, BUT ARE NOT LIMITED TO, SHOP DRAWINGS FOR ALL PREFABRICATED CONCRETE, STEEL, MILLWORK & SIGNAGE, SAMPLES OF ALL PROPOSED PAINTS, METALS, WALL COVERINGS, LAMINATES, SOLID SURFACE MATERIALS, CERAMIC TILE, AND HARDWARE. SUBMIT MANUFACTURERS' DATA FOR ALL LIGHTING SYSTEMS, AND HARDWARE.

**ABBREVIATIONS** ACOUSTICAL CEILING TILE AREA DRAIN AMERICANS WITH DISABILITIES ACT ACCESSIBILITY'S GUIDELINES ADAAG ADDENDUM ABOVE FINISHED FLOOR AIR-HANDLING UNIT ARCHITECT/ARCHITECTURAL ACOUSTIC WALL PANEL BASE BUILDING GENERAL CONTRACTOR BUILDING LINE BUILDING BLDG BLKG BSMT BTWN BO BLOCKING BASEMENT BETWEEN COURSE (MASONRY) CORNER GUARD COAT HOOK CONTROL JOINT ONCRETE MASONRY UNIT CLEAN OU CONCRETE CONNECT/CONNECTION CONSTRUCTION CONTINUOUS CORRIDOR CERAMIC TILE CABINET UNIT HEATER DRINKING FOUNTAIN DIMENSION DRY STAND PIPE EACH ELEVATION ECTRICAL NTRANCE QUAL QUIPMENT **EXPANSION** EXPANSION BOL EXPANSION JOINT EXTERIOR ETHYLENE PROPYLENE DIENE MONOMER R ELECTRIC WATER COOLER FLAT BAR FIRE EXTINGUISHER AND CABINET FLOOR DRAIN FIRE EXTINGUISHER FIRE EXTINGUISHER CABINET FIRE TREATED WOOD FACE OF BRICK FACE OF CONCRETE FACE OF STUDS FACE OF WALL FIRE SUPPRESSION SYSTEM FIBER REINFORCED GYPSUM FIN TUBE RADIATION FUME HOOD GALVANIZED GRAB BAR GROUND-FAULT INTERRUPTER GLASS/GLAZING/GLAZED GLUE-LAMINATED WOOD GYPSUM WALL BOARD **HANDICAP** HOLLOW METAL

DRAWING LEGEND

POROUS FILL

WOOD - ROUGH

GYPSUM BOARD

**CELLULOSE INSULATION** 

RIGID INSULATION

BATT INSULATION

LIN WD

EARTH

CONCRETE

CONCRETE MASONRY UNIT

RADIUS REFLECTED CEILING PLAN ROOF DRAIN REBAR REINFORCING BAR REFRIGERATOR REINFORCED REQUIRED RESILIENT ROUGH OPENING RIGHT OF WAY SCHEDULE SQUARE FEET SCHED SPECIFICATION STAINLESS STEEL SOUND TRANSMISSION CLASS STANDARD STOR STRUCT TORAGE STRUCTURE/STRUCTURAL SUSPENSION T&G **TONGUE&GROOVE** TOP OF DECK TOP OF STEEL TYPICAL TELEVISION HORIZONTAL HORSE POWER/HIGH POINT/HEAT PUMP TOP OF CONCRETE HOT WATER JNDERWRITERS LABORATORIES, INC. HEATING VENTILATION AIR CONDITIONING UV HVAC UNIT VENTILATOR INSIDE DIMENSION/INSIDE DIAMETER INCHES VINYL COMPOSITION TILE VERTICAL INFO INSUL INFORMATION VERIFY IN FIELD INSULATION WITHOUT

LABORATORY

LEAD COATED COPPER

MEDIUM-DENSITY OVERLAY

POUND

MASONRY

MATERIAL MAXIMUM

**MEMBRANE** 

**MEZZANINE** 

MOUNTED

MINIMIIM

NORTH

OPENING

OUNCE

CONTRACTOR

PLASTIC LAMINATE

PREFABRICATE

PAINTED PARTITION

PERFORATED

QUARRY TILE

RISER/RADIUS

WIDE FLANGE WORK POINT

**ROOM NAME** 

AND NUMBER

DOOR NUMBER

WINDOW NUMBER

REVISION NUMBER

FLOOR-CEILING TYPE

ROOF SYSTEM TYPE

FLOORING TYPE TRANSITION

QUARTER

**PBOIBC** 

PERF

MANUFACTURER

MISCELL ANEOUS

MARKER BOARD

NOT IN CONTACT

NOT TO SCALE

NOMINAL DIMENSION

OPPOSITE HAND ORIENTED STRAND BOARD

POUNDS PER SQUARE FOOT POUNDS PER SQUARE INCH

POLYVINYL CHLORIDE

PRESSURE TREATED

MASONRY OPENING

MEMB MET

FIRESTOPPING DETAILS OVERLAP STEEL COLLAR 1" MINIMUM STEEL COLLAR OUTSIDE DIAMETER/OUTSIDE DIMENSION SEALANT - SEE "SEALANT SCHEDULE" THIS SHEET FOR TYPE OF SEALANT - PROVIDE IN AND FILL ENTIRE DEPTH OF ANNULAR SPACE -3/4" PLYWOOD SUBFLOOR OR 5/8" GWB -MINERAL WOOL PACKING MATERIAL IF/AS PURCHASED BY OWNER INSTALLED BY PENETRATING ITEM SPECIFICATIONS 1/2" AND 3" PIPE; PROVIDE 4 TABS FOR 4" PIPE. LLC., OR EQUAL. **SEALANT SCHEDULE:** SYSTEM PIPES. FLOOR PLANS AND SECTIONS

- ELEVATION COMPASS LETTER

INTERIOR ELEVATION SYMBOL

SHEET WHERE ELEVATION LOCATED

SHEET WHERE SECTION LOCATED

ELEVATION NUMBER

SECTION NUMBER

PARTITION TYPE


1HR FIRE RATED WALL


2HR FIRE RATED WALL

PARTITION TYPE TAG

PARTITION HEIGHT DESIGNATION

SECTION MARK

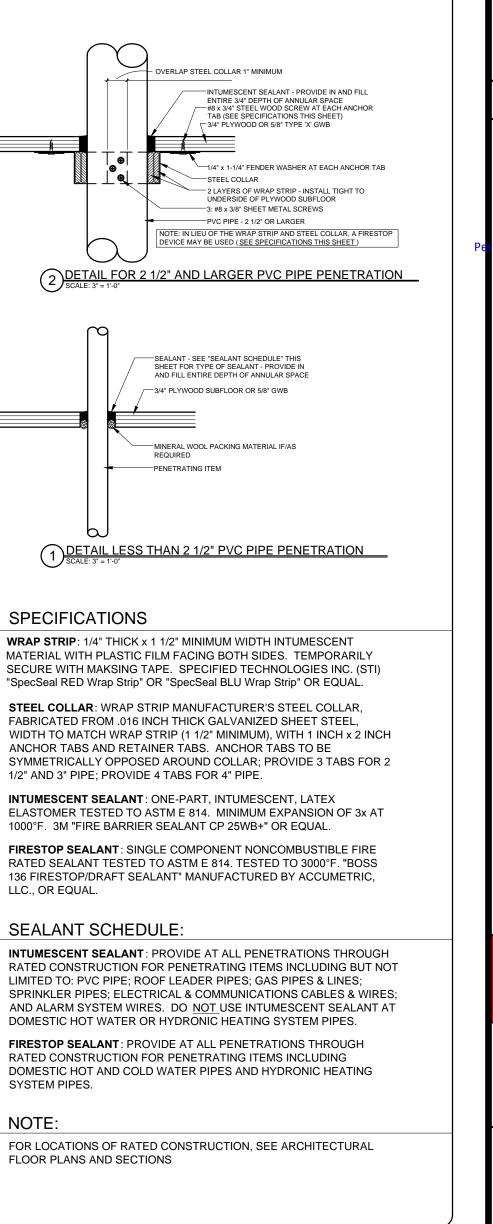

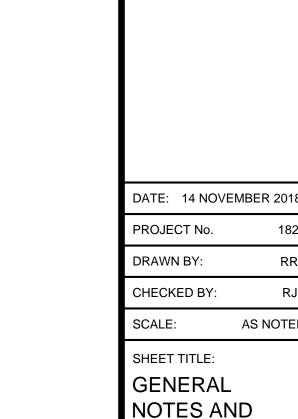

**ASSEMBLIES** 

AS NOTED

**SENATORE** No. 3322

2018 RYAN SENATOR

ARCHITECTURE

ections Dep

OR

OR

RYAN SENATORE

**ARCHITECTURE** 

565 CONGRESS STREET

PORTLAND, MAINE 04101

senatorearchitecture.com

207-650-6414

CONSULTANTS:


**REVISIONS:** 



EXIT SIGN FIRE EXTINGUSHER

INTERIOR FINISHES TO MEET CHAPTER 8 OF IBC 2015

AREA	INTERIOR SF	OCCUPANT LOAI
EVENT SPACE (A-2 ASSEMBLY USE)	302 SF	61 OCCUPANTS
STAGE (A-2 ASSEMBLY USE)	166 SF	12 OCCUPANTS
SEATING AREA (A-2 ASSEMBLY USE)	79 SF	6 OCCUPANTS
RECEPTION	N/A	1 OCCUPANT
STORAGE / UTILITY (BUSINESS USE)	173 SF	1 OCCUPANT
PRACTICE ROOMS (BUSINESS USE)	1,095 SF	11 OCCUPANTS

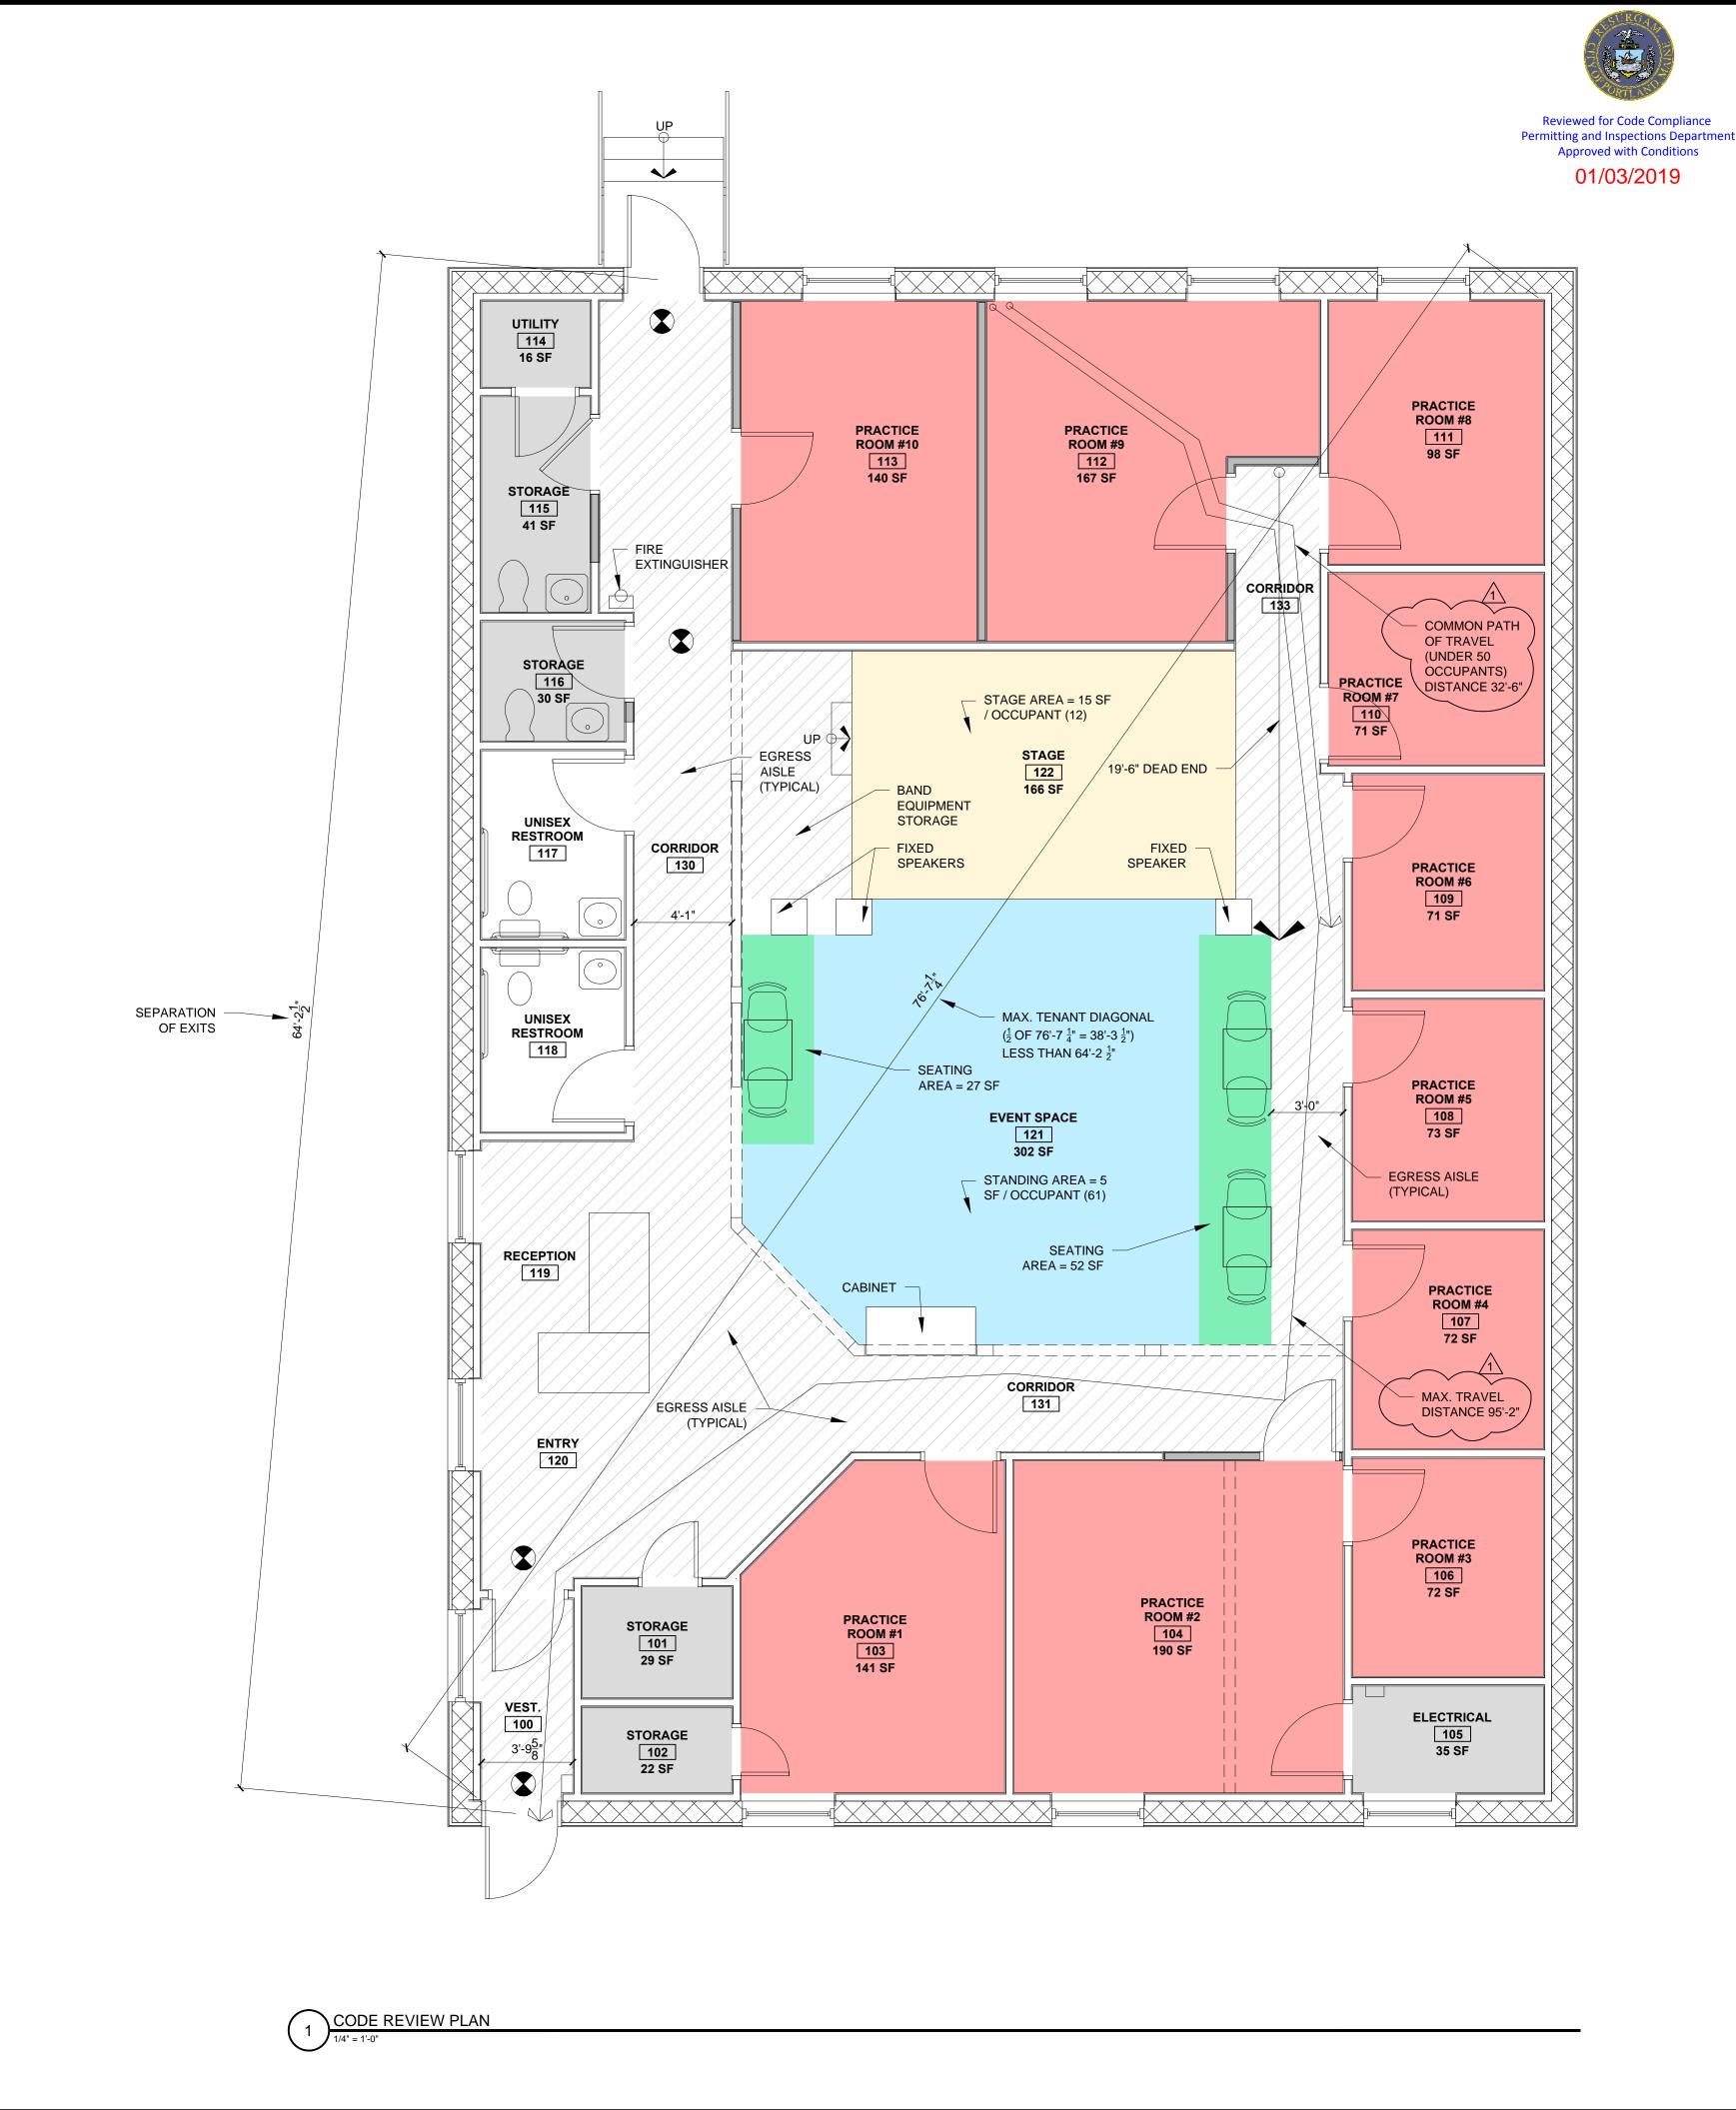



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AVENUE, MAINE PORTLAND, FORE

375

RYAN SENATORE ARCHITECTURE
565 CONGRESS STREET
PORTLAND, MAINE 04101
207-650-6414 senatorearchitecture.com

CONSULTANTS:

**REVISIONS:** 

1 REVISION - 12 / 13 / 18


DATE: 14 NOVEMBER 2018 PROJECT No. DRAWN BY:


CHECKED BY: SCALE: AS NOTED


SHEET TITLE:

CODE REVIEW PLAN

G1-1

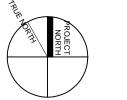

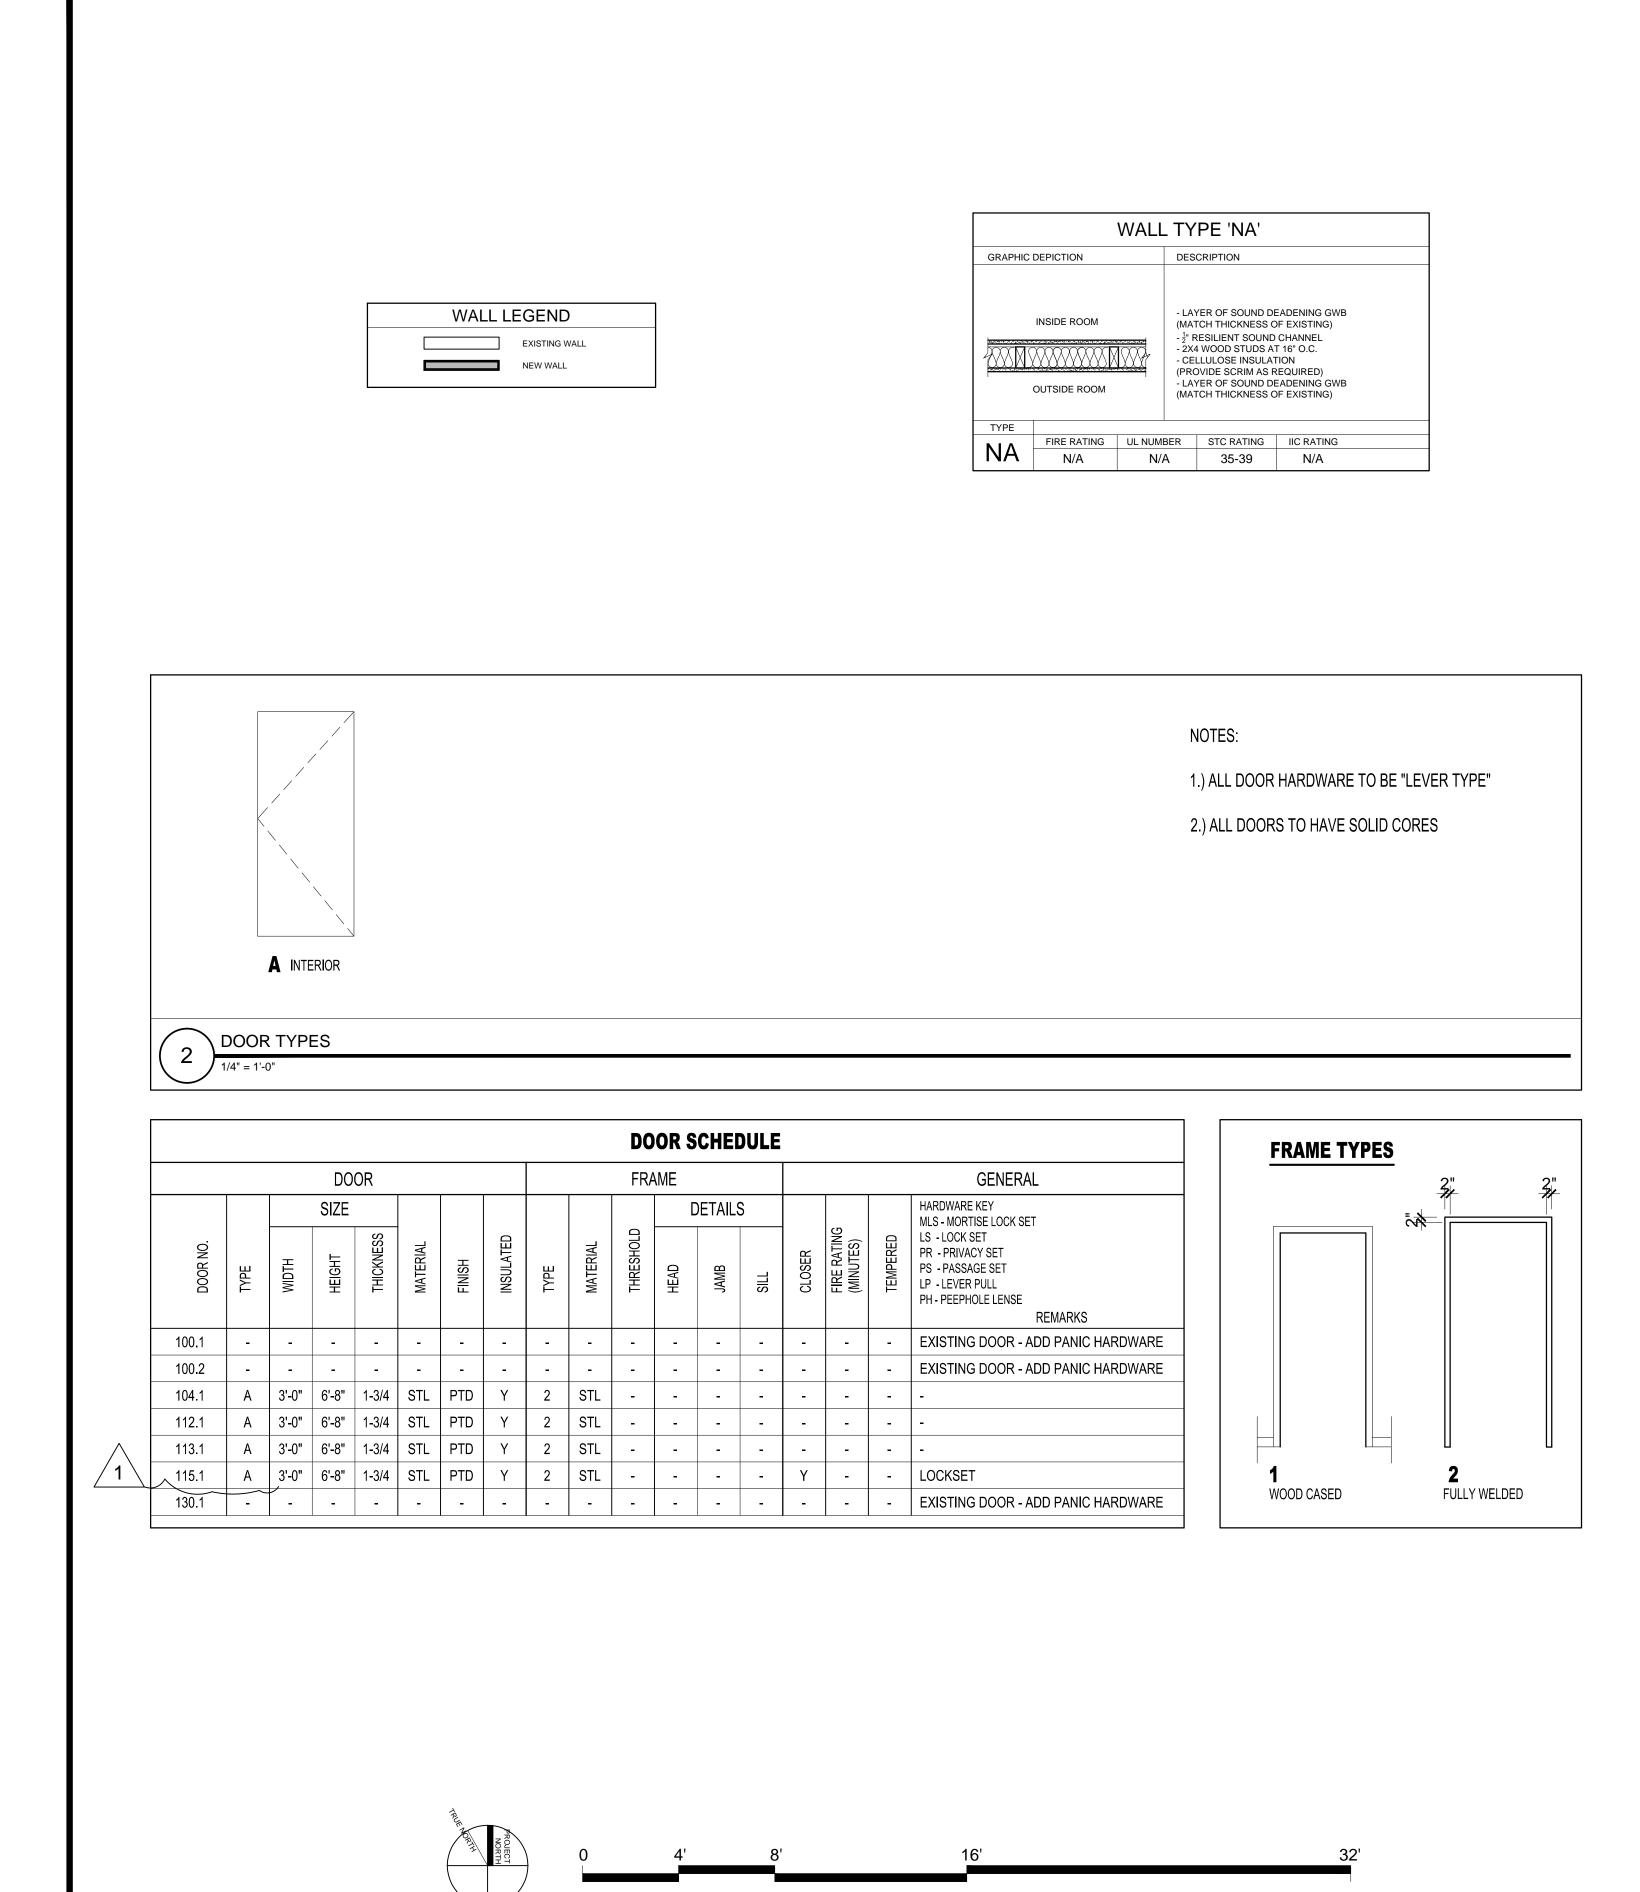

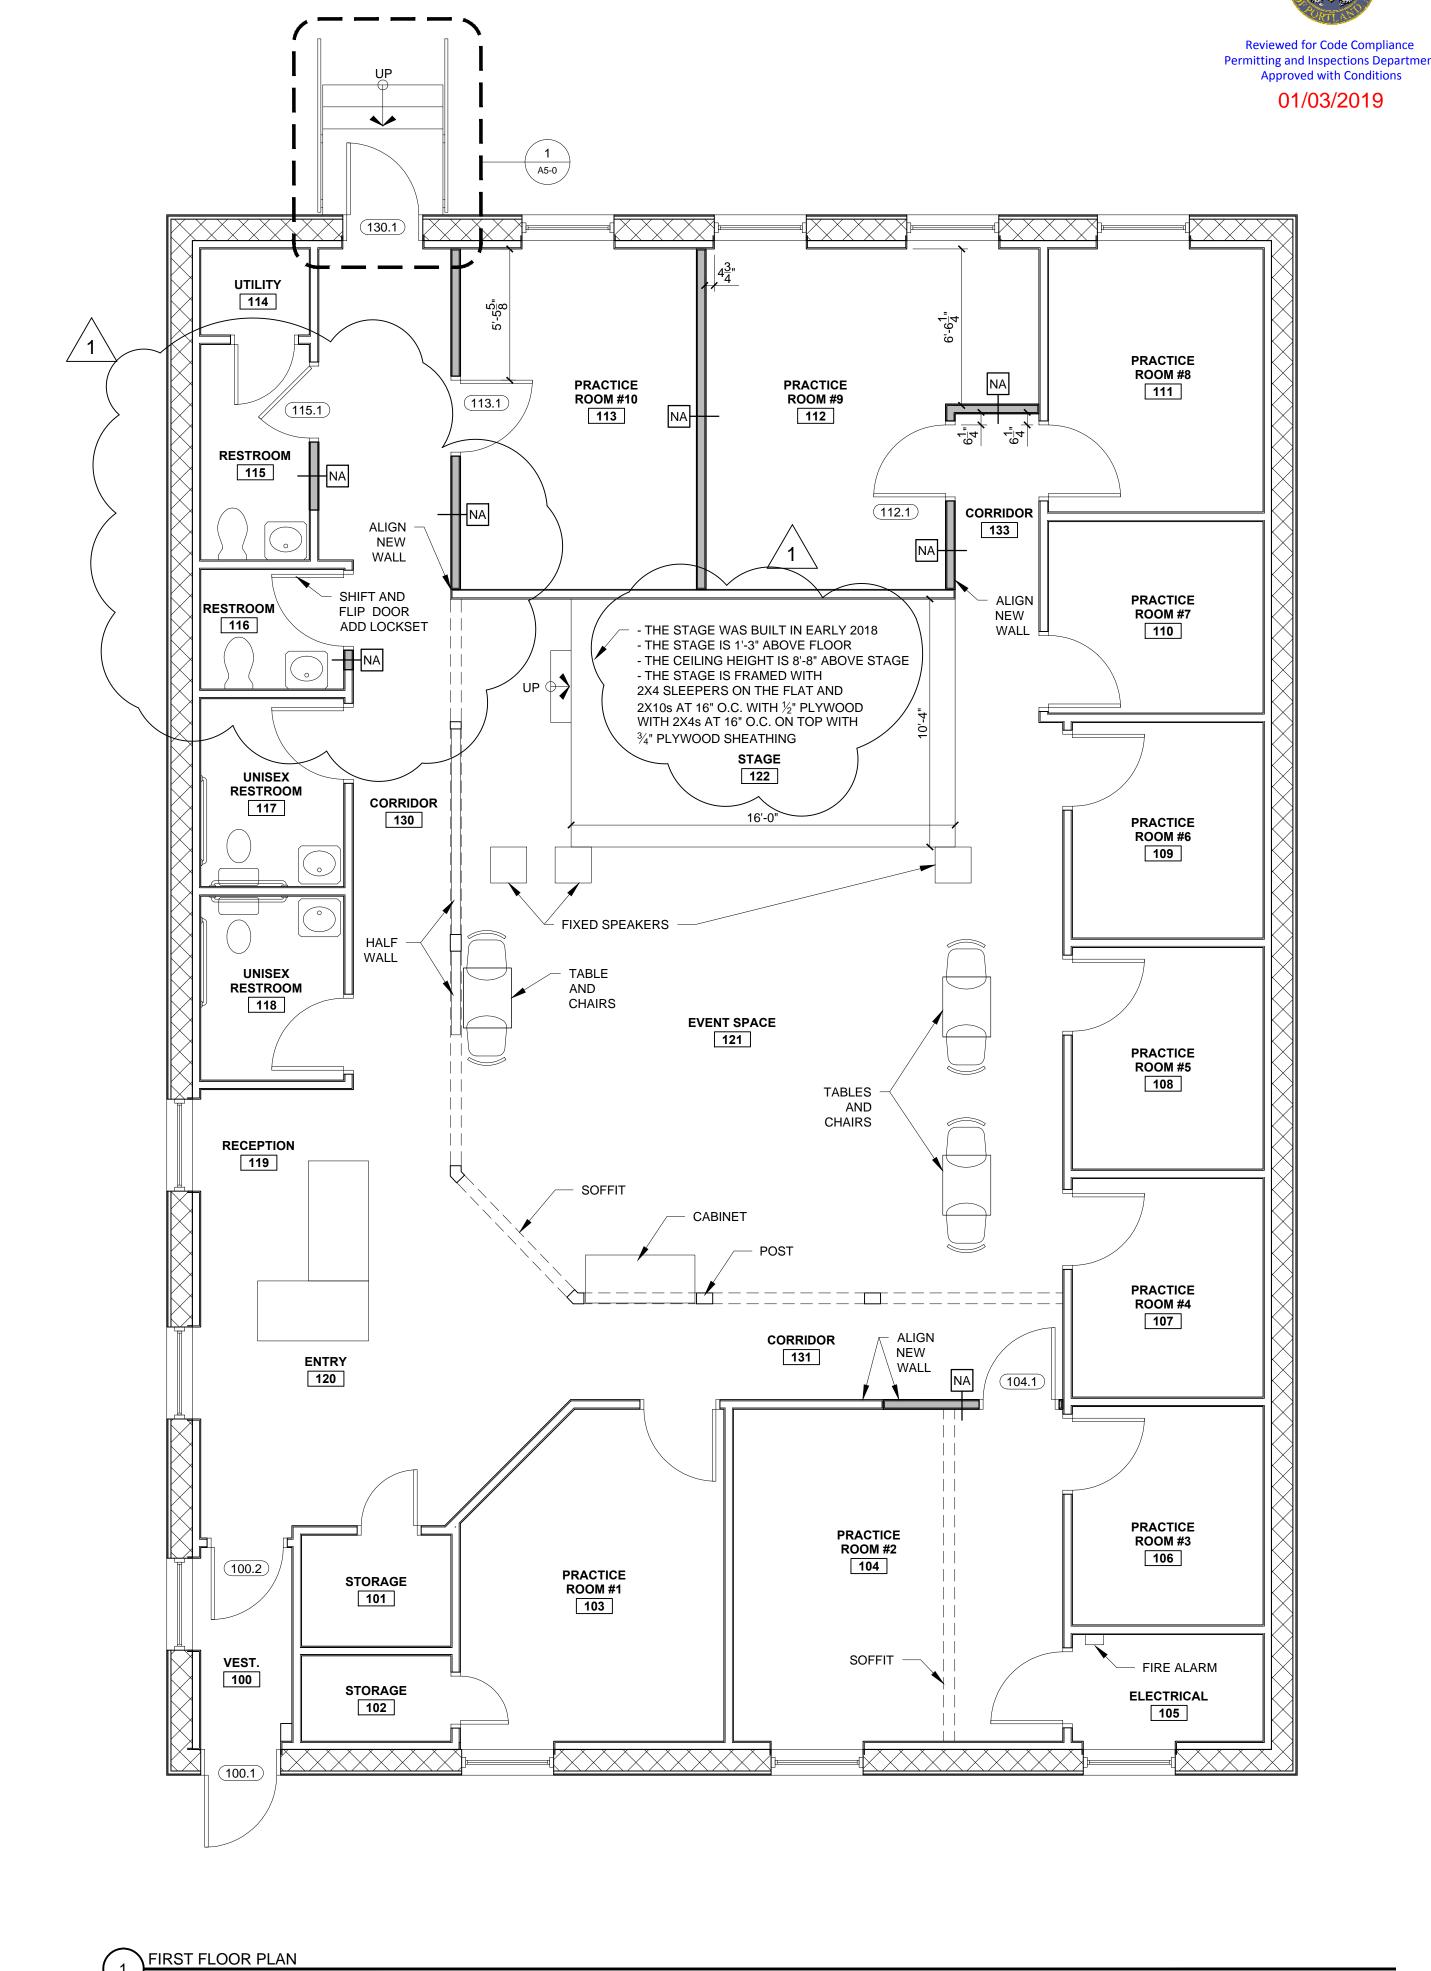

SENATORE No. 3322

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> AVENUE , MAINE

PORTLAND

RYAN SENATORE

ARCHITECTURE 565 CONGRESS STREET

PORTLAND, MAINE 04101

207-650-6414

senatorearchitecture.com

1 REVISION - 12/13/18

DATE: 14 NOVEMBER 2018

AS NOTED

DRAWN BY:

SCALE:

CHECKED BY:

SHEET TITLE:

FLOOR PLAN

CONSULTANTS:

**REVISIONS:** 





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AVENUE , MAINE

RYAN SENATORE ARCHITECTURE
565 CONGRESS STREET
PORTLAND, MAINE 04101
207-650-6414 senatorearchitecture.com

CONSULTANTS:

REVISIONS:

DATE: 14 NOVEMBER 2018 DRAWN BY: CHECKED BY:

AS NOTED SCALE:

SHEET TITLE: DETAILS

